

NSF WINDOWS ON THE UNIVERSE CENTER FOR ASTRONOMY OUTREACH KITTE PEAK NATIONAL OBSERVATORY

CENTER FOR ASTRONOMY OUTREACH REDESIGN
ISSUED FOR CONSTRUCTION
JANUARY 08, 2021

DRAWING SHEET INDEX

SHEET	NAME
GENERAL	
1.	CVR COVER SHEET
2.	G0.0 GENERAL INFORMATION
3.	G0.1 GENERAL SPECIFICATIONS
4.	G1.0 EGRESS PLAN
5.	G2.0 ARCHITECTURAL COMPOSITE PLAN
ARCHITECTURAL	
6.	A0.0 ARCHITECTURAL SITE PLAN
7.	AD1.1 ARCHITECTURAL DEMOLITION FLOOR PLAN - AREA A
8.	AD1.2 ARCHITECTURAL DEMOLITION FLOOR PLAN - AREA B
9.	AD1.3 ARCHITECTURAL DEMOLITION FLOOR PLAN - AREA C
10.	AD2.1 ARCHITECTURAL DEMOLITION RCP - AREA A
11.	AD2.2 ARCHITECTURAL DEMOLITION RCP - AREA B
12.	AD2.3 ARCHITECTURAL DEMOLITION RCP - AREA C
13.	A1.1 ARCHITECTURAL RENOVATION FLOOR PLAN - AREA A
14.	A1.2 ARCHITECTURAL RENOVATION FLOOR PLAN - AREA B
15.	A1.3 ARCHITECTURAL RENOVATION FLOOR PLAN - AREA C
16.	A2.1 ARCHITECTURAL RENOVATION CEILING PLAN - AREA A
17.	A2.2 ARCHITECTURAL RENOVATION CEILING PLAN - AREA B
18.	A2.3 ARCHITECTURAL RENOVATION CEILING PLAN - AREA C
19.	A2.4 ENLARGED RENO ROOF - AREA A
20.	A2.5 ENLARGED RENO ROOF - AREA B
21.	A2.6 ENLARGED RENO ROOF - AREA C
22.	A3.1 ARCHITECTURAL BUILDING SECTIONS & ELEVATION
23.	A3.2 ARCHITECTURAL BUILDING SECTION
24.	A4.1 ARCHITECTURAL SCHEDULES AND DETAILS
25.	A4.2 ARCHITECTURAL WALL TYPES & DETAILS
26.	A4.3 ARCHITECTURAL RESTROOM PLANS AND ELEVATIONS
27.	A4.4 ARCHITECTURAL RAMP AND STAIR DETAILS
STRUCTURAL	
28.	S1.0 GENERAL STRUCTURAL NOTES
29.	S1.1 G.S.N. S.I.T. AND TYPICAL DETAILS
30.	S2.0 PLAN AND SECTION
MECHANICAL	
31.	M0.0 MECHANICAL SYMBOLS AND ABBREVIATIONS
32.	M0.1 MECHANICAL OVERALL PLAN
33.	MD1.1 MECHANICAL HVAC DEMOLITION PLANS
34.	MD3.1 MECHANICAL PLUMBING DEMOLITION PLANS
35.	M1.1 MECHANICAL HVAC RENOVATION PLANS
36.	M1.2 MECHANICAL HVAC RENOVATION PLANS
37.	M1.3 MECHANICAL HVAC RENOVATION PLANS
38.	M1.4 MECHANICAL HVAC RENOVATION PLANS
39.	M2.1 MECHANICAL PIPING RENOVATION PLANS
40.	M2.2 MECHANICAL PIPING RENOVATION PLANS
41.	M2.3 MECHANICAL PIPING RENOVATION PLANS
42.	M3.1 MECHANICAL PLUMBING RENOVATION PLANS
43.	M3.2 MECHANICAL PLUMBING RENOVATION PLANS
44.	M3.3 MECHANICAL PLUMBING RENOVATION PLANS
45.	M3.4 MECHANICAL PLUMBING RENOVATION PLANS
46.	M3.5 MECHANICAL PLUMBING RENOVATION PLANS
47.	M3.6 MECHANICAL PLUMBING RENOVATION PLANS
48.	M5.1 MECHANICAL SECTIONS
49.	M6.1 MECHANICAL DETAILS
50.	M7.1 MECHANICAL P&ID'S
51.	M8.1 MECHANICAL RISER DIAGRAMS
52.	M9.1 MECHANICAL SCHEDULES AND SPECIFICATIONS
53.	M9.2 MECHANICAL SPECIFICATIONS
54.	M9.3 MECHANICAL SPECIFICATIONS
55.	M9.4 MECHANICAL SPECIFICATIONS
56.	M9.5 MECHANICAL SPECIFICATIONS
57.	M9.6 MECHANICAL SPECIFICATIONS
58.	M9.7 MECHANICAL SPECIFICATIONS
ELECTRICAL	
59.	E0.0 ELECTRICAL SYMBOLS AND ABBREVIATIONS
60.	E0.1 ELECTRICAL OVERALL & UNDERGROUND FEEDER PLAN
61.	ED1.1 ELECTRICAL LIGHTING DEMOLITION PLANS
62.	ED2.1 ELECTRICAL POWER DEMOLITION PLANS
63.	ED3.1 ELECTRICAL SYSTEMS DEMOLITION PLANS
64.	E1.1 ELECTRICAL LIGHTING RENOVATION PLANS
65.	E2.1 ELECTRICAL POWER RENOVATION PLANS
66.	E3.1 ELECTRICAL SYSTEMS RENOVATION PLANS
67.	E4.1 ELECTRICAL HVAC POWER RENOVATION PLANS
68.	E6.0 ELECTRICAL SCHEDULES
69.	E6.1 ELECTRICAL SCHEDULES
70.	E6.2 ELECTRICAL SCHEDULES
71.	E7.0 ELECTRICAL DIAGRAMS

DESCRIPTION

RENOVATION OF EXISTING OFFICE SPACE INTO EDUCATIONAL SPACES THROUGH EXHIBITS, GALLERIES AND VISUALIZATION SYSTEMS. INCLUDES ARCHITECTURAL, STRUCTURAL, MECHANICAL AND ELECTRICAL WORK.

APPLIED CODES:

CONTRACTOR TO ADHERE TO THE CODES AND REGULATIONS NOTED BELOW, INCLUDING BUT NOT LIMITED TO:


- 2018 INTERNATIONAL BUILDING CODE (IBC)
- 2018 INTERNATIONAL MECHANICAL CODE (IMC)
- 2018 INTERNATIONAL PLUMBING CODE (IPC)
- 2018 INTERNATIONAL ENERGY CONSERVATION CODE (IECC)
- 2018 INTERNATIONAL FIRE CODE (IFC)
- 2018 INTERNATIONAL FUEL GAS CODE (IFGC)
- 2017 NATIONAL ELECTRICAL CODE (NEC)
- 2010 ADA STANDARDS FOR ACCESSIBLE DESIGN

BID ALTERNATES:


- PROVIDE BID ALTERNATE PRICING FOR REMOVAL OF EARTH WORK FOR A NEW WATERPROOF MEMBRANE. REFER TO SHEET A2.5 FOR MORE INFO.

PROJECT LOCATION

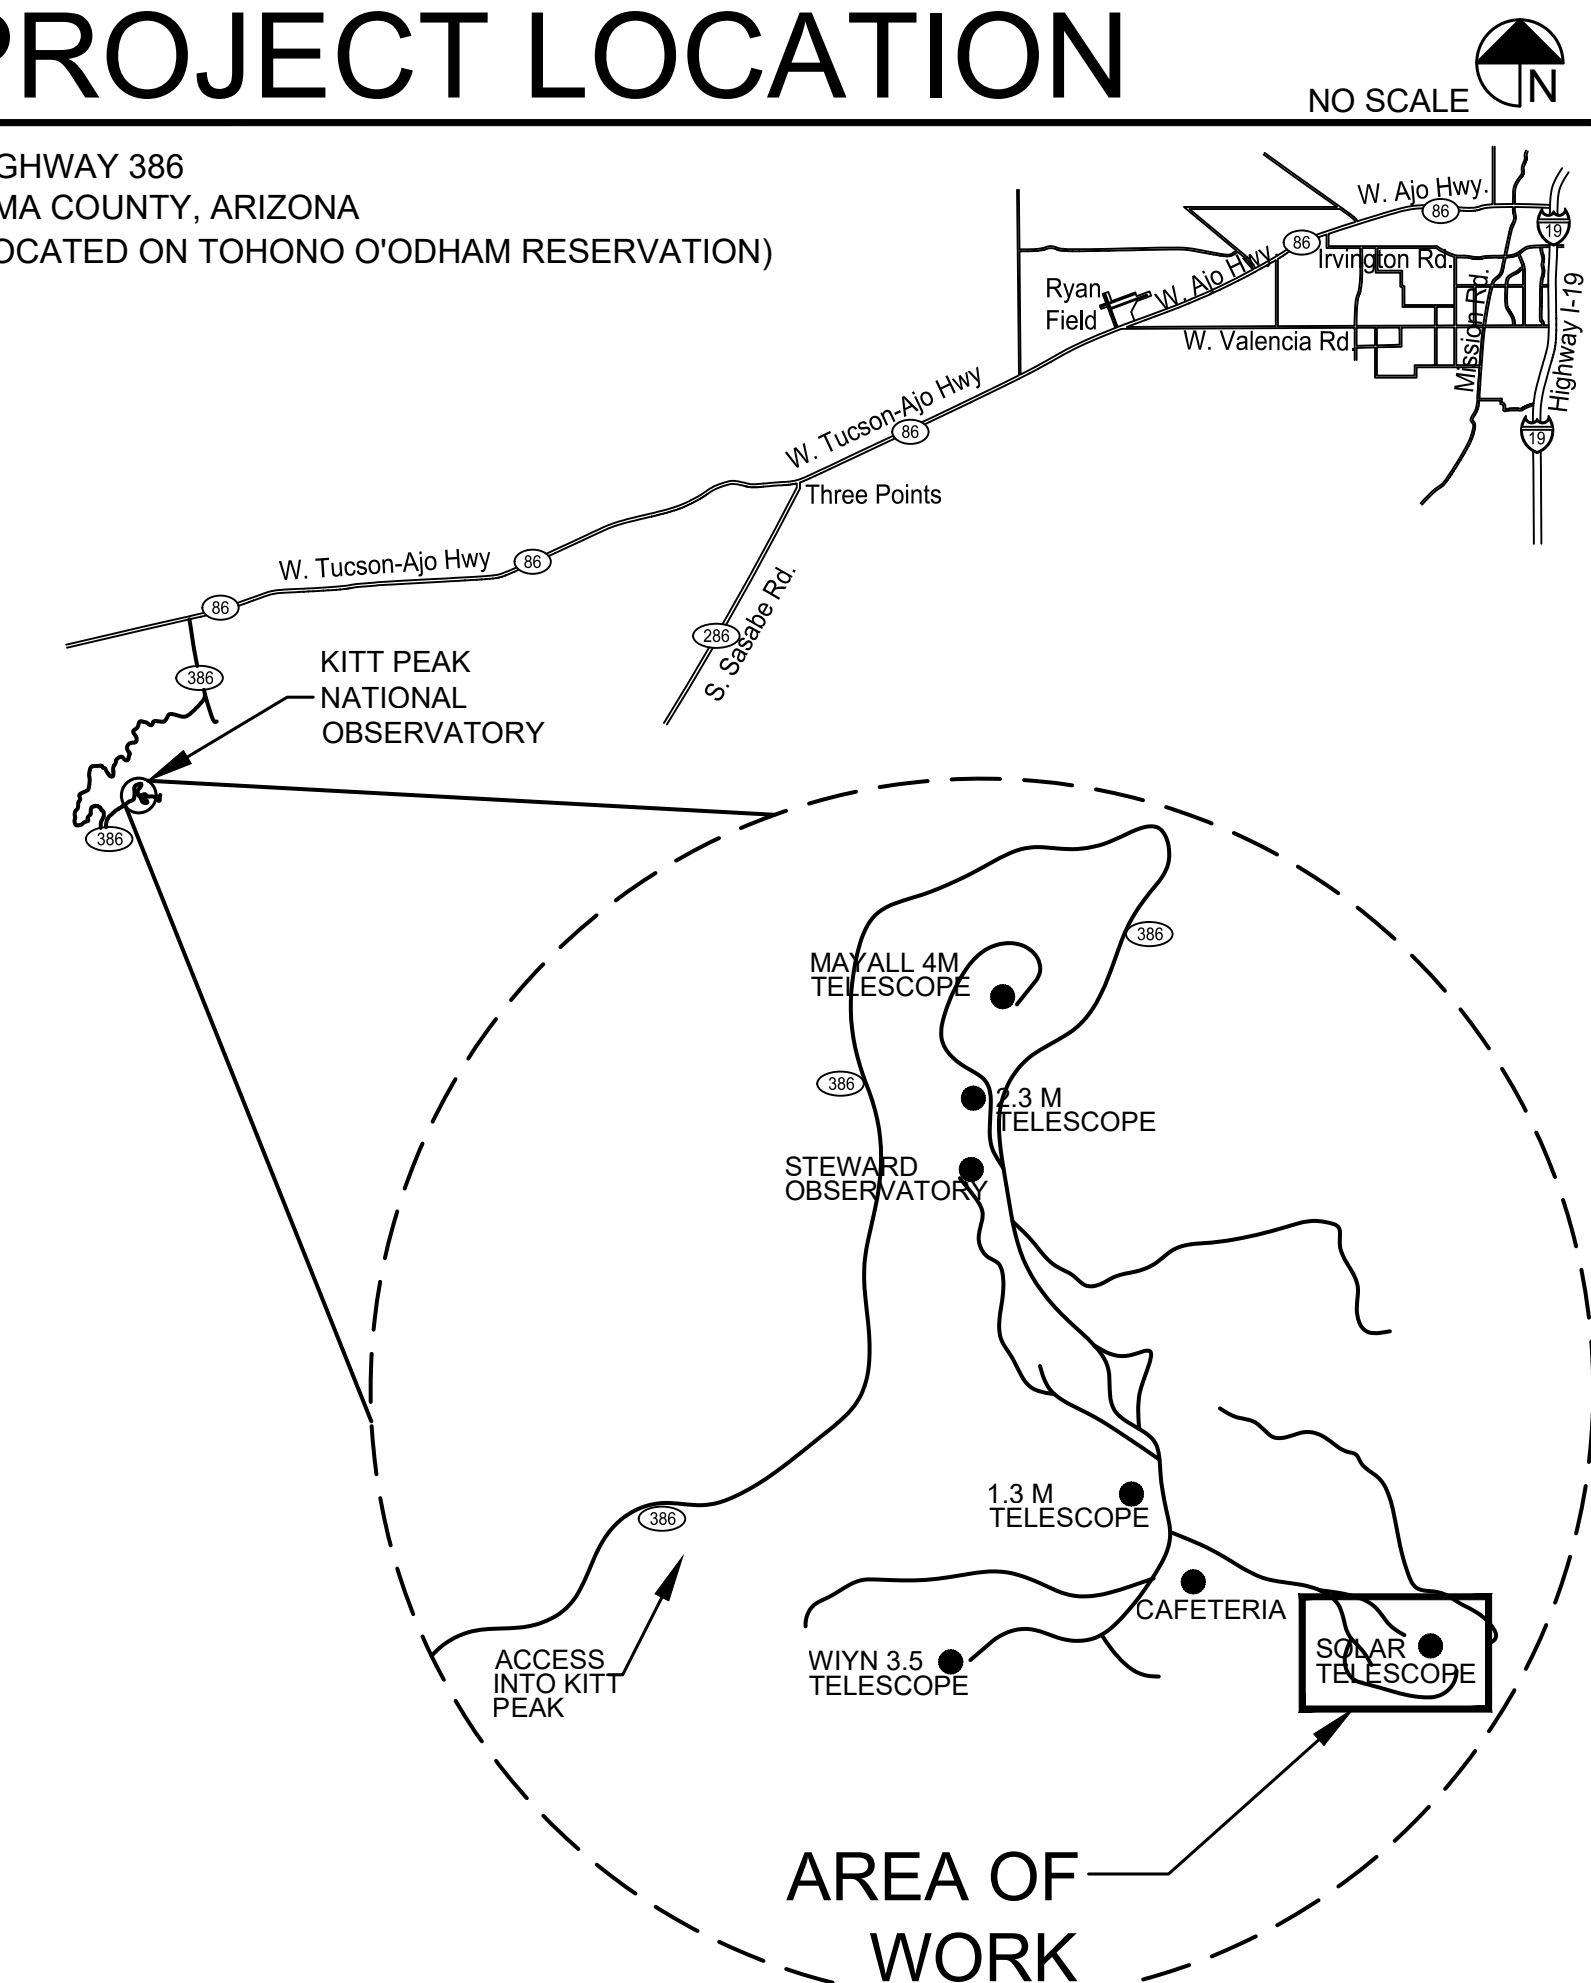HIGHWAY 386
PIMA COUNTY, ARIZONA
(LOCATED ON TOHONO O'ODHAM RESERVATION)



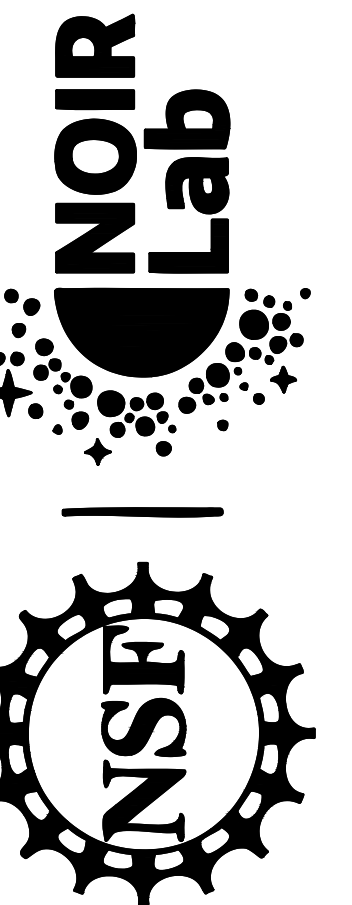WINDOWS ON
THE UNIVERSE
CENTER FOR
ASTRONOMY
OUTREACH



KITTE PEAK - Sells, AZ 85634

DATE	DESCRIPTION
01/08/21	I.F.C.

PROJECT NUMBER: 11904.00
DRAWN BY: AO
CHECKED BY: AO
CAD FILE: 11904.00-CVR
SCALE: AS NOTED



COVER SHEET

CVR

ABBREVIATIONS


Table of abbreviations for various construction materials and components, including symbols like @, A/C, AB, ABC, ABV, etc., and their corresponding full names.

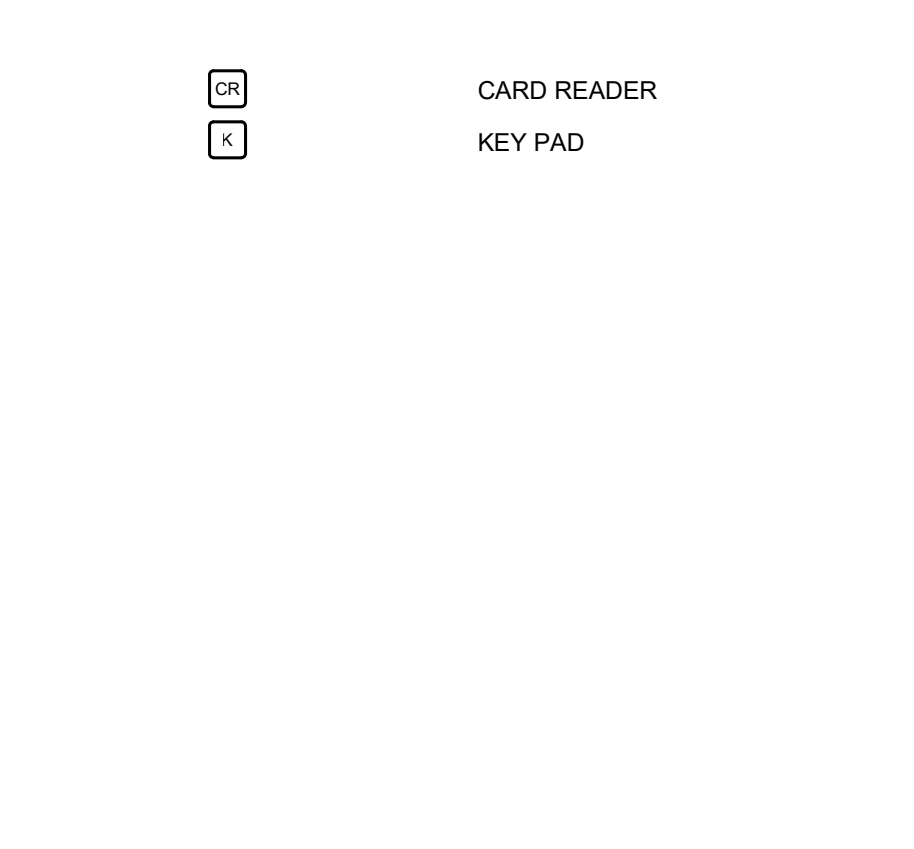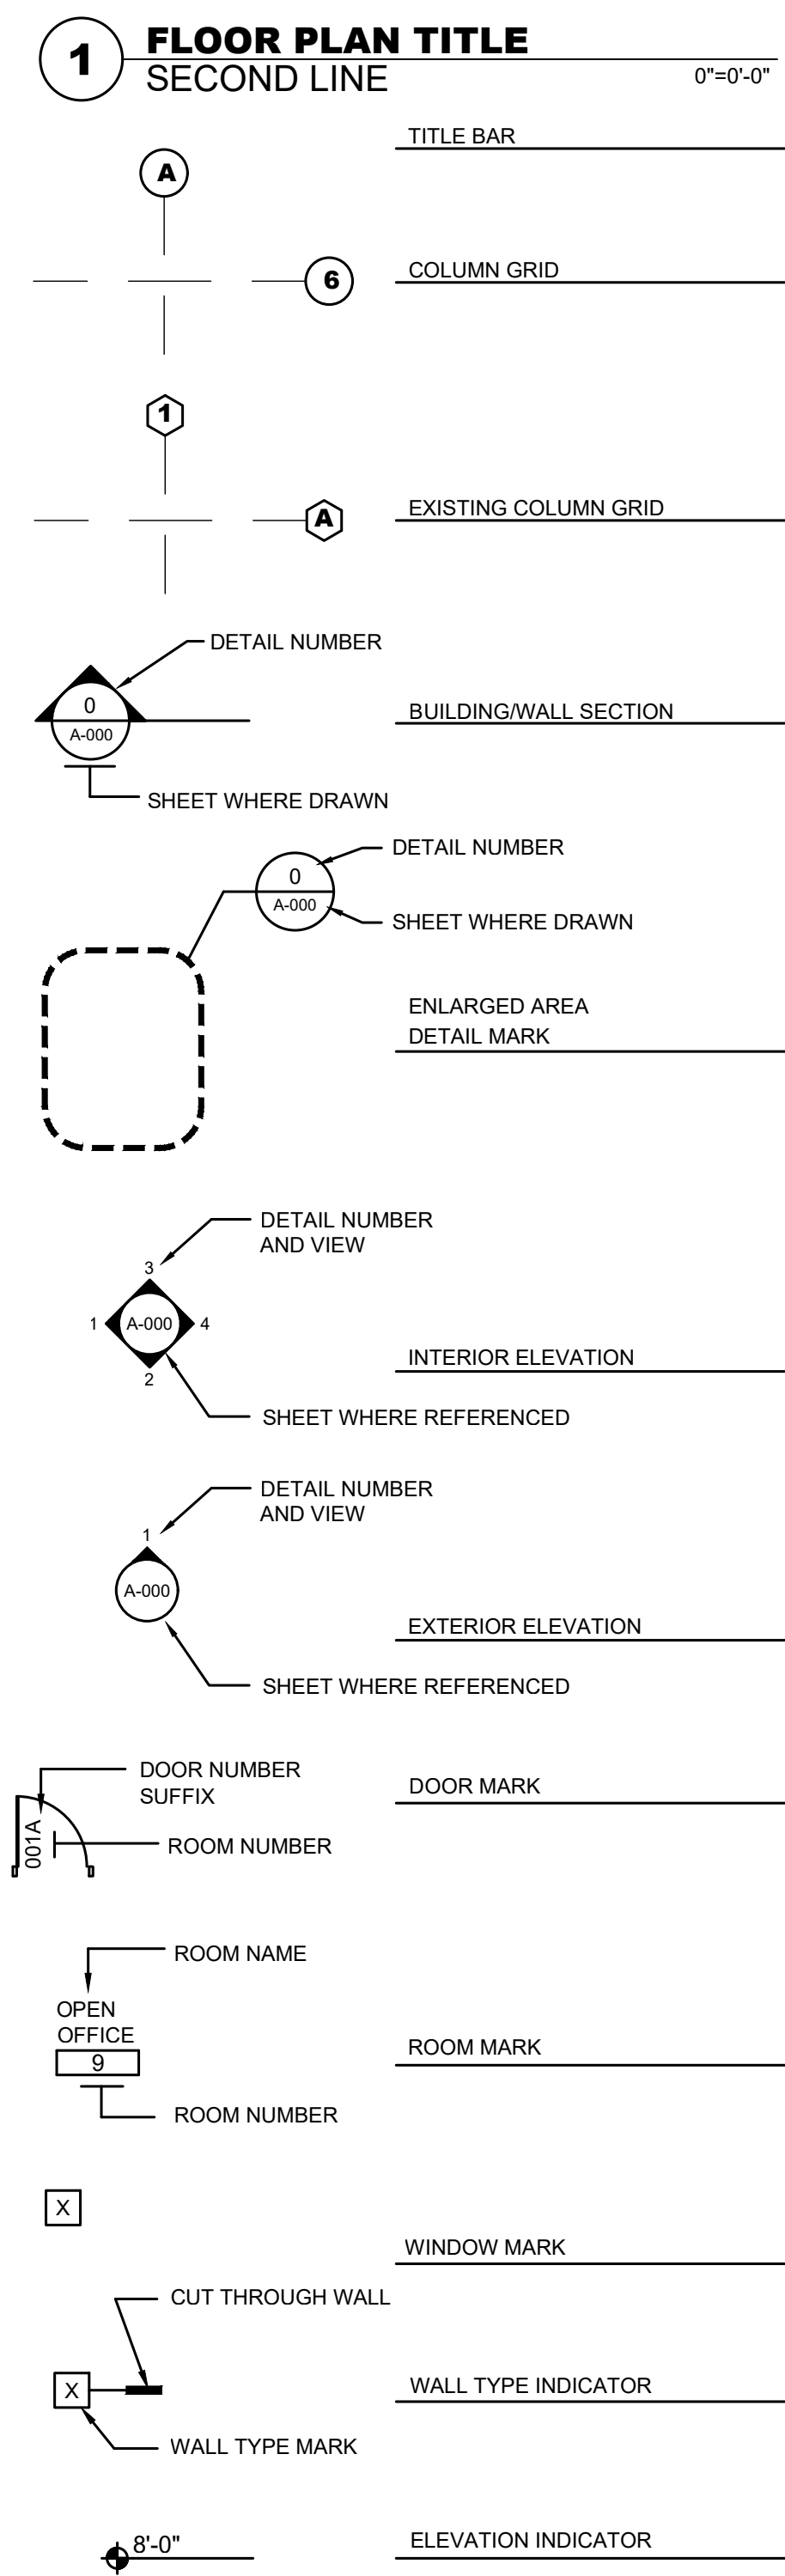SYMBOLS




GENERAL INFORMATION

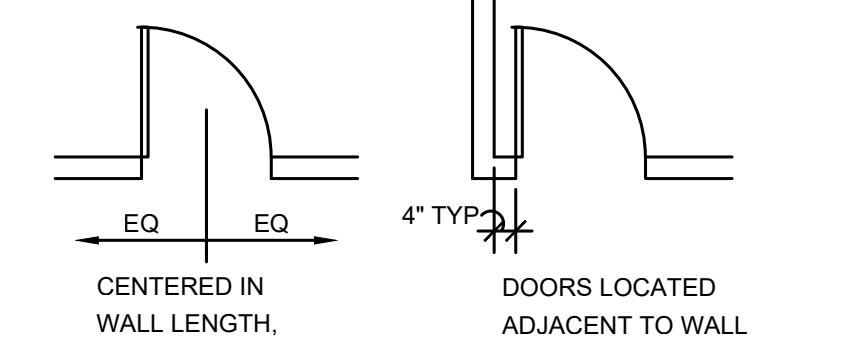- 1. FINISH FLOOR ELEVATIONS:
2. DIMENSIONS:
3. FIRE RATINGS:
4. VERIFY IN FIELD:
5. ACCESS DOORS:
6. CEILINGS:
7. DOORS:



MATERIALS

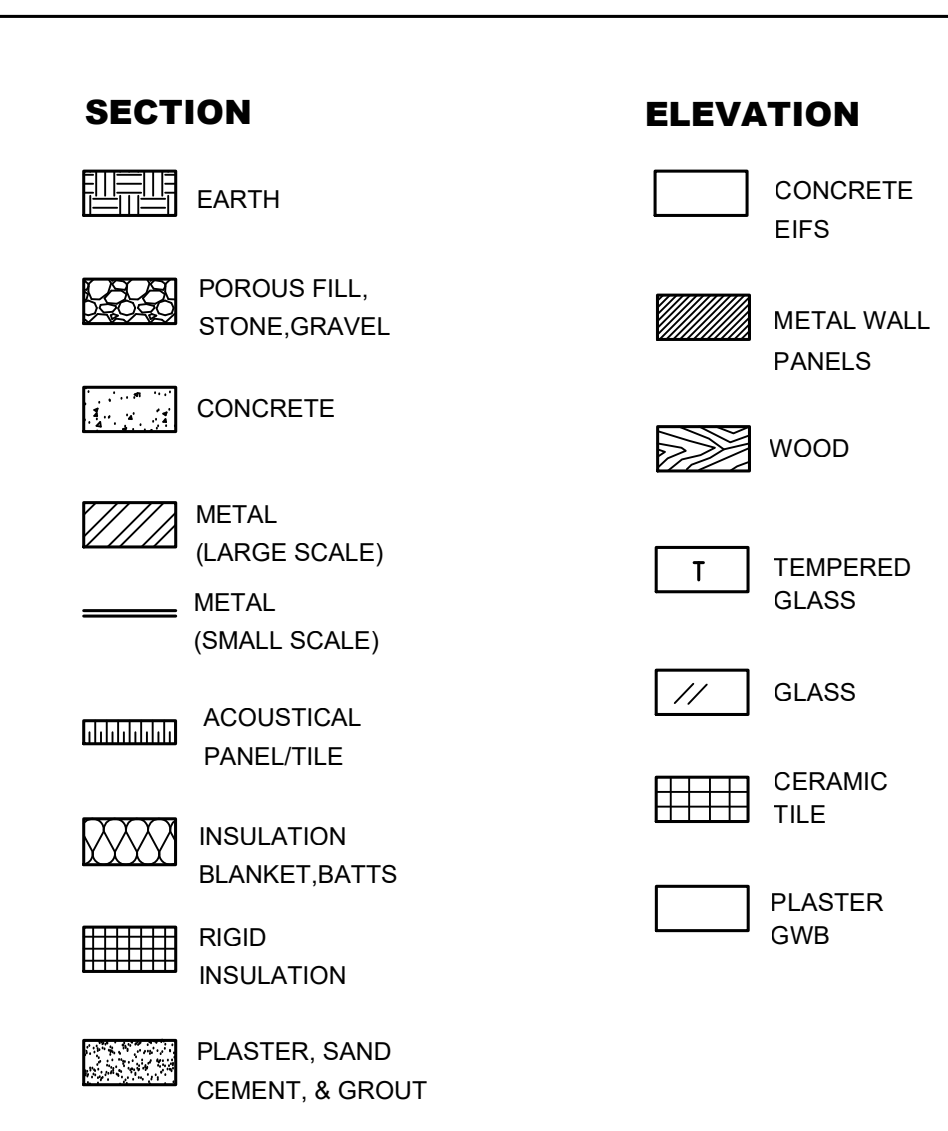

GENERAL NOTES

- 1. THE CONTRACTOR IS RESPONSIBLE FOR IDENTIFYING ALL AREAS ON THE PROJECT WHICH REQUIRE TOLERANCES BETWEEN ROUGH OPENINGS AND/OR FINISH MATERIALS...
2. THE CONTRACTOR AND SUBCONTRACTORS SHALL BE RESPONSIBLE FOR THE REVIEW AND COORDINATION OF ALL DRAWINGS AND SCHEDULES INCLUDING, BUT NOT LIMITED TO ARCHITECTURAL, STRUCTURAL, MECHANICAL, AND ELECTRICAL...
3. ANY WORK PERFORMED IN CONFLICT WITH ANY PART OF THE CONTRACT DOCUMENTS OR ANY CODE REQUIREMENT SHALL BE CORRECTED BY THE CONTRACTOR AT HIS OWN EXPENSE AND AT NO EXPENSE TO THE OWNER OR ARCHITECT...
4. THE CONTRACTOR AND SUBCONTRACTORS SHALL BE RESPONSIBLE FOR COORDINATION OF THEIR WORK WITH THE WORK OF OTHER TRADES...
5. ALL DIMENSIONS SHALL TAKE PRECEDENCE OVER SCALE SHOWN ON PLANS, SECTIONS, AND DETAILS...
6. THE GENERAL CONTRACTOR IS SOLELY RESPONSIBLE FOR SAFETY ITEMS AND PROCEDURES DURING THE TERM OF CONSTRUCTION...
7. KEYNOTES ARE REPRESENTATIVE OF ITS OWN SHEET... KEYNOTES ARE NOT TO BE USED FOR OTHER SHEETS U.N.O.

FIRE DEPARTMENT NOTES


- DOORS:
1. EXIT DOORS SHALL BE OPERABLE FROM THE INSIDE WITHOUT THE USE OF A KEY OR SPECIAL KNOWLEDGE OR EFFORT...
2. EXIT DOORS SERVING MORE THAN 50 OCCUPANTS SHALL HAVE PANIC HARDWARE PER U.B.C. SEC. 1004.
3. FIRE RATED DOORS SHALL BE PROTECTED BY A TIGHT FITTING SMOKE AND DRAFT CONTROL ASSEMBLY...
4. GLAZING WITHIN 24" OF ANY DOOR OR WITHIN 60" OF A WALKING SURFACE MUST BE OF SAFETY GLAZING MATERIAL...

EXIT SIGNS:
1. PROVIDE EXIT SIGNS AND FLOOR LEVEL EXIT SIGNS AS INDICATED ON PLANS AND PER U.B.C. SECTIONS 1012 AND 1013...
2. PROVIDE TWO SEPARATE SOURCES OF POWER FOR EXIT SIGNS CONFORMING TO CODE SECTIONS U.B.C. SEC. 1013.4, U.F.C. 1212.5...



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WINDOWS ON
THE UNIVERSE
CENTER FOR
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OUTREACH

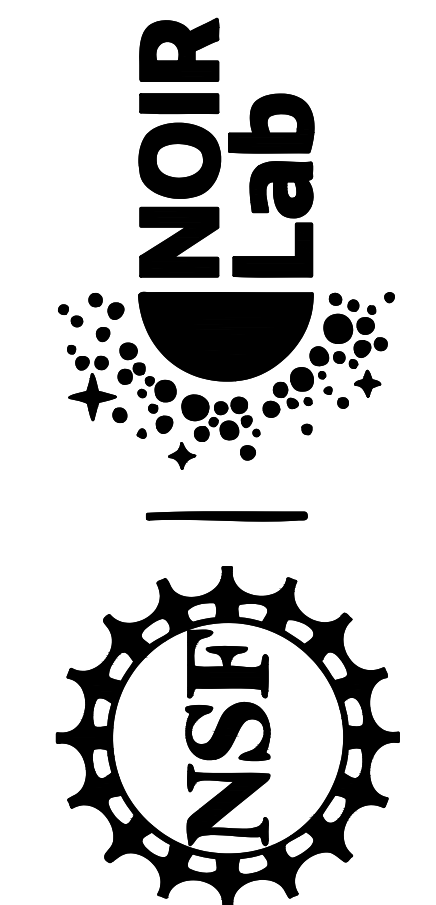

KITT PEAK - Sells, AZ 85634

Table with columns for DATE and DESCRIPTION, containing one entry: 01/08/21 I.F.C.

PROJECT NUMBER: 11904.00
DRAWN BY: FH
CHECKED BY: IR
CAD FILE: 11904.00-GD.0
SCALE: AS NOTED

GENERAL INFORMATION

GO.0

CODE REVIEW - INTERNATIONAL BUILDING CODE 2018

CHAPTER	USE AND OCCUPANCY CLASSIFICATIONS	REQUIRED	PROVIDED/EXISTING
CHAPTER 3 303.4	GROUND FLOOR: ASSEMBLY "A-3" 7,175 S.F. GROSS		
CHAPTER 5 504.3	BUILDING HEIGHTS AND AREAS ALLOWABLE BUILDING HEIGHT: * TELESCOPE TOWER IS UNLIMITED IN HEIGHT PER SECTION 504.3 EXCEPTION	55'-0" MAX	15'-0" AT PARKING LEVEL
504.4	ALLOWABLE STORIES:	2 MAX	2
506.2	ALLOWABLE BUILDING AREA:	9,500 S.F. MAX	7,175 S.F.
CHAPTER 6 TABLE 601	TYPES OF CONSTRUCTION: II-B FIRE RESISTANCE RATING FOR BUILDING ELEMENTS	REQUIRED	PROVIDED/EXISTING
	STRUCTURAL FRAME:	0	0
	BEARING WALLS - EXTERIOR: (NO EXT. BEARING WALLS THIS PROJECT)	0	0
	BEARING WALLS - INTERIOR:	0	0
	NON-BEARING WALLS - EXTERIOR:	0	0
	NON-BEARING WALLS - INTERIOR:	0	0
	FLOOR CONSTRUCTION:	0	0
	ROOF CONSTRUCTION:	0	0
CHAPTER 8 TABLE 803.13	INTERIOR FINISHES INTERIOR WALL AND CEILING FINISH REQUIREMENTS "A-3" OCCUPANCY - NON-SPRINKLED INTERIOR EXIST STAIRWAYS, INTERIOR EXIT RAMPS AND EXIT PASSAGEWAYS CORRIDORS AND ENCLOSURE FOR EXIT ACCESS STAIRWAYS AND EXIT ACCESS RAMPS ROOMS AND ENCLOSED SPACES	REQUIRED CLASS B CLASS B CLASS C	
CHAPTER 9 903.2	FIRE PROTECTION SYSTEMS AUTOMATIC SPRINKLER SYSTEMS:		NOT REQUIRED / NON PROVIDED
906	PORTABLE FIRE EXTINGUISHERS	TYPE	MAX. FLOOR AREA PER UNIT MAX. FLOOR AREA PER EXTINGUISHER MAX. TRAVEL DISTANCE
	LIGHT HAZARD OCCUPANCY	2-A	3,000 SF 11,250 SF 75 FT 3 TYPE 2A EXTINGUISHERS PROVIDED

CHAPTER 10

MEANS OF EGRESS



ROOM NAME	ALLOWABLE OCCUPANCY			
	NET S.F. OCC.	FUNCTION OF SPACE	O.L.F. OCC. LOAD	
PLANETARIUM	322 A-3	UN-FIXED CHAIRS	7	46
FRONT LOBBY	450 A-3	EXHIBIT GALLERY	30	15
RESTROOMS	430 A-3	EXHIBIT GALLERY	30	15
EXHIBIT SPACE COORD	1,651 A-3	EXHIBIT GALLERY	30	56
CONTROL ROOM	1,387 A-3	EXHIBIT GALLERY	30	47
COMPUTER ROOM	195 A-3	UNINHABITAL EXHIBIT SPACE	0	0
RESTROOMS	206 A-3	EXHIBIT GALLERY	30	7
CIRCUITRY ROOM	129 A-3	UNINHABITAL EXHIBIT SPACE	0	0
STORAGE SPACE	40 S-1	ACCESSORY STORAGE	300	1
UTILITY ROOM	77 A-3	UNINHABITAL EXHIBIT SPACE	0	0
ASTRONOMY CLASSROOM	387 A-3	UNCONCENTRATED T & C	15	26
NSF ASTONOMY EXHIBIT	440 A-3	EXHIBIT GALLERY	30	15
S.O.S. THEATER	777 A-3	UN-FIXED CHAIRS	30	26
OFFICE	234 B	ACCESSORY OFFICE	150	2
CONCRETE TUNNEL	479 A-3	UNINHABITAL EXHIBIT SPACE	30	16
	7204	TOTAL OCCUPANCY		272

1005	MINIMUM EGRESS WIDTH OCCUPANT LOAD: 325	FACTOR 0.20	REQUIRED 65"	PROVIDED (2) 72" = 144"
1006.3.2	ACCESSIBLE MEANS OF EGRESS: OCCUPANT LOAD: 325 > 49 & < 500		REQUIRED 2	PROVIDED 2
1017 TABLE 1017.2	EXIT ACCESS TRAVEL DISTANCE MAXIMUM TRAVEL DISTANCE:		REQUIRED 200'-0" MAX	PROVIDED 167'-11"

CHAPTER 29



PLUMBING FIXTURES

2902.1	A-3: ASSEMBLY SPACE WATER CLOSET	REQUIRED 2-MEN 3-WOMEN	PROVIDED 3-MEN 4-WOMEN
	LAVATORIES	1-MEN 1-WOMEN	3-MEN 4-WOMEN
	DRINKING FOUNTAINS	1 REQUIRED	3 PROVIDED
	SERVICE SINK	1 REQUIRED	2 PROVIDED

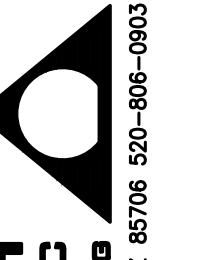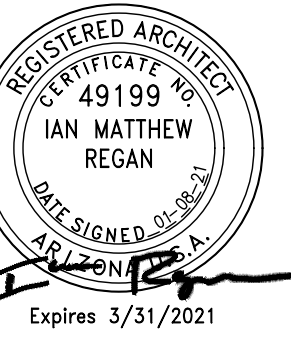
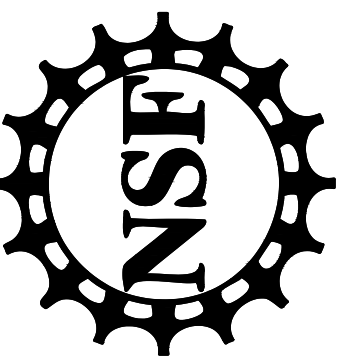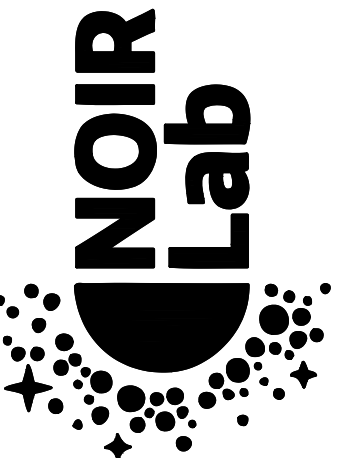
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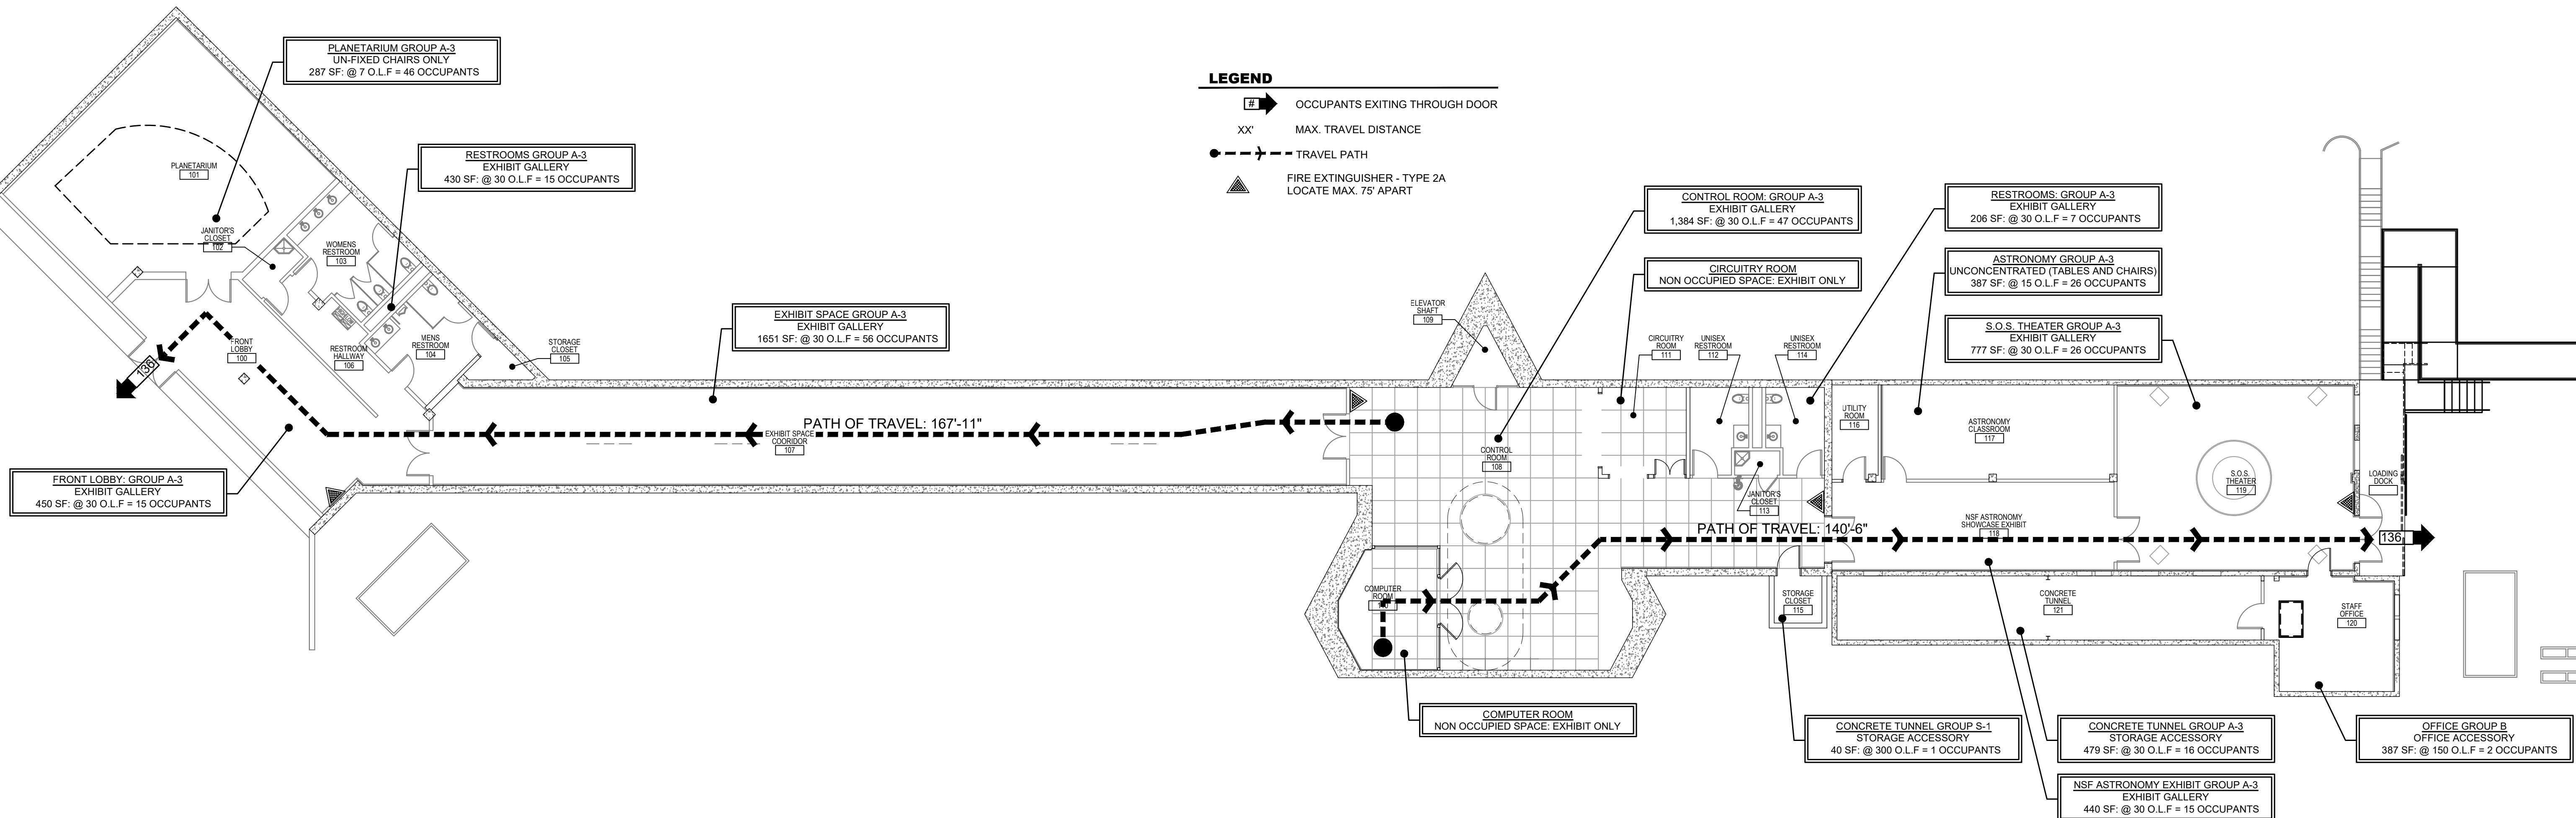
KITT PEAK - Sells, AZ 85634

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PROJECT NUMBER:	11904.00
DRAWN BY:	LM
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EGRESS
PLAN

G1.0

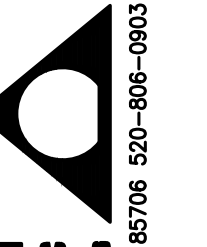


LEGEND

- ➡ OCCUPANTS EXITING THROUGH DOOR
- XX' MAX. TRAVEL DISTANCE
- TRAVEL PATH
- ▲ FIRE EXTINGUISHER - TYPE 2A LOCATE MAX. 75' APART

1 EGRESS FLOOR PLAN
1ST LEVEL

SCALE: 3/32"=1'-0"

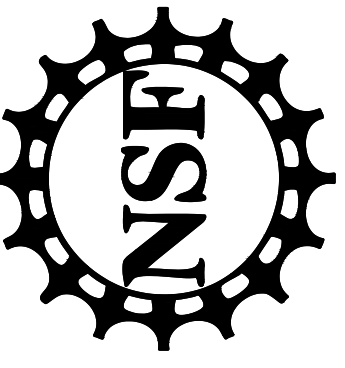
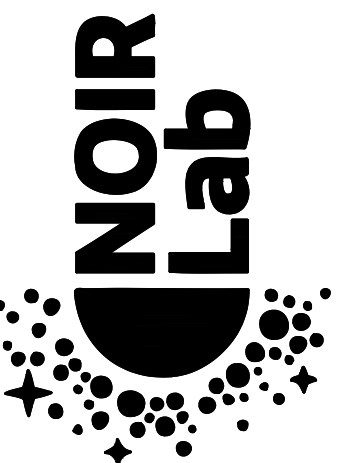


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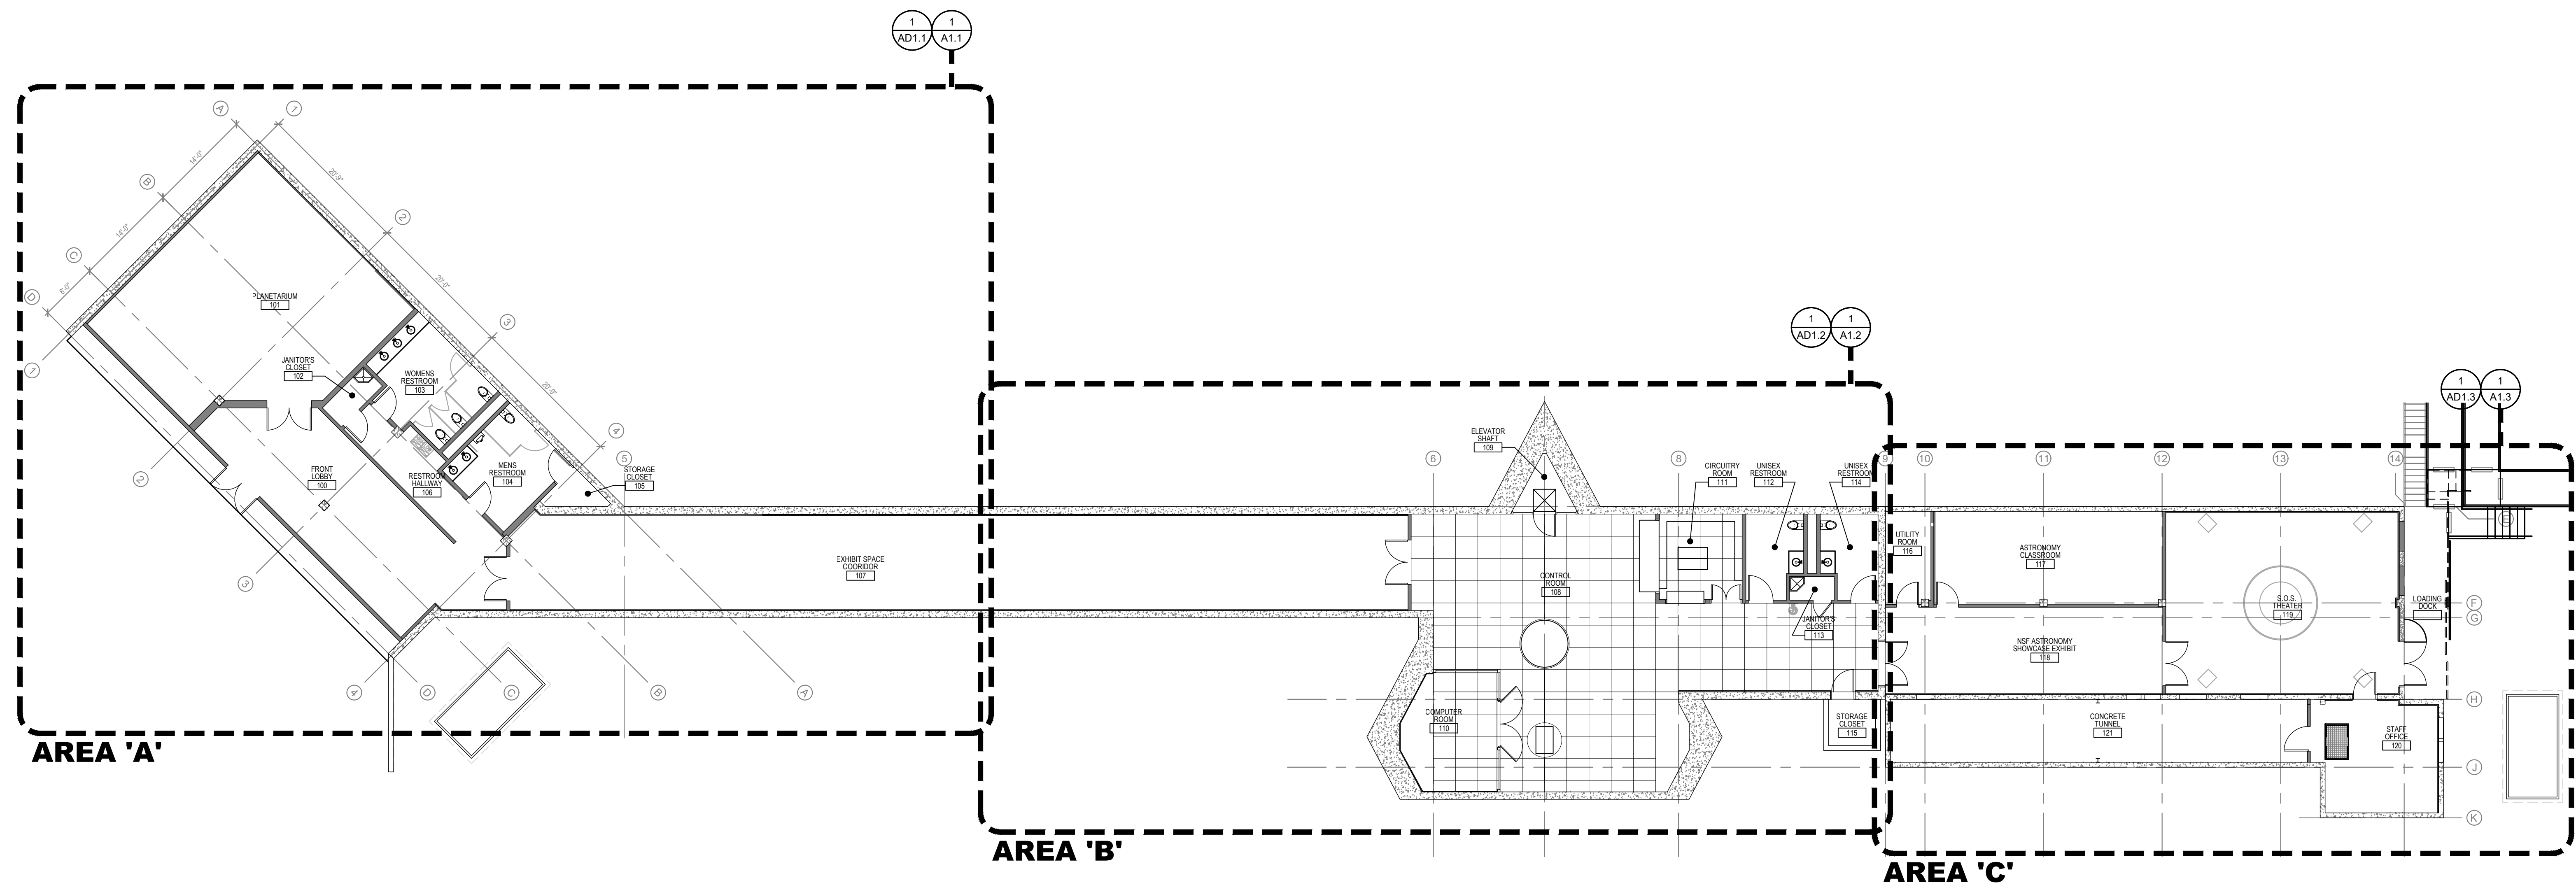
DEMOLITION GENERAL NOTES:

- A. REFER TO THE ENTIRE SET FOR ADDITIONAL INFORMATION AND REQUIREMENTS.
- B. COORDINATE ALL WORK WITH STRUCTURAL, ELECTRICAL, MECHANICAL DRAWINGS & OTHER DISCIPLINES INVOLVED.
- C. VERIFY ALL FIELD CONDITIONS & DIMENSIONS, NOTIFY ARCHITECT OF ANY DISCREPANCIES PRIOR TO COMMENCEMENT OF WORK.
- D. UNLESS NOTED OTHERWISE, ALL WORK DESCRIBED SHALL BE PERFORMED BY CONTRACTOR. FOR ITEMS REQUIRING OWNER DIRECTION, CONTRACTOR SHALL COORDINATE DIRECTLY WITH OWNER. THIS INCLUDES BUT IS NOT LIMITED TO FURNITURE RELOCATION, EQUIPMENT RELOCATION, I.T. ITEMS, ETC.
- E. DO NOT SCALE DRAWINGS. IF DIMENSIONS ARE NOT PROVIDED, CONTACT ARCHITECT FOR CLARIFICATION.
- F. CONTRACTOR TO PROVIDE DETAILED PHASING, DEBRIS, DUST CONTROL METHODS, ISOLATION, AND ACCESS TO RESTROOMS TO OWNER FOR APPROVAL PRIOR TO INITIATION OF WORK.
- G. MAINTAIN A SAFE AND CLEAN WORK AREA - REMOVE ALL TRASH AND DEBRIS AT THE END OF EACH WORK SHIFT.
- H. PROVIDE PERSONNEL PROTECTION FROM DEBRIS & MATERIAL FALL PER OWNER STANDARDS, INCLUDING BUT NOT LIMITED TO SCAFFOLDING FOR OVERHEAD PROTECTION WITH TOE BOARDS, & VISQUEEN DUST BARRIER.
- I. CONTRACTOR TO AVOID MOVING MATERIALS OR TOOLS THROUGH OPERATING AREAS.
- J. CONTRACTOR TO VERIFY AND COORDINATE WITH OWNER BEFORE DISCONNECTING OR SHUTTING OFF ANY UTILITIES DURING CONSTRUCTION.
- K. COORDINATE ALL DISMANTLING, REMOVALS, STAGING, AND OTHER WORK WITH OWNER PRIOR TO INITIATION OF WORK.
- L. PROVIDE TEMPORARY INDEPENDENT SUPPORT FOR SYSTEMS AND EQUIPMENT SERVING OPERATIONAL AREAS, INCLUDING BUT NOT LIMITED TO: FIRE PROTECTION, LIGHTING, PIPING, CONDUITS, ETC.
- M. ALL INTERIOR AND EXTERIOR STRUCTURE IS EXISTING TO REMAIN UNLESS NOTED OTHERWISE.

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1 ARCHITECTURAL COMPOSITE PLAN
1ST. LEVEL


SCALE: 3/32" = 1'-0"

DATE	DESCRIPTION
0 01/08/21	I.F.C.
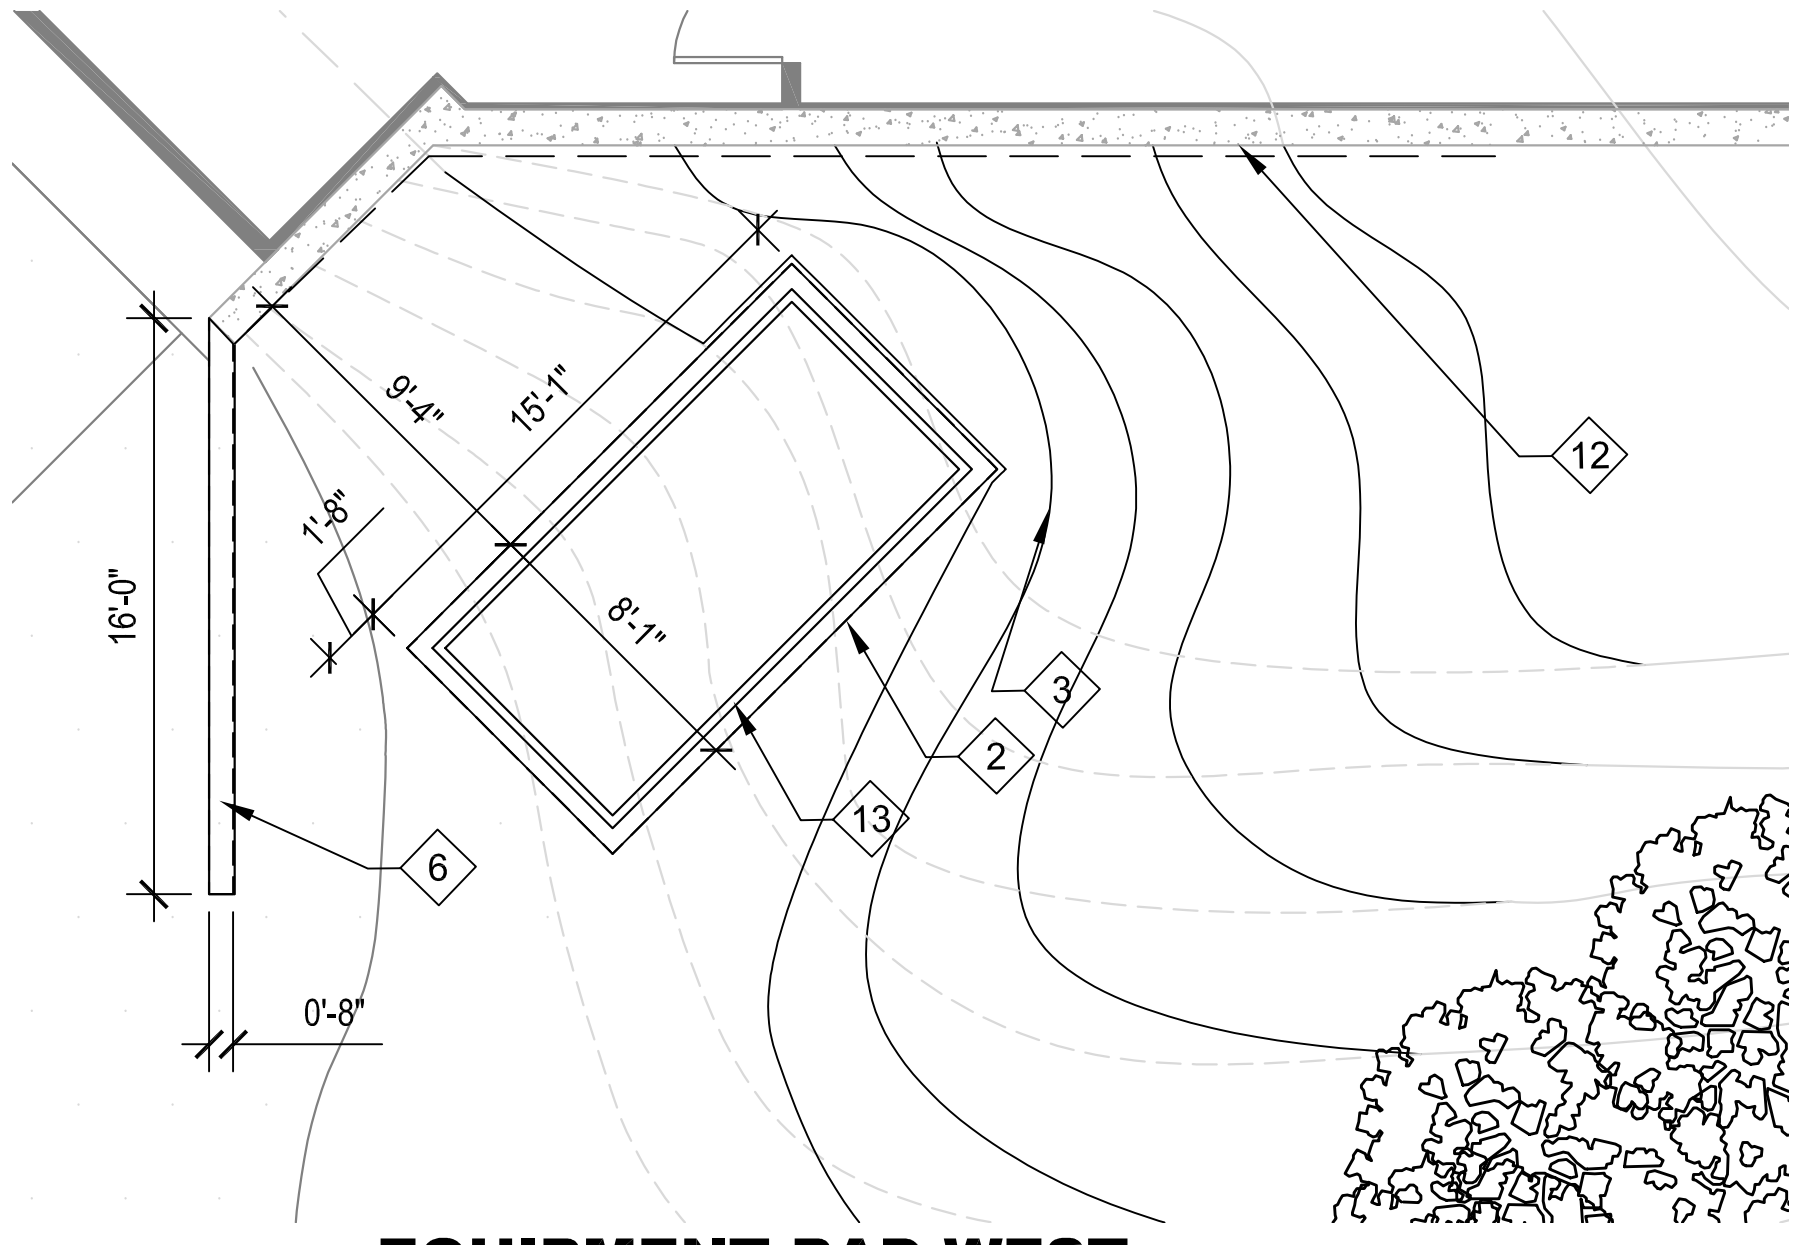
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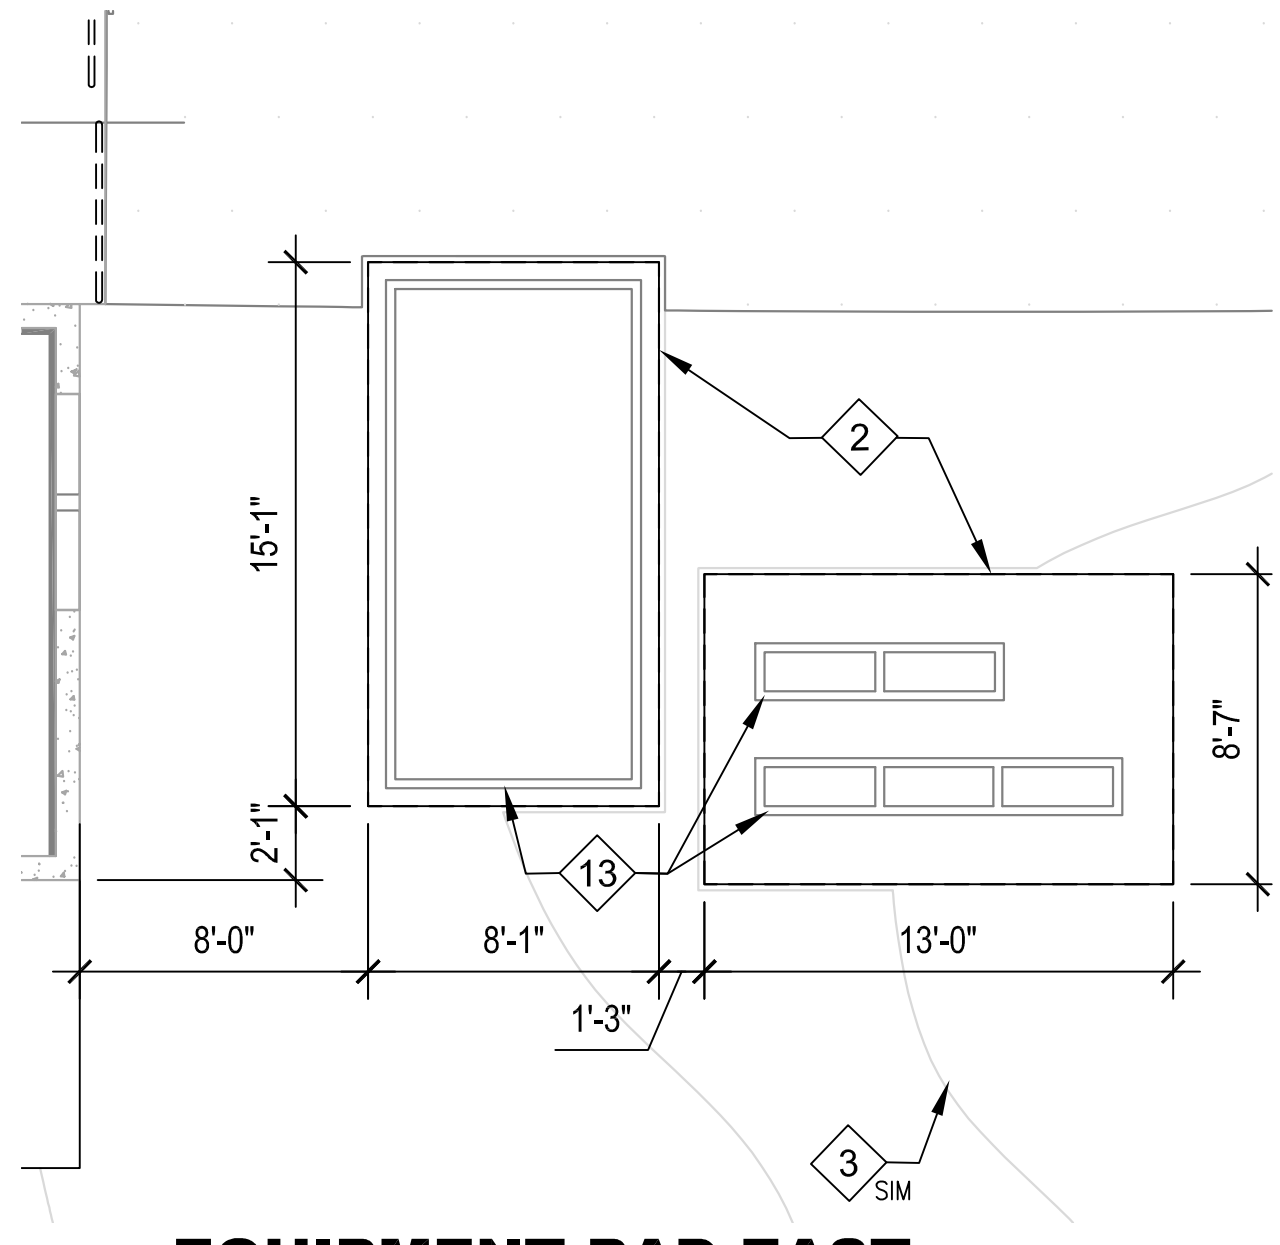
ARCHITECTURAL
COMPOSITE
PLAN

G2.0



2 EQUIPMENT PAD WEST
SITE

SCALE: 3/16" = 1'-0"



3 EQUIPMENT PAD EAST
SITE

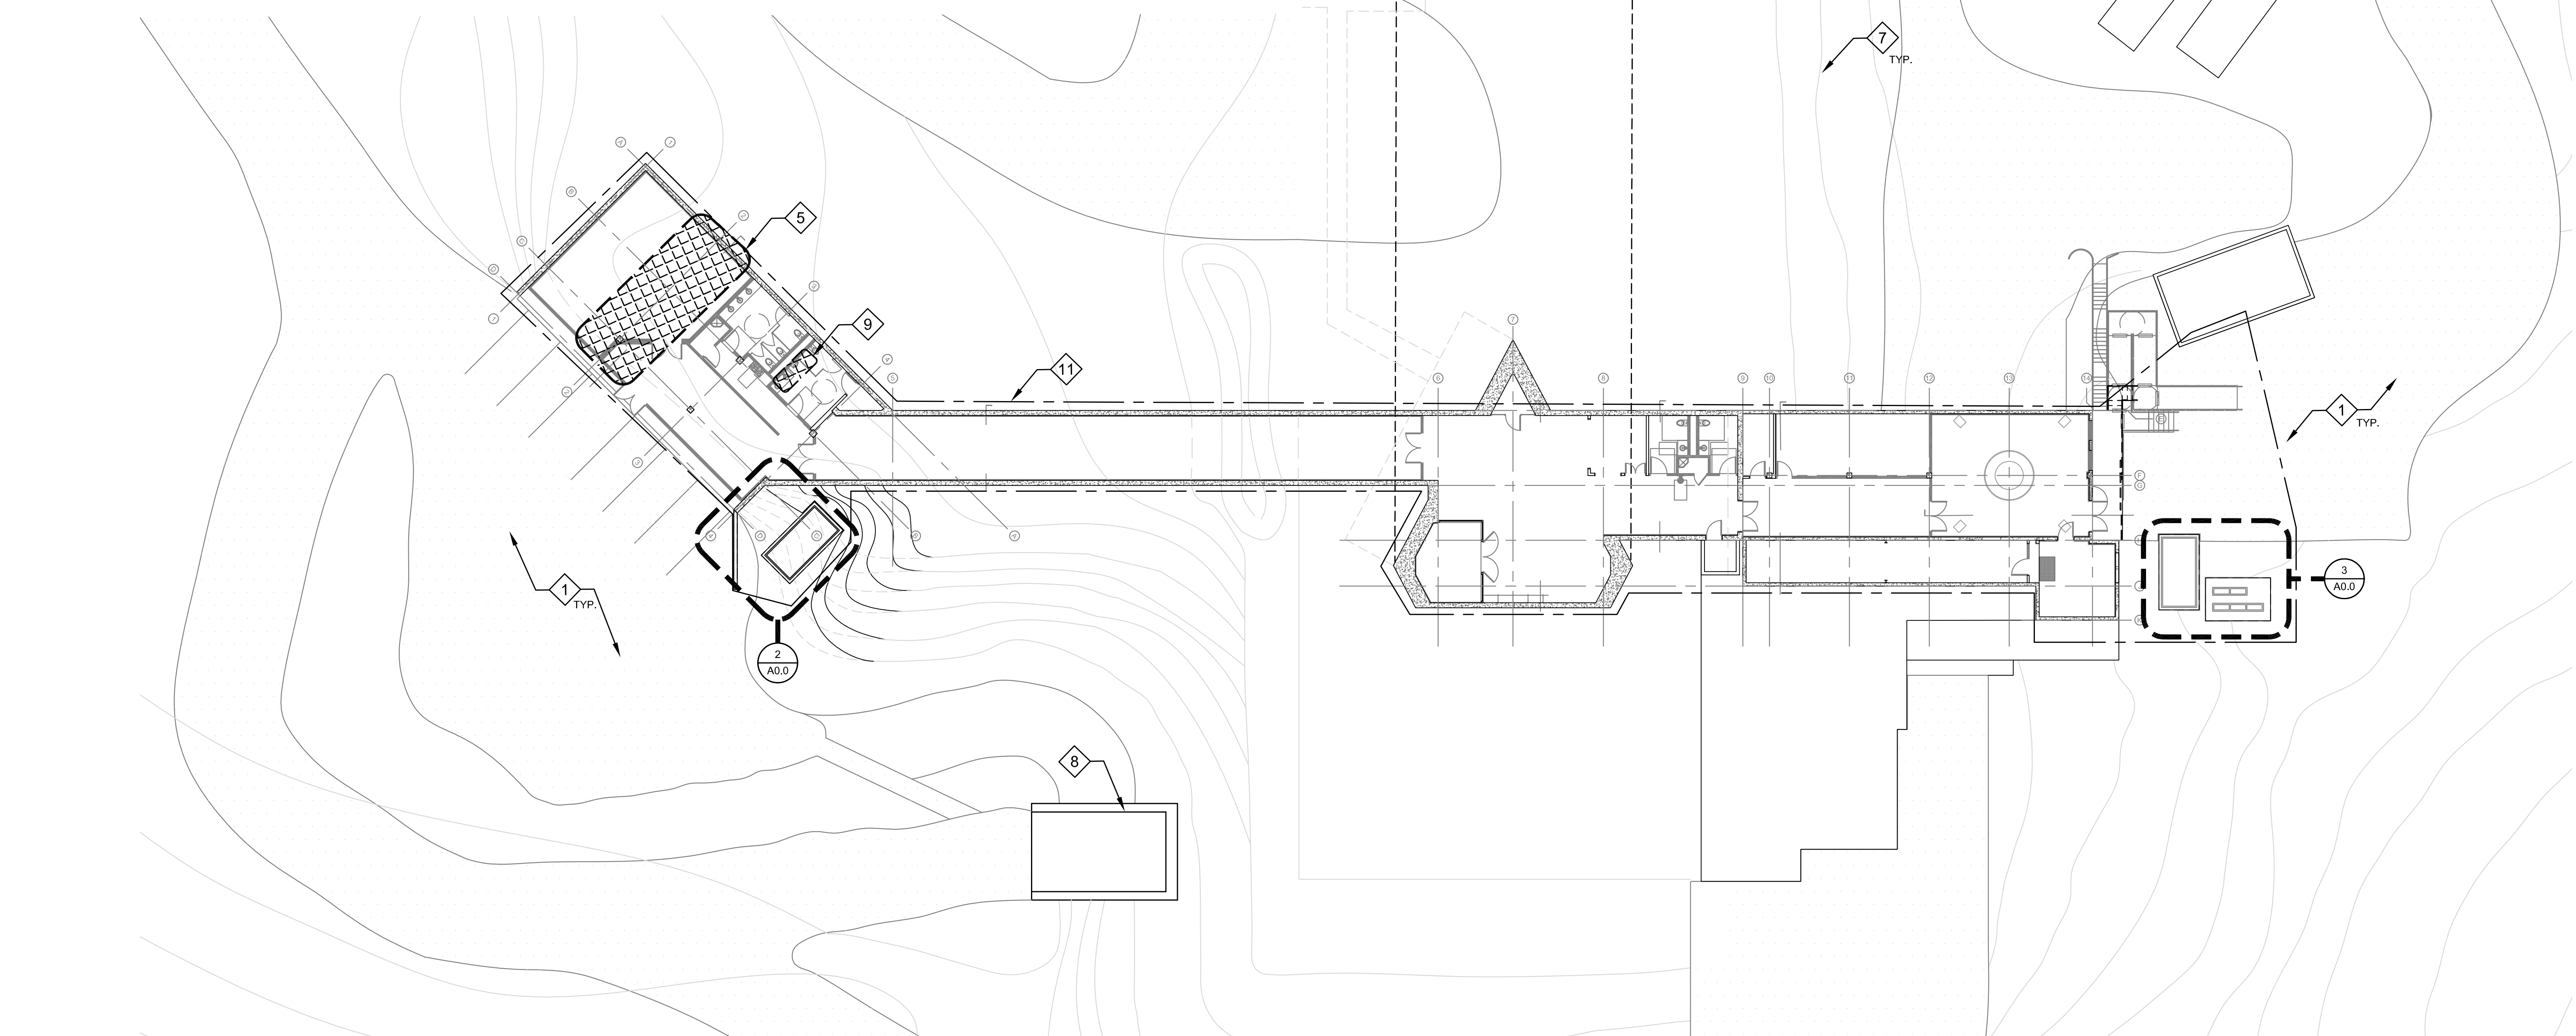
SCALE: 3/16" = 1'-0"

SITE PLAN GENERAL NOTES:

- A. SEE GENERAL STRUCTURAL NOTES FOR ADDITIONAL INFORMATION, AS NEEDED. SEE SHEET S1.0
- B. CONTRACTOR SHALL COORDINATE AND VERIFY DIMENSIONS AND LOCATIONS AND QUANTITY OF ANY/ALL RAISED CURBS SHOWN ON DRAWINGS WITH TANK MANUFACTURER AND PROCESS PIPING INSTALLER. IMMEDIATELY SUBMIT ANY DISCREPANCIES TO ARCHITECT.
- C. DO NOT SCALE THE DRAWINGS
- D. CONTRACTOR TO VERIFY CONDITIONS AND DIMENSIONS PRIOR TO CONSTRUCTION. NOTIFY ARCHITECT OF DISCREPANCIES PRIOR TO COMMENCEMENT OF THE WORK.

FLOOR PLAN KEYNOTES:

- 1. ASPHALT TO BE PROTECTED IN PLACE.
- 2. MECHANICAL EQUIPMENT PADS, SEE MECHANICAL AND STRUCTURAL DRAWINGS.
- 3. REMOVE EXISTING EARTHWORK AND VEGETATION, REGRADE SLOPE AS NEEDED FOR NEW EQUIPMENT PADS. PROVIDE UNGROUTED RIPRAP TO STABILIZE NEW SLOPE.
- 4. TELESCOPE ABOVE. PROTECT ALL METAL SIDING AS NEEDED DURING CONSTRUCTION.
- 5. PORTION OF EARTHWORK TO BE REMOVED OVER STRUCTURE FOR NEW BEAM INSTALL. SEE STRUCTURAL.
- 6. PROVIDE NEW FOUNDATION FOR NEW SIGNAGE. TBD.
- 7. EXISTING TOPOGRAPHY TO REMAIN.
- 8. ACCESS TO UNDERGROUND ALUMINIZATION ROOM TO REMAIN.
- 9. REMOVE EXISTING EARTHWORK AND VEGETATION AS NEEDED FOR NEW EXHAUST VENTILATION. COORDINATE WITH MECHANICAL.
- 10. UNDERGROUND TUNNELS, FOR REFERENCE ONLY. SEE ELECTRICAL FOR SCOPE.
- 11. CONTRACTOR EXTENT OF SCOPE. COORDINATE WITH OWNER FOR LAYDOWN AREAS, HOURS OF OPERATION, AND ACCESS TO SITE FOR ALL SUB-CONTRACTORS.
- 12. POWERWASH AND SEAL NEWLY EXPOSED CONCRETE WALL.
- 13. PROVIDE 12" HIGH PAINTED STEEL SUPPORT STRUCTURE UNDER HVAC EQUIPMENT. COORDINATE SIZE AND LOCATION WITH MECHANICAL UNIT. ANCHOR SUPPORT FRAME TO CONCRETE EQUIPMENT PAD W/ EPOXY ANCHORS.



1 OVERALL EXISTING SITE PLAN
GROUND LEVEL

SCALE: 1/8" = 1'-0"



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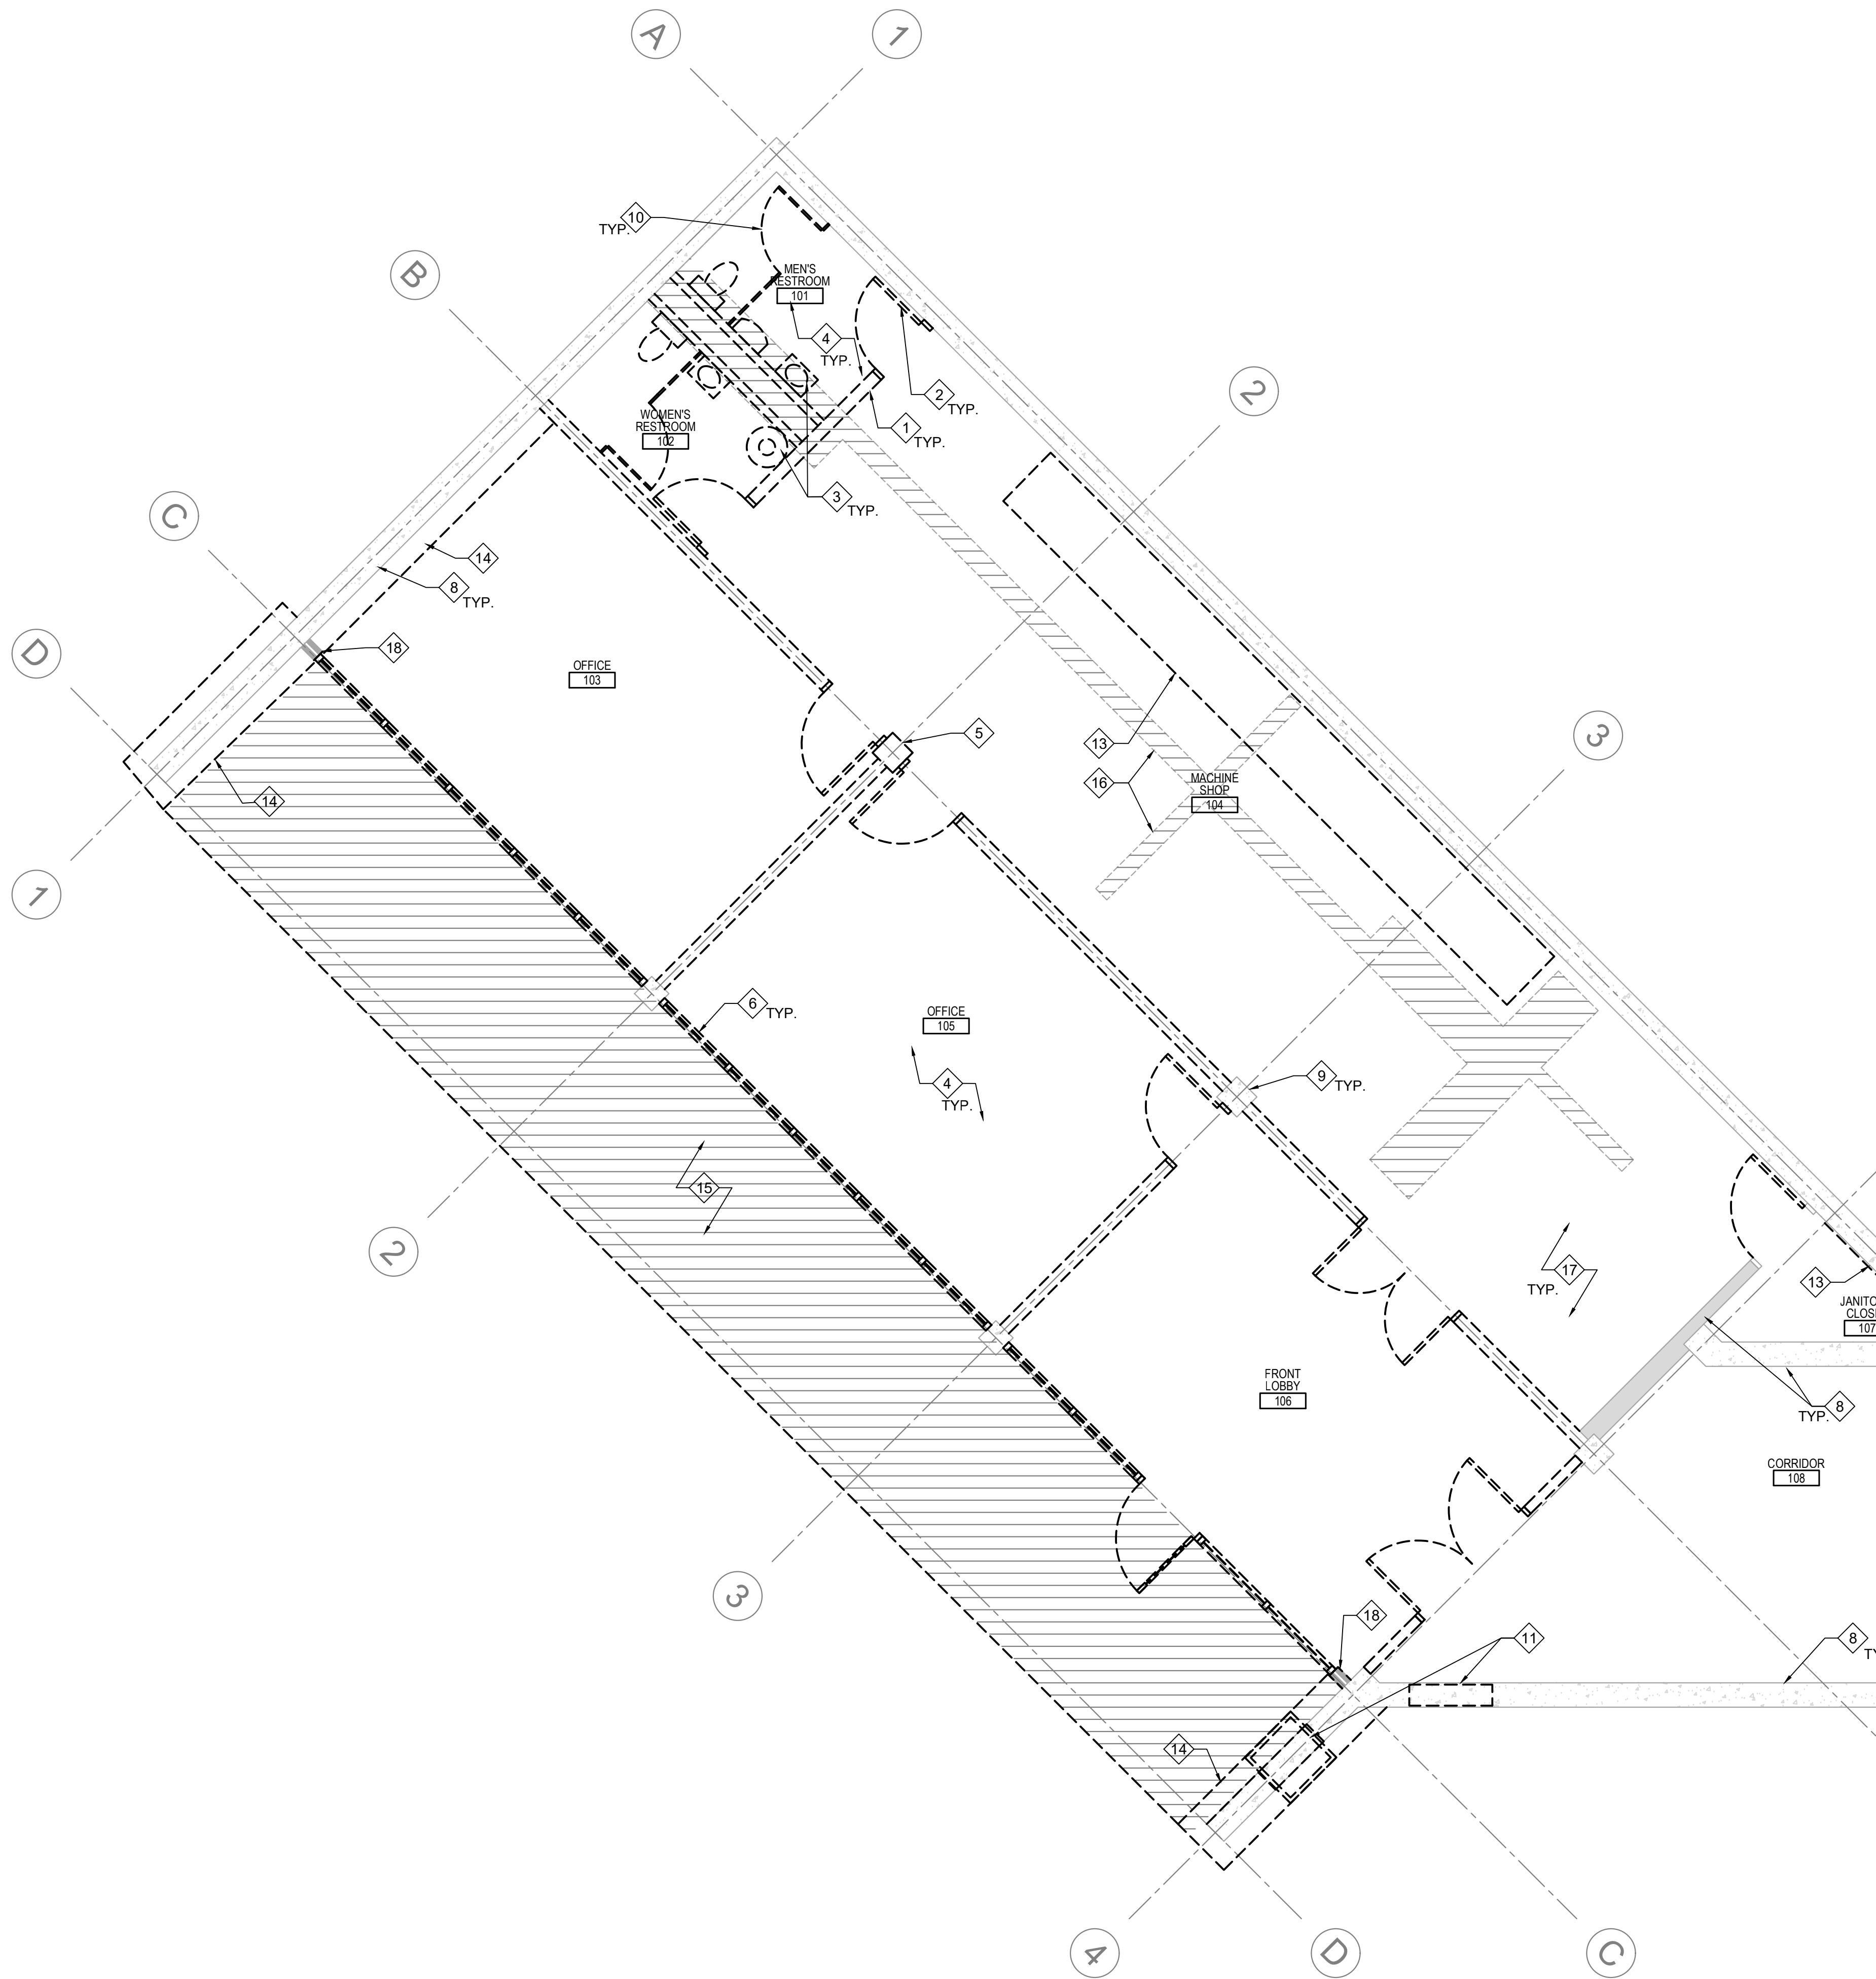
NOIR
Lab
NSF
KITT PEAK - Sells, AZ 85634

△	DATE	DESCRIPTION
0	01/08/21	I.F.C.

PROJECT NUMBER: 11904.00
DRAWN BY:
CHECKED BY: IR
CAD FILE: 11904.00-A0.0
SCALE: AS NOTED

OVERALL
SITE PLAN

A0.0



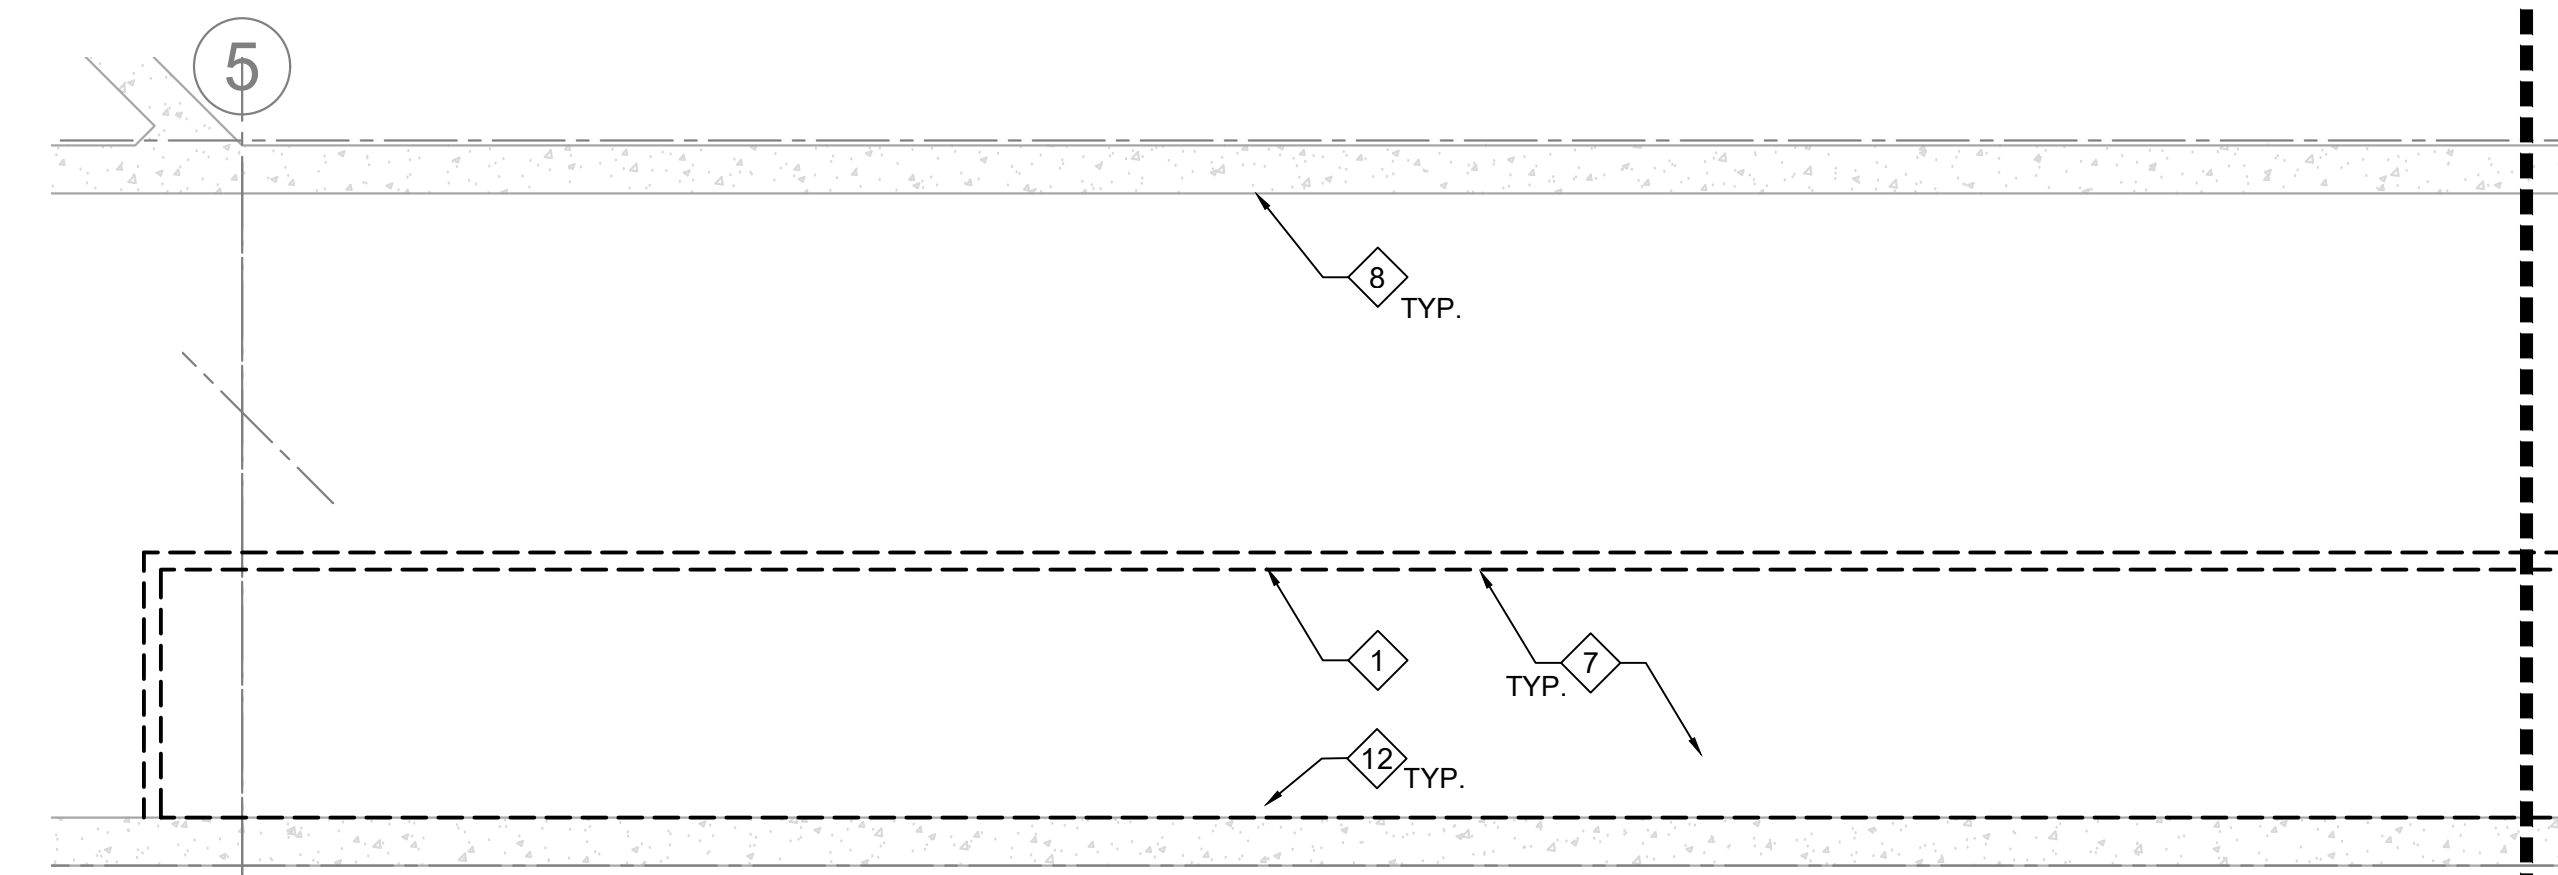
1 ARCHITECTURAL ENLARGED DEMO FLOOR PLAN - AREA A
1ST. LEVEL

FLOOR PLAN KEYNOTES:

1. DEMOLISH (E) WALL. PATCH AND REPAIR ADJACENT WALL WHERE ANCHORED.
2. REMOVE DOOR AND FRAME. PROTECT ADJACENT WALLS FROM DAMAGE DURING WORK.
3. DEMOLISH PLUMBING FIXTURES. SEE MECHANICAL SHEETS.
4. REMOVE FLOORING AND BASE BOARD. PREP FOR NEW FLOORING PER FINISH SCHEDULE.
5. DEMOLISH (E) COLUMN. SUPPORT ROOF AS REQUIRED. SEE STRUCTURAL SHEETS.
6. DEMOLISH (E) STOREFRONT WINDOW.
7. REMOVE ENTIRE FLOORING AND STRUCTURAL SYSTEM OF ENTIRE MEZZANINE. COORDINATE WITH MECHANICAL AND ELECTRICAL FOR DEMOLITION OF FIXTURES AND DIFFUSERS.
8. (E) WALL TO REMAIN. PREP SURFACE FOR NEW FINISH. SEE RENOVATION PLANS AND FINISH SCHEDULE.
9. (E) COLUMN TO REMAIN.
10. REMOVE FLOOR MOUNTED TOILET PARTITIONS.
11. REMOVE PORTION EXISTING CONCRETE WALL FOR NEW MECHANICAL PENETRATION. COORDINATE WITH MECHANICAL.
12. EXISTING WALL HUNG EQUIPMENT TO REMAIN.
13. REMOVE EXISTING MILLWORK AS SHOWN.
14. REMOVE VENEER.
15. REMOVE EXISTING FRONT CONCRETE APRON.
16. REMOVE EXISTING CONCRETE AS REQUIRED FOR NEW UNDERGROUND PLUMBING AND ELECTRICAL. REFER TO MECHANICAL AND ELECTRICAL SHEETS FOR MORE INFO.
17. EXISTING CONCRETE FLOORING TO BE PREPPED FOR NEW FLOORING PER FINISH SCHEDULE.
18. REMOVE PORTION EXISTING CONCRETE WALL.

DEMOLITION GENERAL NOTES:


- A. REFER TO THE ENTIRE SET FOR ADDITIONAL INFORMATION AND REQUIREMENTS.
- B. COORDINATE ALL WORK WITH STRUCTURAL, ELECTRICAL, MECHANICAL DRAWINGS & OTHER DISCIPLINES INVOLVED.
- C. VERIFY ALL FIELD CONDITIONS & DIMENSIONS. NOTIFY ARCHITECT OF ANY DISCREPANCIES PRIOR TO COMMENCEMENT OF WORK.
- D. UNLESS NOTED OTHERWISE, ALL WORK DESCRIBED SHALL BE PERFORMED BY CONTRACTOR. FOR ITEMS REQUIRING OWNER DIRECTION, CONTRACTOR SHALL COORDINATE DIRECTLY WITH OWNER. THIS INCLUDES BUT IS NOT LIMITED TO FURNITURE RELOCATION, EQUIPMENT RELOCATION, I.T. ITEMS, ETC.
- E. DO NOT SCALE DRAWINGS. IF DIMENSIONS ARE NOT PROVIDED, CONTACT ARCHITECT FOR CLARIFICATION.
- F. CONTRACTOR TO PROVIDE DETAILED PHASING, DEBRIS, DUST CONTROL METHODS, ISOLATION, AND ACCESS TO RESTROOMS TO OWNER FOR APPROVAL PRIOR TO INITIATION OF WORK.
- G. MAINTAIN A SAFE AND CLEAN WORK AREA - REMOVE ALL TRASH AND DEBRIS AT THE END OF EACH WORK SHIFT.
- H. PROVIDE PERSONNEL PROTECTION FROM DEBRIS & MATERIAL FALL PER OWNER STANDARDS, INCLUDING BUT NOT LIMITED TO SCAFFOLDING FOR OVERHEAD PROTECTION WITH TOE BOARDS, & VISQUEEN DUST BARRIER. CONTRACTOR TO AVOID MOVING MATERIALS OR TOOLS THROUGH OPERATING AREAS.
- J. CONTRACTOR TO VERIFY AND COORDINATE WITH OWNER BEFORE DISCONNECTING OR SHUTTING OFF ANY UTILITIES DURING CONSTRUCTION. COORDINATE ALL DISMANTLING, REMOVALS, STAGING, AND OTHER WORK WITH OWNER PRIOR TO INITIATION OF WORK.
- L. PROVIDE TEMPORARY INDEPENDENT SUPPORT FOR SYSTEMS AND EQUIPMENT SERVING OPERATIONAL AREAS, INCLUDING BUT NOT LIMITED TO: FIRE PROTECTION, LIGHTING, PIPING, CONDUITS, ETC.
- M. ALL INTERIOR AND EXTERIOR STRUCTURE IS EXISTING TO REMAIN UNLESS NOTED OTHERWISE.



2 ARCHITECTURAL DEMO FLOOR PLAN - AREA A
MEZZANINE LEVEL



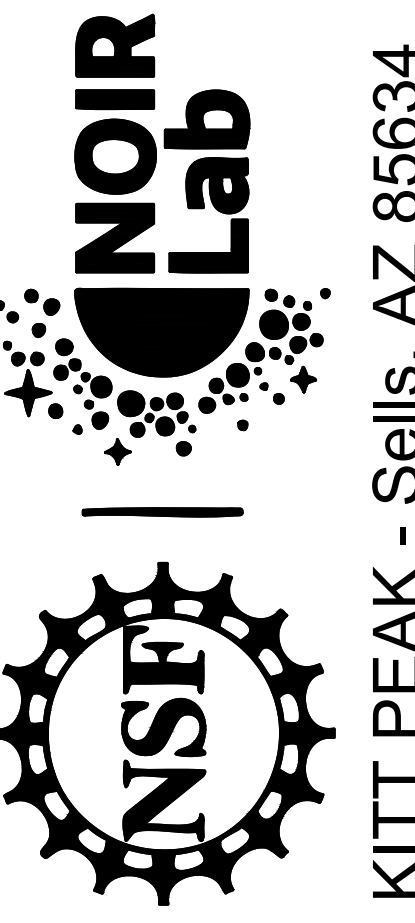WINDOWS ON
THE UNIVERSE
CENTER FOR
ASTRONOMY
OUTREACH





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DATE	DESCRIPTION
01/08/21	I.F.C.

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CHECKED BY: IR
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SCALE: AS NOTED


ENLARGED DEMO
FLOOR PLAN
AREA A

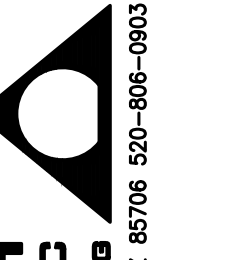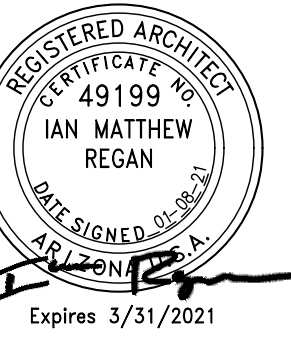AD1.1



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WINDOWS ON
 THE UNIVERSE
 CENTER FOR
 ASTRONOMY
 OUTREACH

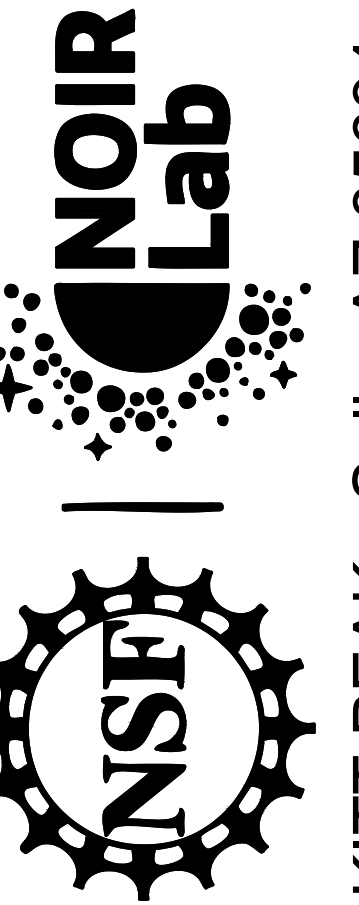

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△	DATE	DESCRIPTION
0	01/08/21	I.F.C.

PROJECT NUMBER: 11904.00
 DRAWN BY:
 CHECKED BY: IR
 CAD FILE: 11904.00-AD1.2
 SCALE: AS NOTED

ENLARGED DEMO
 FLOOR PLAN
 AREA B

AD1.2

FLOOR PLAN KEYNOTES:

- DEMOLISH (E) WALL. PATCH AND REPAIR ADJACENT WALL WHERE ANCHORED AS NEEDED.
- REMOVE DOOR AND FRAME. PROTECT ADJACENT WALLS FROM DAMAGE DURING WORK.
- DEMOLISH PLUMBING FIXTURES. SEE MECHANICAL SHEETS.
- PROTECT & PREP FOR NEW FINISH PER FINISH PLAN. RETAIN FOR REINSTALLATION CLEAN UNDER FLOOR.
- REMOVE EXISTING OUTLET COVERS AND LIGHT FIXTURE SWITCH PLATES UNO
- NO WORK THIS AREA.
- REMOVE EXISTING FLOORING AND WALL BASE UNO.
- (E) WALL TO REMAIN.
- PIT BELOW FOR REFERENCE ONLY.
- (E) DOOR TO REMAIN.
- REMOVE PANELING CLOSING WINDOW PENETRATIONS.
- (E) MILLWORK / EQUIPMENT TO REMAIN AND BE PROTECTED DURING DEMOLITION. COORDINATE WITH OWNER FOR WIREWAYS AND MISC. ELECTRICAL EQUIPMENT TO REMAIN FOR SHOW EXHIBITION.
- PREP EXISTING CONCRETE FLOORING FOR NEW FLOORING PER FINISH SCHEDULE.
- REMOVE EXISTING MILLWORK.
- REMOVE EXISTING EXPOSED DUCTWORK LOCATED INSIDE SPACE. SEE MECHANICAL.
- REMOVE ACOUSTICAL TILE TREATMENT ON WALLS. PREP FOR DRYWALL REPAIR.
- REMOVE EXISTING CONCRETE FOR UNDERGROUND PLUMBING, SEE MECHANICAL.
- REMOVE WOOD PANELING ON EXISTING WALL
- REMOVE EXISTING COOLANT LINES. REFER TO MECHANICAL DEMOLITION FOR MORE INFO.
- REMOVE ENTIRE FLOORING STRUCTURAL SYSTEM. ENTIRE MEZZANINE TO BE REMOVED.
- EQUIPMENT TO BE REMOVED AND RETURNED TO OWNER.
- WALL FUR OUT TO BE REMOVED
- 3/4" THICK ALUMINUM MOUNTING PLATE TO BE REMOVED.


DEMOLITION GENERAL NOTES:

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- DO NOT SCALE DRAWINGS. IF DIMENSIONS ARE NOT PROVIDED, CONTACT ARCHITECT FOR CLARIFICATION.
- CONTRACTOR TO PROVIDE DETAILED PHASING, DEBRIS, DUST CONTROL METHODS, ISOLATION, AND ACCESS TO RESTROOMS TO OWNER FOR APPROVAL PRIOR TO INITIATION OF WORK.
- MAINTAIN A SAFE AND CLEAN WORK AREA - REMOVE ALL TRASH AND DEBRIS AT THE END OF EACH WORK SHIFT.
- PROVIDE PERSONNEL PROTECTION FROM DEBRIS & MATERIAL FALL PER OWNER STANDARDS, INCLUDING BUT NOT LIMITED TO SCAFFOLDING FOR OVERHEAD PROTECTION WITH TOE BOARDS, & VISQUEEN DUST BARRIER.
- CONTRACTOR TO AVOID MOVING MATERIALS OR TOOLS THROUGH OPERATING AREAS.
- CONTRACTOR TO VERIFY AND COORDINATE WITH OWNER BEFORE DISCONNECTING OR SHUTTING OFF ANY UTILITIES DURING CONSTRUCTION. COORDINATE ALL DISMANTLING, REMOVALS, STAGING, AND OTHER WORK WITH OWNER PRIOR TO INITIATION OF WORK.
- PROVIDE TEMPORARY INDEPENDENT SUPPORT FOR SYSTEMS AND EQUIPMENT SERVING OPERATIONAL AREAS, INCLUDING BUT NOT LIMITED TO: FIRE PROTECTION, LIGHTING, PIPING, CONDUITS, ETC.
- ALL INTERIOR AND EXTERIOR STRUCTURE IS EXISTING TO REMAIN UNLESS NOTED OTHERWISE.

MATCHLINE - SEE SHEET AD1.1 FOR CONTINUATION

2 ARCHITECTURAL ENLARGED DEMO FLOOR PLAN - AREA B
 MEZZANINE LEVEL



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MATCHLINE - SEE SHEET AD1.3 FOR CONTINUATION


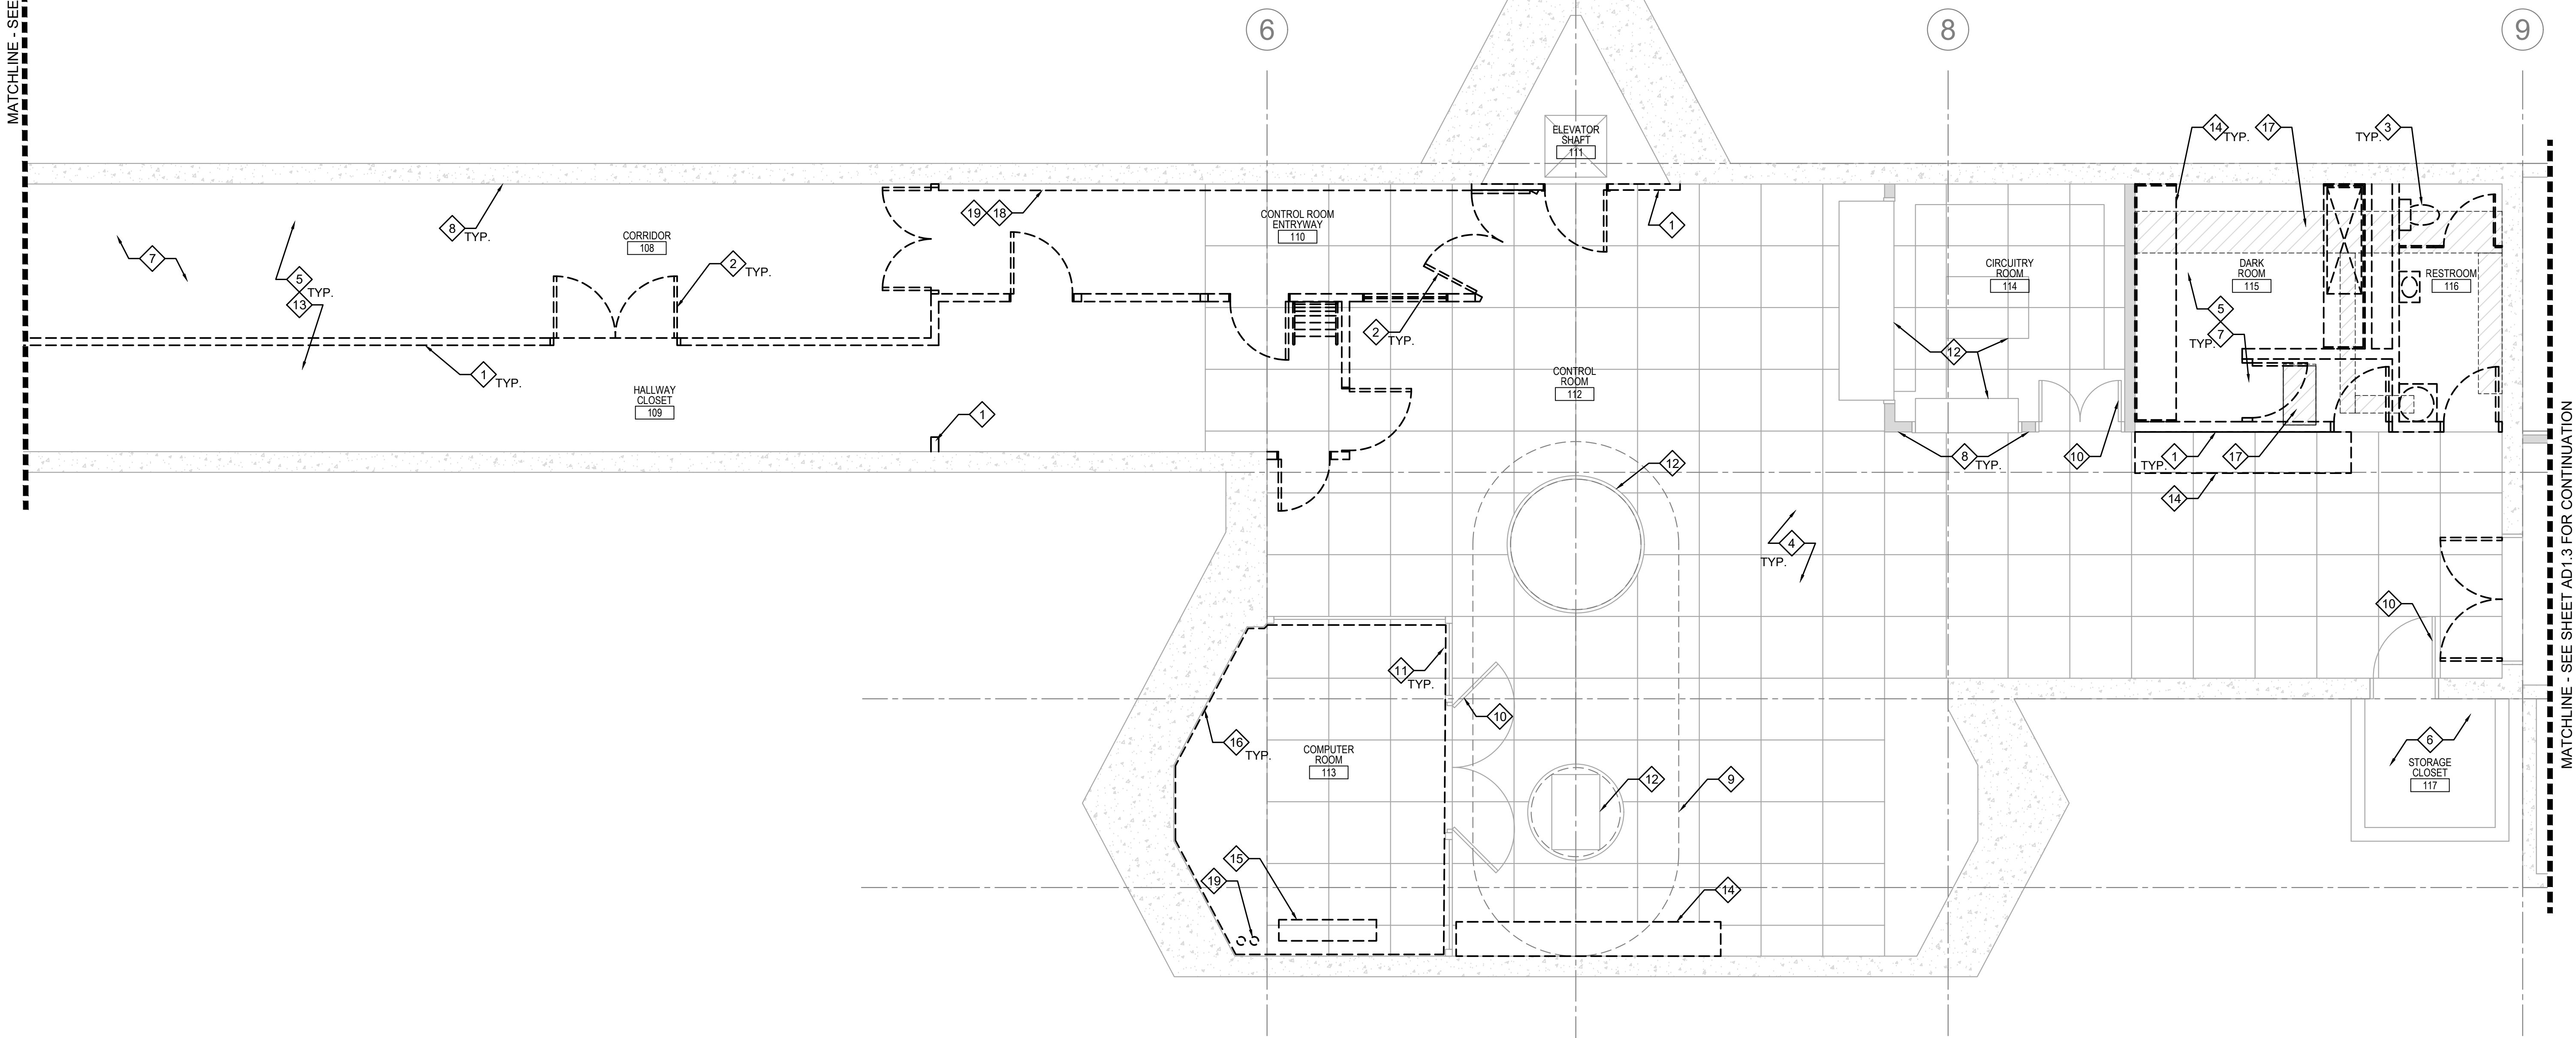
1 ARCHITECTURAL ENLARGED DEMO FLOOR PLAN - AREA B
 1ST. LEVEL

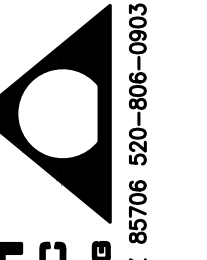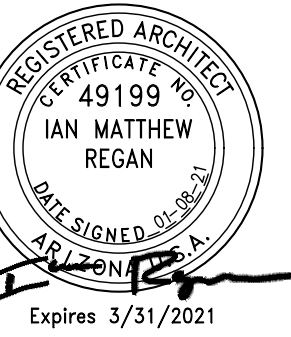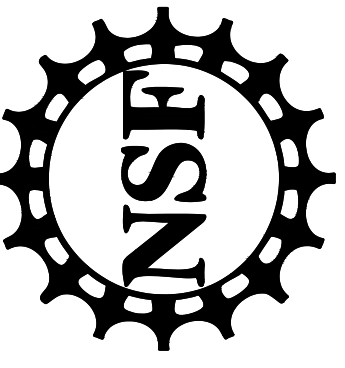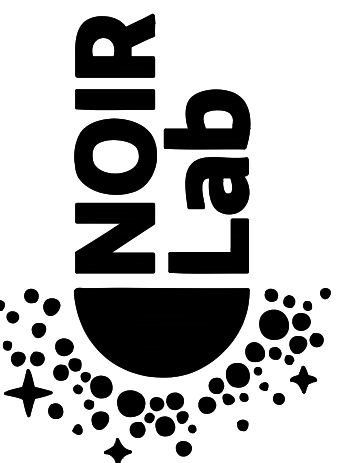SCALE: 1/4" = 1'-0"



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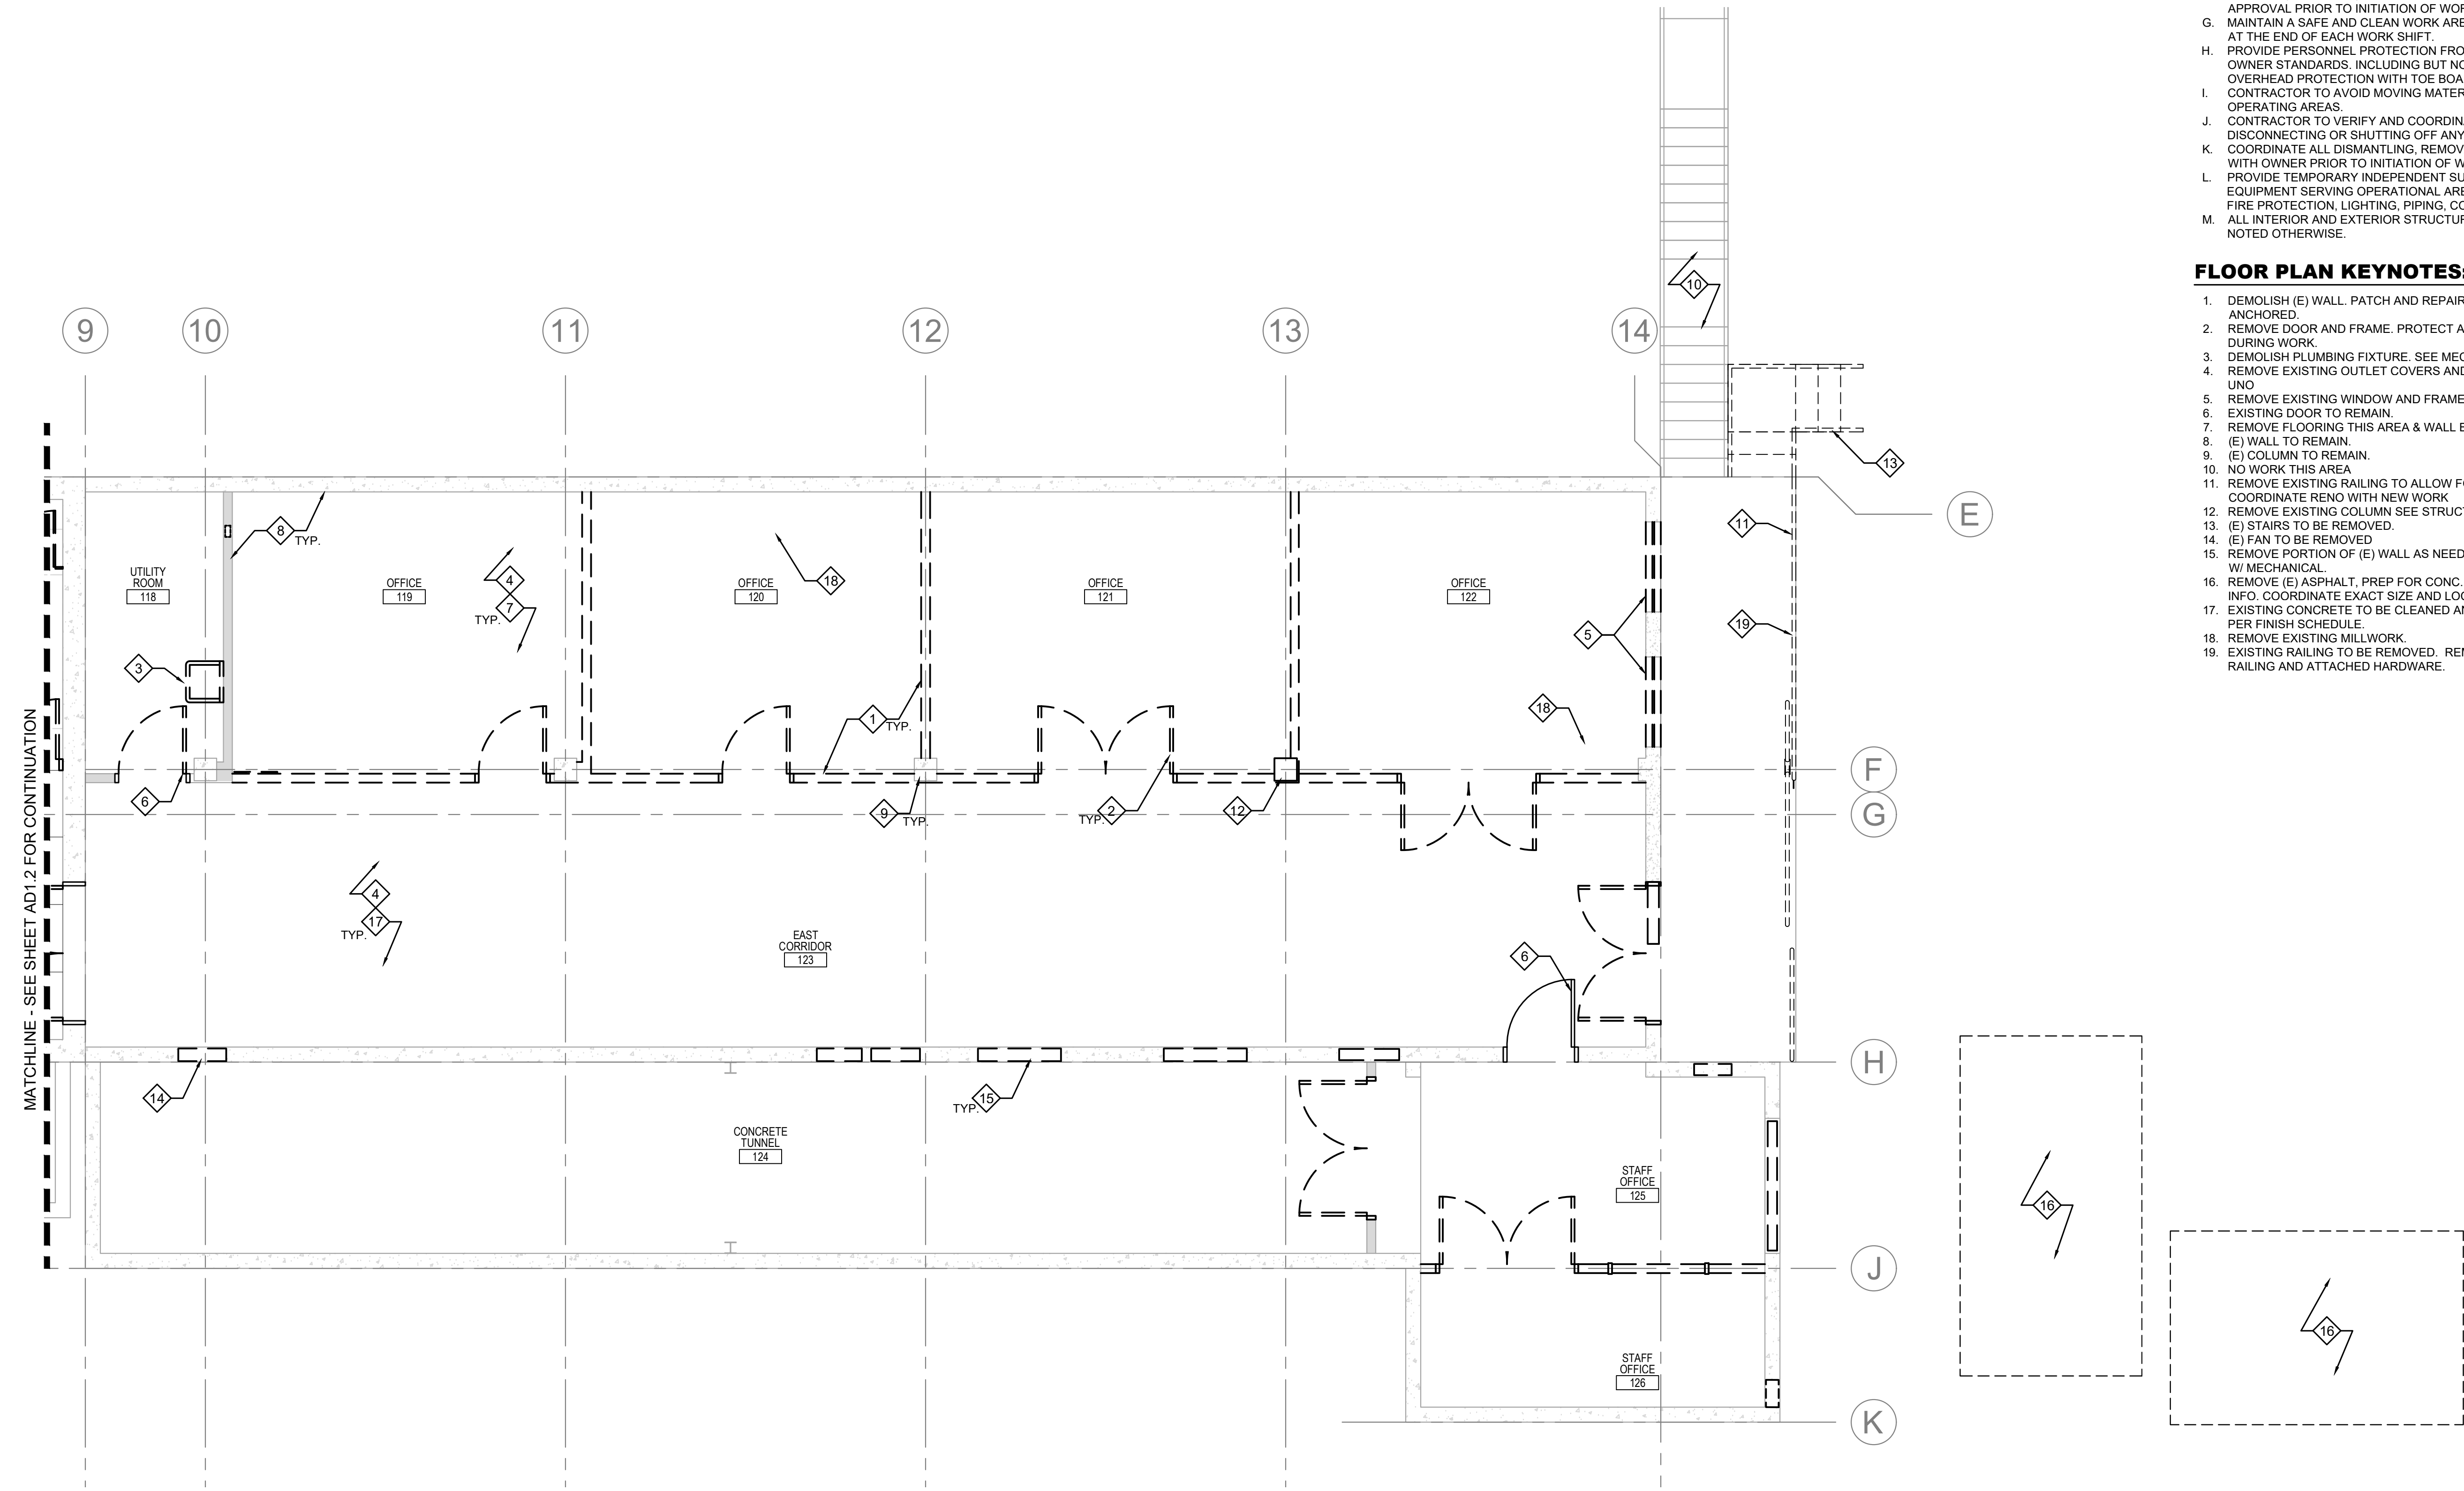
KITT PEAK - Sells, AZ 85634

DEMOLITION GENERAL NOTES:

- A. REFER TO THE ENTIRE SET FOR ADDITIONAL INFORMATION AND REQUIREMENTS.
- B. COORDINATE ALL WORK WITH STRUCTURAL, ELECTRICAL, MECHANICAL DRAWINGS & OTHER DISCIPLINES INVOLVED.
- C. VERIFY ALL FIELD CONDITIONS & DIMENSIONS, NOTIFY ARCHITECT OF ANY DISCREPANCIES PRIOR TO COMMENCEMENT OF WORK.
- D. UNLESS NOTED OTHERWISE, ALL WORK DESCRIBED SHALL BE PERFORMED BY CONTRACTOR. FOR ITEMS REQUIRING OWNER DIRECTION, CONTRACTOR SHALL COORDINATE DIRECTLY WITH OWNER. THIS INCLUDES BUT IS NOT LIMITED TO FURNITURE RELOCATION, EQUIPMENT RELOCATION, I.T. ITEMS, ETC.
- E. DO NOT SCALE DRAWINGS. IF DIMENSIONS ARE NOT PROVIDED, CONTACT ARCHITECT FOR CLARIFICATION.
- F. CONTRACTOR TO PROVIDE DETAILED PHASING, DEBRIS, DUST CONTROL METHODS, ISOLATION, AND ACCESS TO RESTROOMS TO OWNER FOR APPROVAL PRIOR TO INITIATION OF WORK.
- G. MAINTAIN A SAFE AND CLEAN WORK AREA - REMOVE ALL TRASH AND DEBRIS AT THE END OF EACH WORK SHIFT.
- H. PROVIDE PERSONNEL PROTECTION FROM DEBRIS & MATERIAL FALL PER OWNER STANDARDS, INCLUDING BUT NOT LIMITED TO SCAFFOLDING FOR OVERHEAD PROTECTION WITH TOE BOARDS, & VISQUEEN DUST BARRIER.
- I. CONTRACTOR TO AVOID MOVING MATERIALS OR TOOLS THROUGH OPERATING AREAS.
- J. CONTRACTOR TO VERIFY AND COORDINATE WITH OWNER BEFORE DISCONNECTING OR SHUTTING OFF ANY UTILITIES DURING CONSTRUCTION.
- K. COORDINATE ALL DISMANTLING, REMOVALS, STAGING, AND OTHER WORK WITH OWNER PRIOR TO INITIATION OF WORK.
- L. PROVIDE TEMPORARY INDEPENDENT SUPPORT FOR SYSTEMS AND EQUIPMENT SERVING OPERATIONAL AREAS, INCLUDING BUT NOT LIMITED TO: FIRE PROTECTION, LIGHTING, PIPING, CONDUITS, ETC.
- M. ALL INTERIOR AND EXTERIOR STRUCTURE IS EXISTING TO REMAIN UNLESS NOTED OTHERWISE.

FLOOR PLAN KEYNOTES:

- 1. DEMOLISH (E) WALL. PATCH AND REPAIR ADJACENT WALL WHERE ANCHORED.
- 2. REMOVE DOOR AND FRAME. PROTECT ADJACENT WALLS FROM DAMAGE DURING WORK.
- 3. DEMOLISH PLUMBING FIXTURE. SEE MECHANICAL SHEETS.
- 4. REMOVE EXISTING OUTLET COVERS AND LIGHT FIXTURE SWITCH PLATES UNO.
- 5. REMOVE EXISTING WINDOW AND FRAME AS SHOWN.
- 6. EXISTING DOOR TO REMAIN.
- 7. REMOVE FLOORING THIS AREA & WALL BASE UNO.
- 8. (E) WALL TO REMAIN.
- 9. (E) COLUMN TO REMAIN.
- 10. NO WORK THIS AREA.
- 11. REMOVE EXISTING RAILING TO ALLOW FOR NEW CONSTRUCTION. COORDINATE RENO WITH NEW WORK.
- 12. REMOVE EXISTING COLUMN SEE STRUCTURAL.
- 13. (E) STAIRS TO BE REMOVED.
- 14. (E) FAN TO BE REMOVED.
- 15. REMOVE PORTION OF (E) WALL AS NEEDED FOR MECHANICAL. COORDINATE W/ MECHANICAL.
- 16. REMOVE (E) ASPHALT, PREP FOR CONC. SLAB. SEE MECHANICAL FOR MORE INFO. COORDINATE EXACT SIZE AND LOCATION PER MECHANICAL DRAWINGS.
- 17. EXISTING CONCRETE TO BE CLEANED AND PREPARED FOR NEW FLOORING PER FINISH SCHEDULE.
- 18. REMOVE EXISTING MILLWORK.
- 19. EXISTING RAILING TO BE REMOVED. REMOVE ALL ASSOCIATED FLOOR RAILING AND ATTACHED HARDWARE.



1 ARCHITECTURAL ENLARGED DEMO FLOOR PLAN - AREA C
1ST. LEVEL


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DATE	DESCRIPTION
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PROJECT NUMBER: 11904.00
DRAWN BY:
CHECKED BY: IR
CAD FILE: 11904.00-AD1.3
SCALE: AS NOTED

ENLARGED DEMO
FLOOR PLAN
AREA C

AD1.3



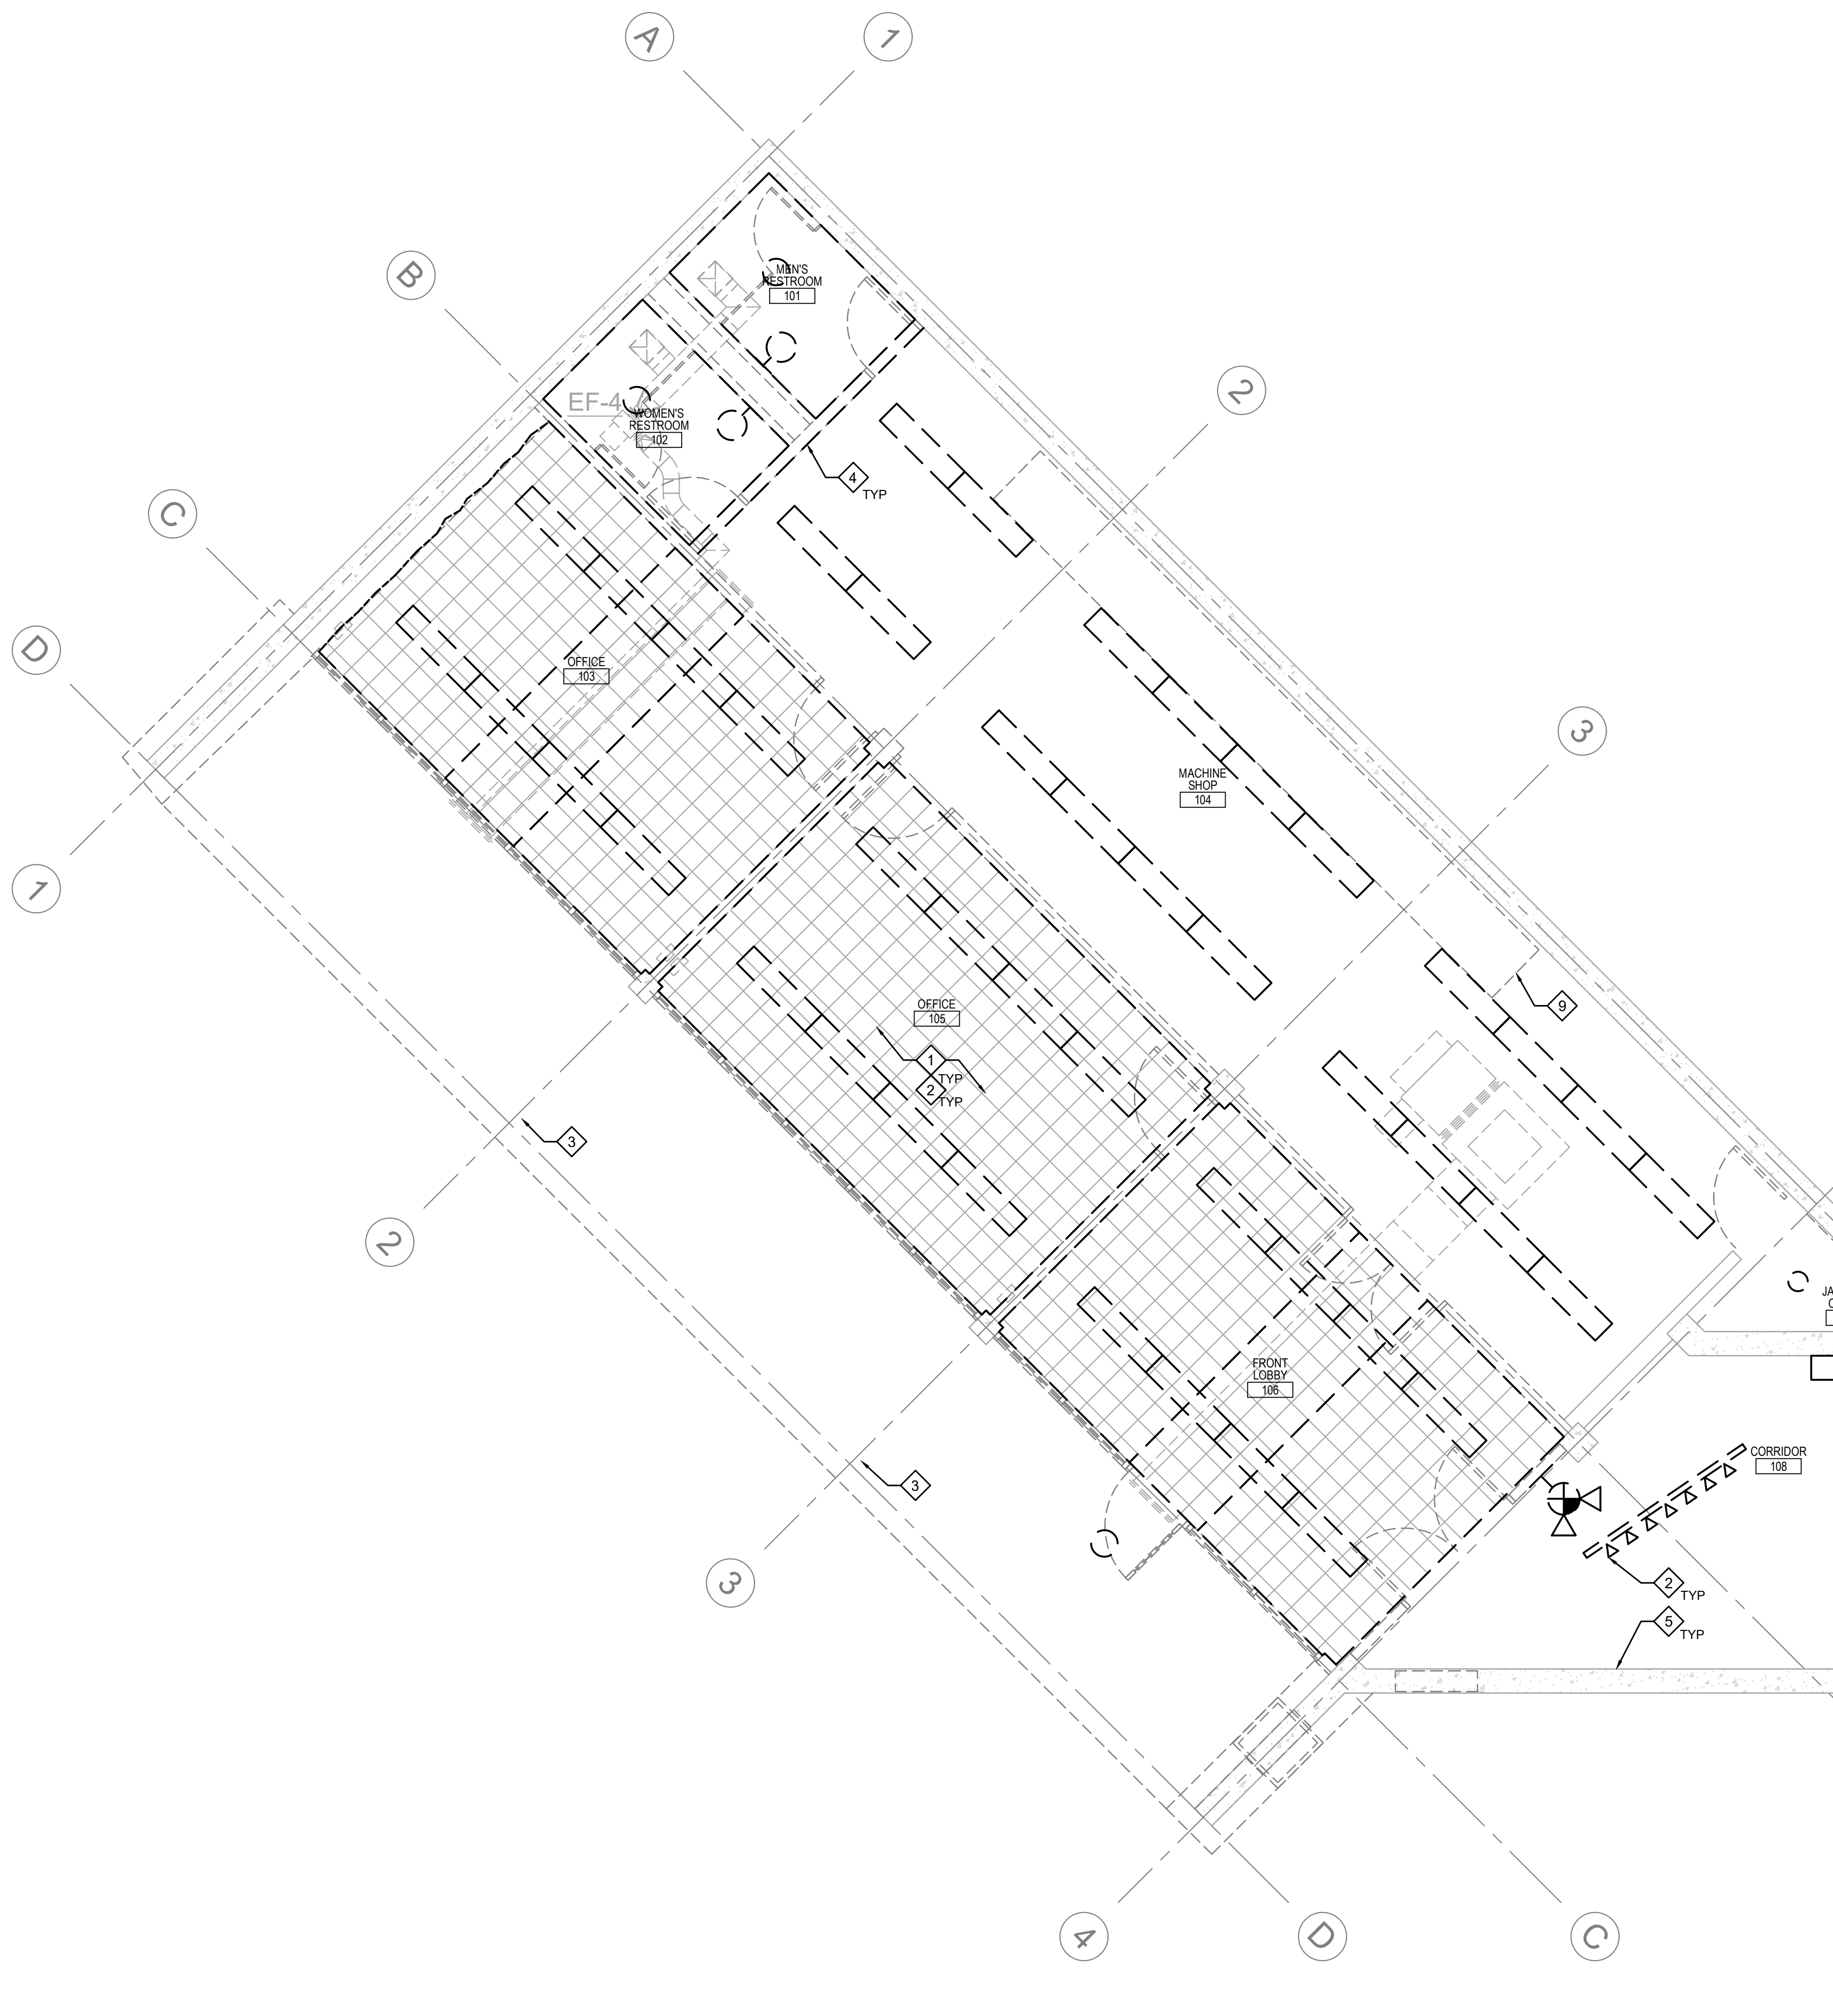1 ARCHITECTURAL ENLARGED DEMO REFLECTED CEILING PLAN - AREA A
1ST. LEVEL


SCALE: 1/4" = 1'-0"

RCP KEYNOTES:

1. REMOVE EXISTING DROP CEILING SYSTEM. REMOVE ALL ABANDONED COMPONENTS. PREP FOR NEW FINISH. SEE RENOVATION RCP.
2. REMOVE LIGHTING, CONDUITS, AND SWITCHING. SEE ELECTRICAL.
3. EXISTING SCUPPER TO REMAIN.
4. DEMOLISHED WALL BELOW. SHOWN FOR REFERENCE.
5. EXISTING WALL TO REMAIN. SHOWN FOR REFERENCE.
6. REMOVE FRAMED SOFFIT POP-OUT COORDINATE WITH ELECTRICAL.
7. PREP CEILING FOR FINISH PER FINISH SCHEDULE.
8. EXISTING EQUIPMENT TO REMAIN. PROTECT DURING CONSTRUCTION.
9. REMOVE EXISTING MILLWORK.

DEMOLITION GENERAL NOTES:

- A. REFER TO THE ENTIRE SET FOR ADDITIONAL INFORMATION AND REQUIREMENTS.
- B. COORDINATE ALL WORK WITH STRUCTURAL, ELECTRICAL, MECHANICAL DRAWINGS & OTHER DISCIPLINES INVOLVED.
- C. VERIFY ALL FIELD CONDITIONS & DIMENSIONS, NOTIFY ARCHITECT OF ANY DISCREPANCIES PRIOR TO COMMENCEMENT OF WORK.
- D. UNLESS NOTED OTHERWISE, ALL WORK DESCRIBED SHALL BE PERFORMED BY CONTRACTOR. FOR ITEMS REQUIRING OWNER DIRECTION, CONTRACTOR SHALL COORDINATE DIRECTLY WITH OWNER. THIS INCLUDES BUT IS NOT LIMITED TO FURNITURE RELOCATION, EQUIPMENT RELOCATION, I.T. ITEMS, ETC.
- E. DO NOT SCALE DRAWINGS, IF DIMENSIONS ARE NOT PROVIDED, CONTACT ARCHITECT FOR CLARIFICATION.
- F. CONTRACTOR TO PROVIDE DETAILED PHASING, DEBRIS, DUST CONTROL METHODS, ISOLATION, AND ACCESS TO RESTROOMS TO OWNER FOR APPROVAL PRIOR TO INITIATION OF WORK.
- G. MAINTAIN A SAFE AND CLEAN WORK AREA - REMOVE ALL TRASH AND DEBRIS AT THE END OF EACH WORK SHIFT.
- H. PROVIDE PERSONNEL PROTECTION FROM DEBRIS & MATERIAL FALL PER OWNER STANDARDS. INCLUDING BUT NOT LIMITED TO SCAFFOLDING FOR OVERHEAD PROTECTION WITH TOE BOARDS, & VISQUEEN DUST BARRIER.
- I. CONTRACTOR TO AVOID MOVING MATERIALS OR TOOLS THROUGH OPERATING AREAS.
- J. CONTRACTOR TO VERIFY AND COORDINATE WITH OWNER BEFORE DISCONNECTING OR SHUTTING OFF ANY UTILITIES DURING CONSTRUCTION.
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- L. PROVIDE TEMPORARY INDEPENDENT SUPPORT FOR SYSTEMS AND EQUIPMENT SERVING OPERATIONAL AREAS, INCLUDING BUT NOT LIMITED TO: FIRE PROTECTION, LIGHTING, PIPING, CONDUITS, ETC.
- M. ALL INTERIOR AND EXTERIOR STRUCTURE IS EXISTING TO REMAIN UNLESS NOTED OTHERWISE.

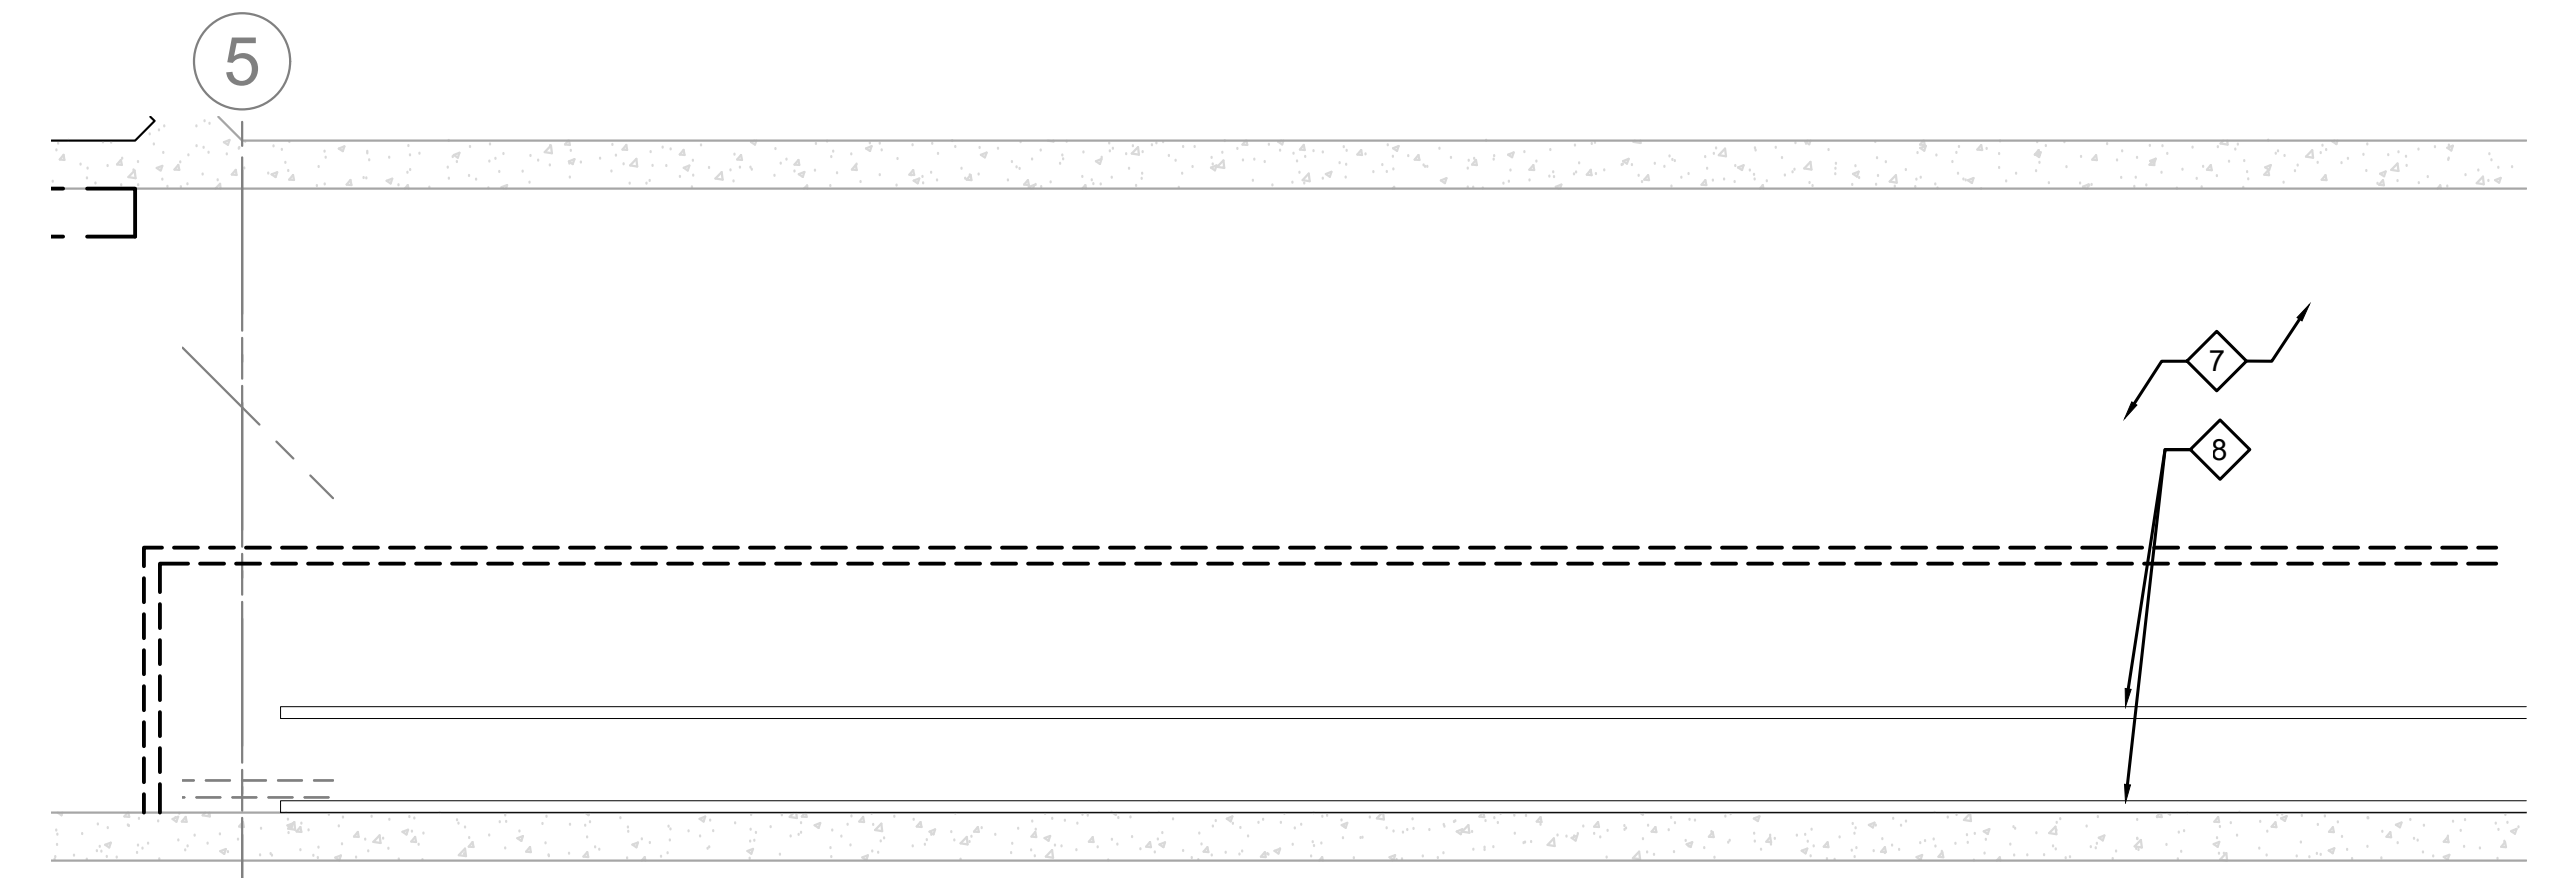

2 ARCHITECTURAL DEMO RCP - AREA A
MEZZANINE LEVEL

SCALE: 1/4" = 1'-0"

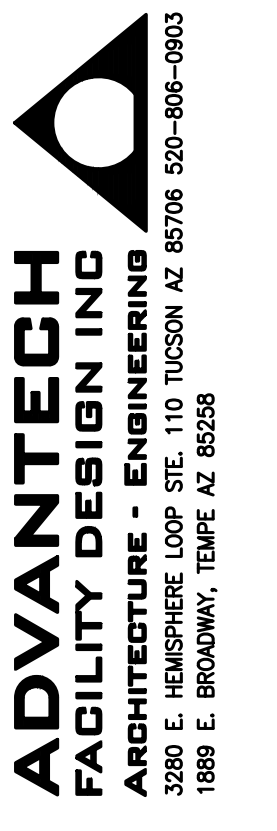
MATCHLINE - SEE SHEET AD2.2 FOR CONTINUATION

△	DATE	DESCRIPTION
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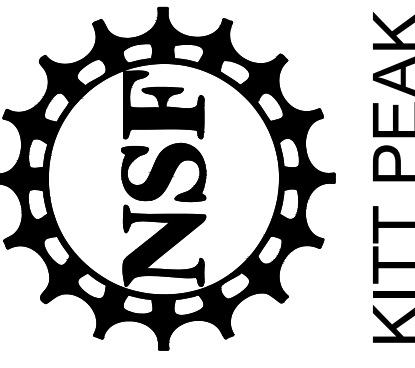
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 CAD FILE: 11904.00-AD2.1
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ENLARGED DEMO
 REFLECTED CEILING
 AREA A


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WINDOWS ON
 THE UNIVERSE
 CENTER FOR
 ASTRONOMY
 OUTREACH





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PROJECT NUMBER: 11904.00
DRAWN BY:
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SCALE: AS NOTED

ENLARGED DEMO
REFLECTED CEILING
AREA B


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- E. DO NOT SCALE DRAWINGS. IF DIMENSIONS ARE NOT PROVIDED, CONTACT ARCHITECT FOR CLARIFICATION.
- F. CONTRACTOR TO PROVIDE DETAILED PHASING, DEBRIS, DUST CONTROL METHODS, ISOLATION, AND ACCESS TO RESTROOMS TO OWNER FOR APPROVAL PRIOR TO INITIATION OF WORK.
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- J. CONTRACTOR TO VERIFY AND COORDINATE WITH OWNER BEFORE DISCONNECTING OR SHUTTING OFF ANY UTILITIES DURING CONSTRUCTION. COORDINATE ALL DISMANTLING, REMOVALS, STAGING, AND OTHER WORK WITH OWNER PRIOR TO INITIATION OF WORK.
- L. PROVIDE TEMPORARY INDEPENDENT SUPPORT FOR SYSTEMS AND EQUIPMENT SERVING OPERATIONAL AREAS, INCLUDING BUT NOT LIMITED TO: FIRE PROTECTION, LIGHTING, PIPING, CONDUITS, ETC.
- M. ALL INTERIOR AND EXTERIOR STRUCTURE IS EXISTING TO REMAIN UNLESS NOTED OTHERWISE.

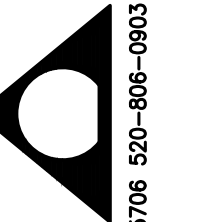RCP KEYNOTES

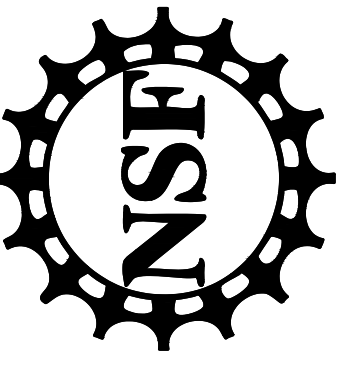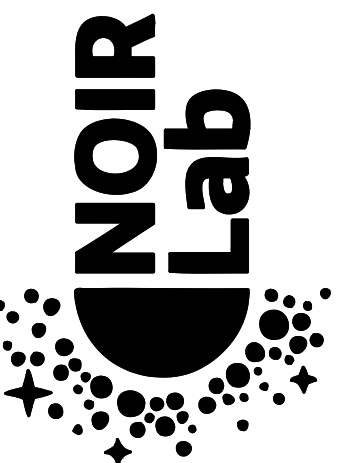- 1. REMOVE EXISTING MEZZANINE AND STRUCTURE.
- 2. REMOVE LIGHTING, CONDUITS, AND SWITCHING. SEE ELECTRICAL.
- 3. PREP EXISTING CEILING FOR NEW PAINT. SEE RENOVATION PLANS.
- 4. VIEW PORTALS TO BE PROTECTED DURING CONSTRUCTION.
- 5. CEILING EQUIPMENT TO REMAIN. PROTECT IN PLACE.
- 6. EXISTING WALL HUNG EQUIPMENT TO REMAIN. PROTECT DURING CONSTRUCTION.
- 7. REMOVE EXISTING MEZZANINE WALL.
- 8. EXISTING WALL TO REMAIN. SHOWN FOR REFERENCE.
- 9. DEMOLISHED WALL BELOW. SHOWN FOR REFERENCE.
- 10. EXISTING CABLING TO REMAIN. PROTECT IN PLACE.
- 11. REMOVE EXISTING DROP CEILING SYSTEM.
- 12. REMOVE EXISTING MILLWORK.



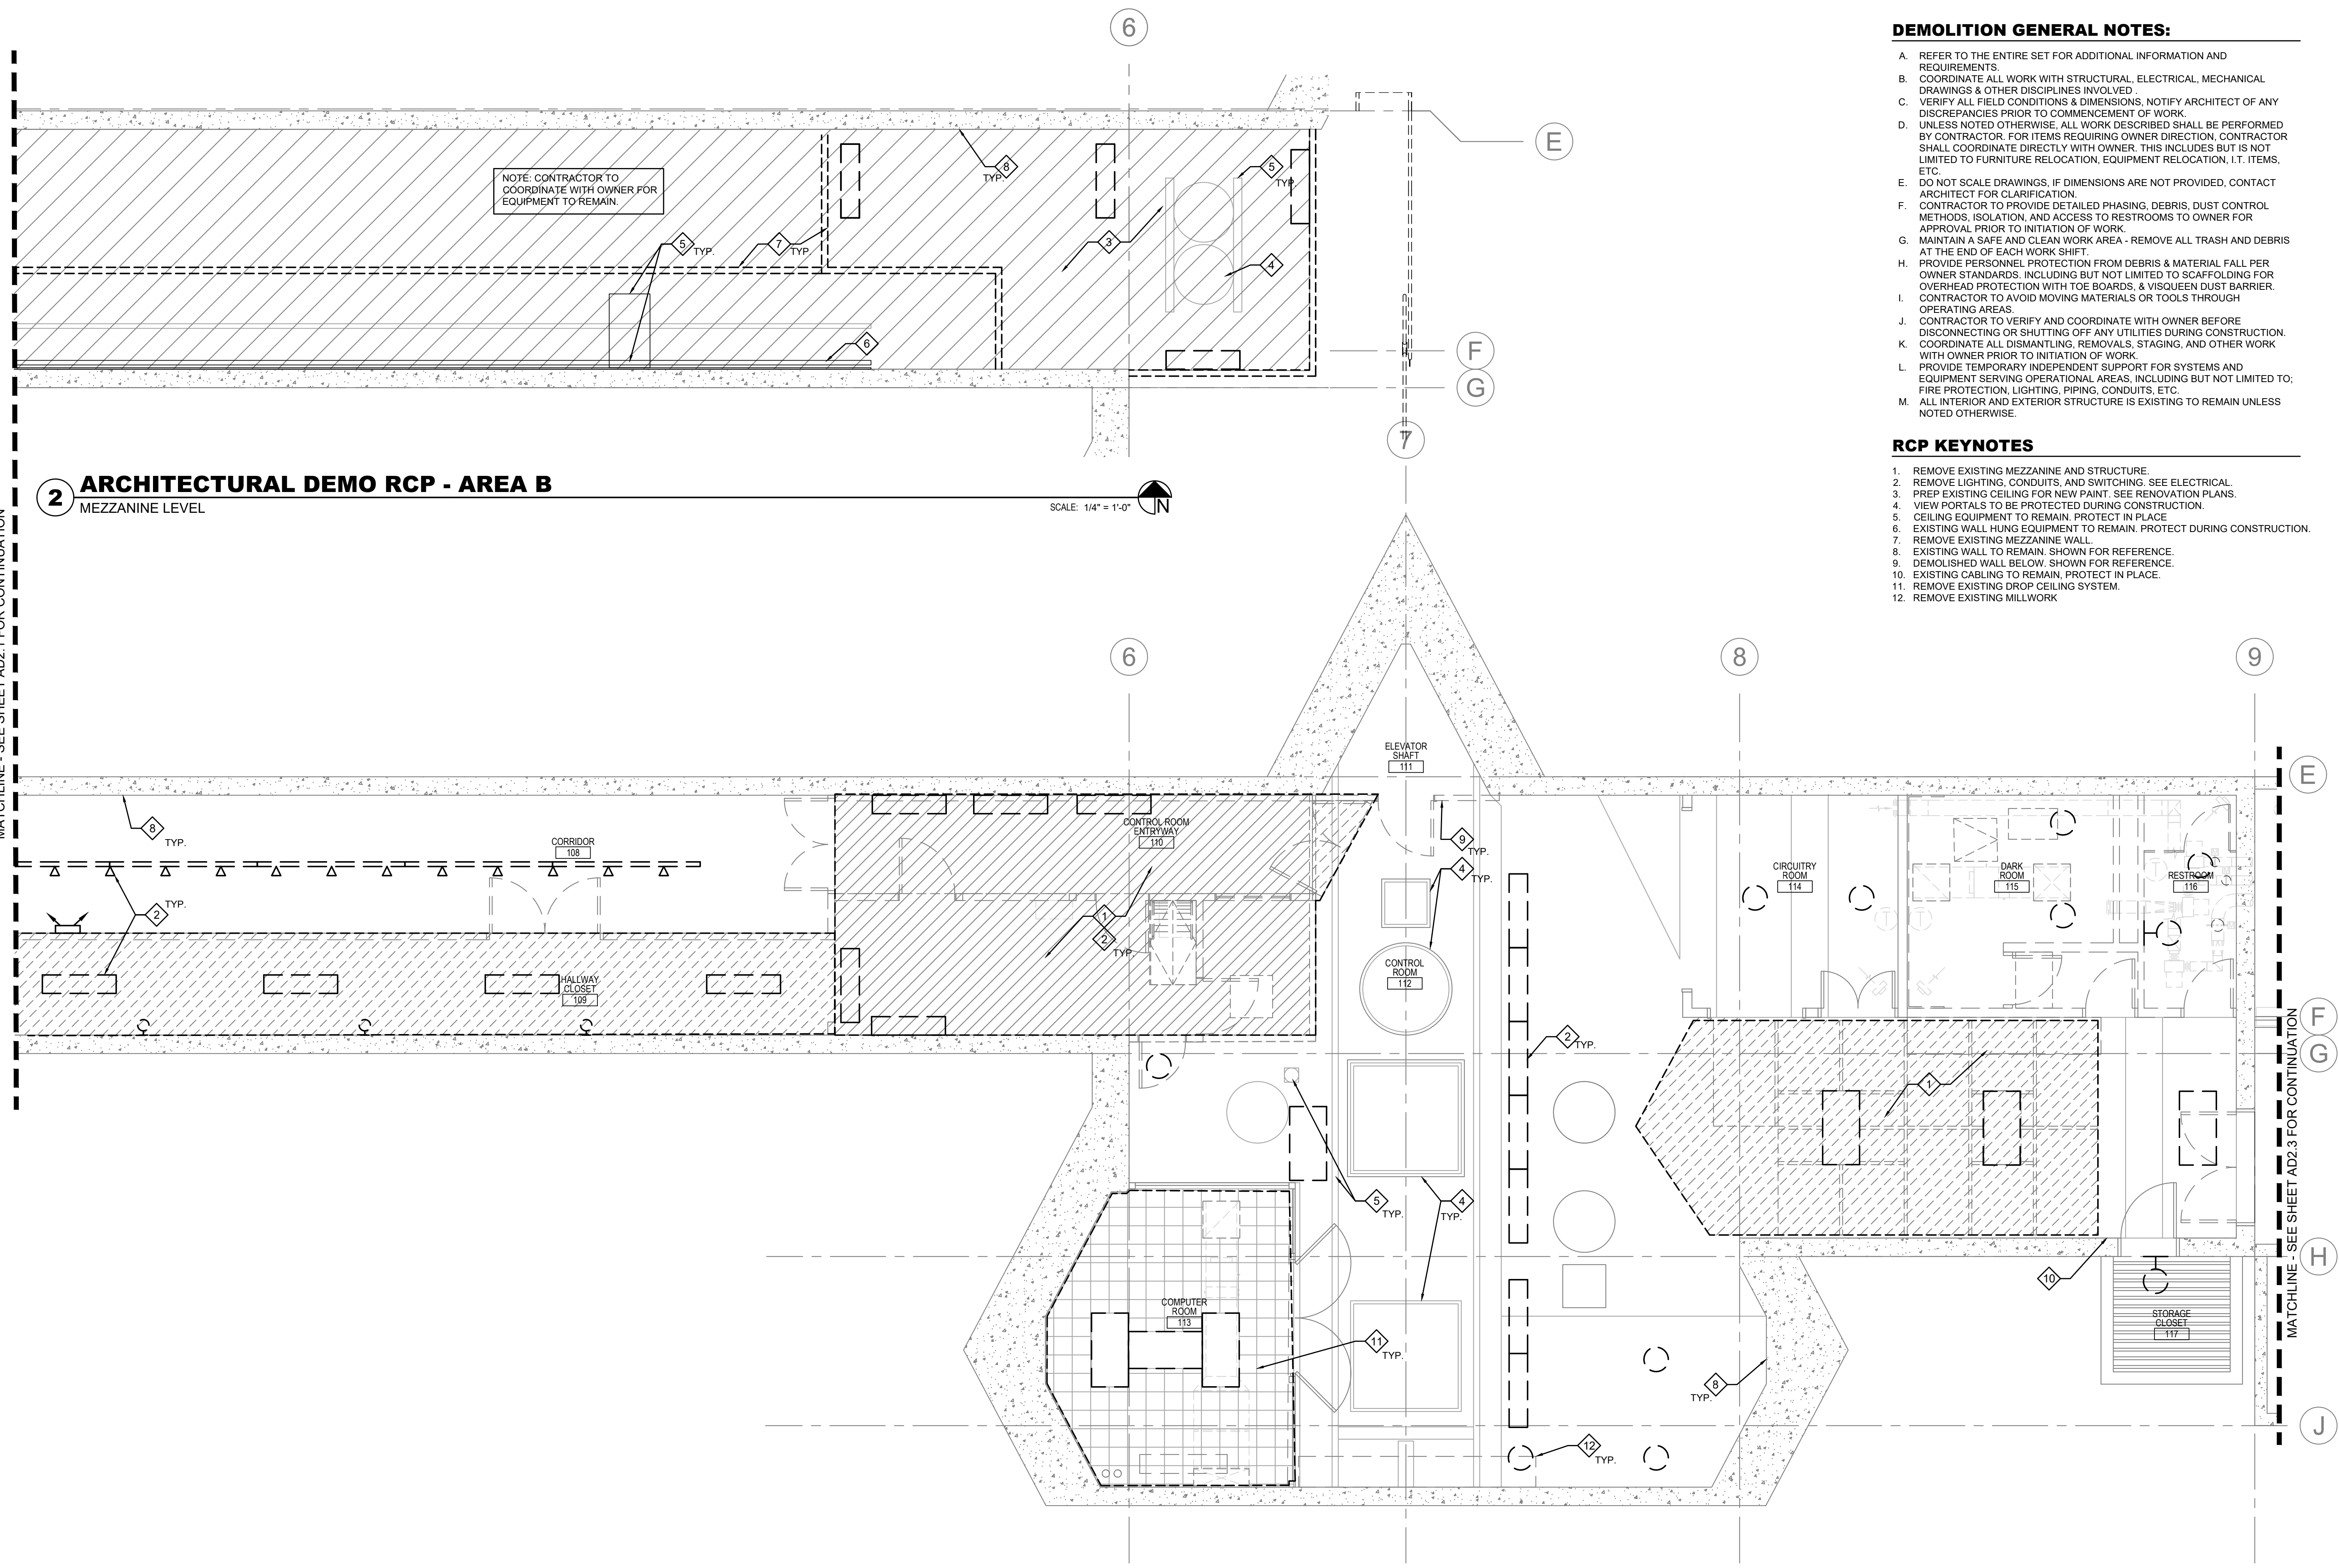
2 ARCHITECTURAL DEMO RCP - AREA B
MEZZANINE LEVEL

1 ARCHITECTURAL ENLARGED DEMO REFLECTED CEILING PLAN - AREA B
1ST. LEVEL

MATCHLINE - SEE SHEET AD2.1 FOR CONTINUATION

MATCHLINE - SEE SHEET AD2.3 FOR CONTINUATION

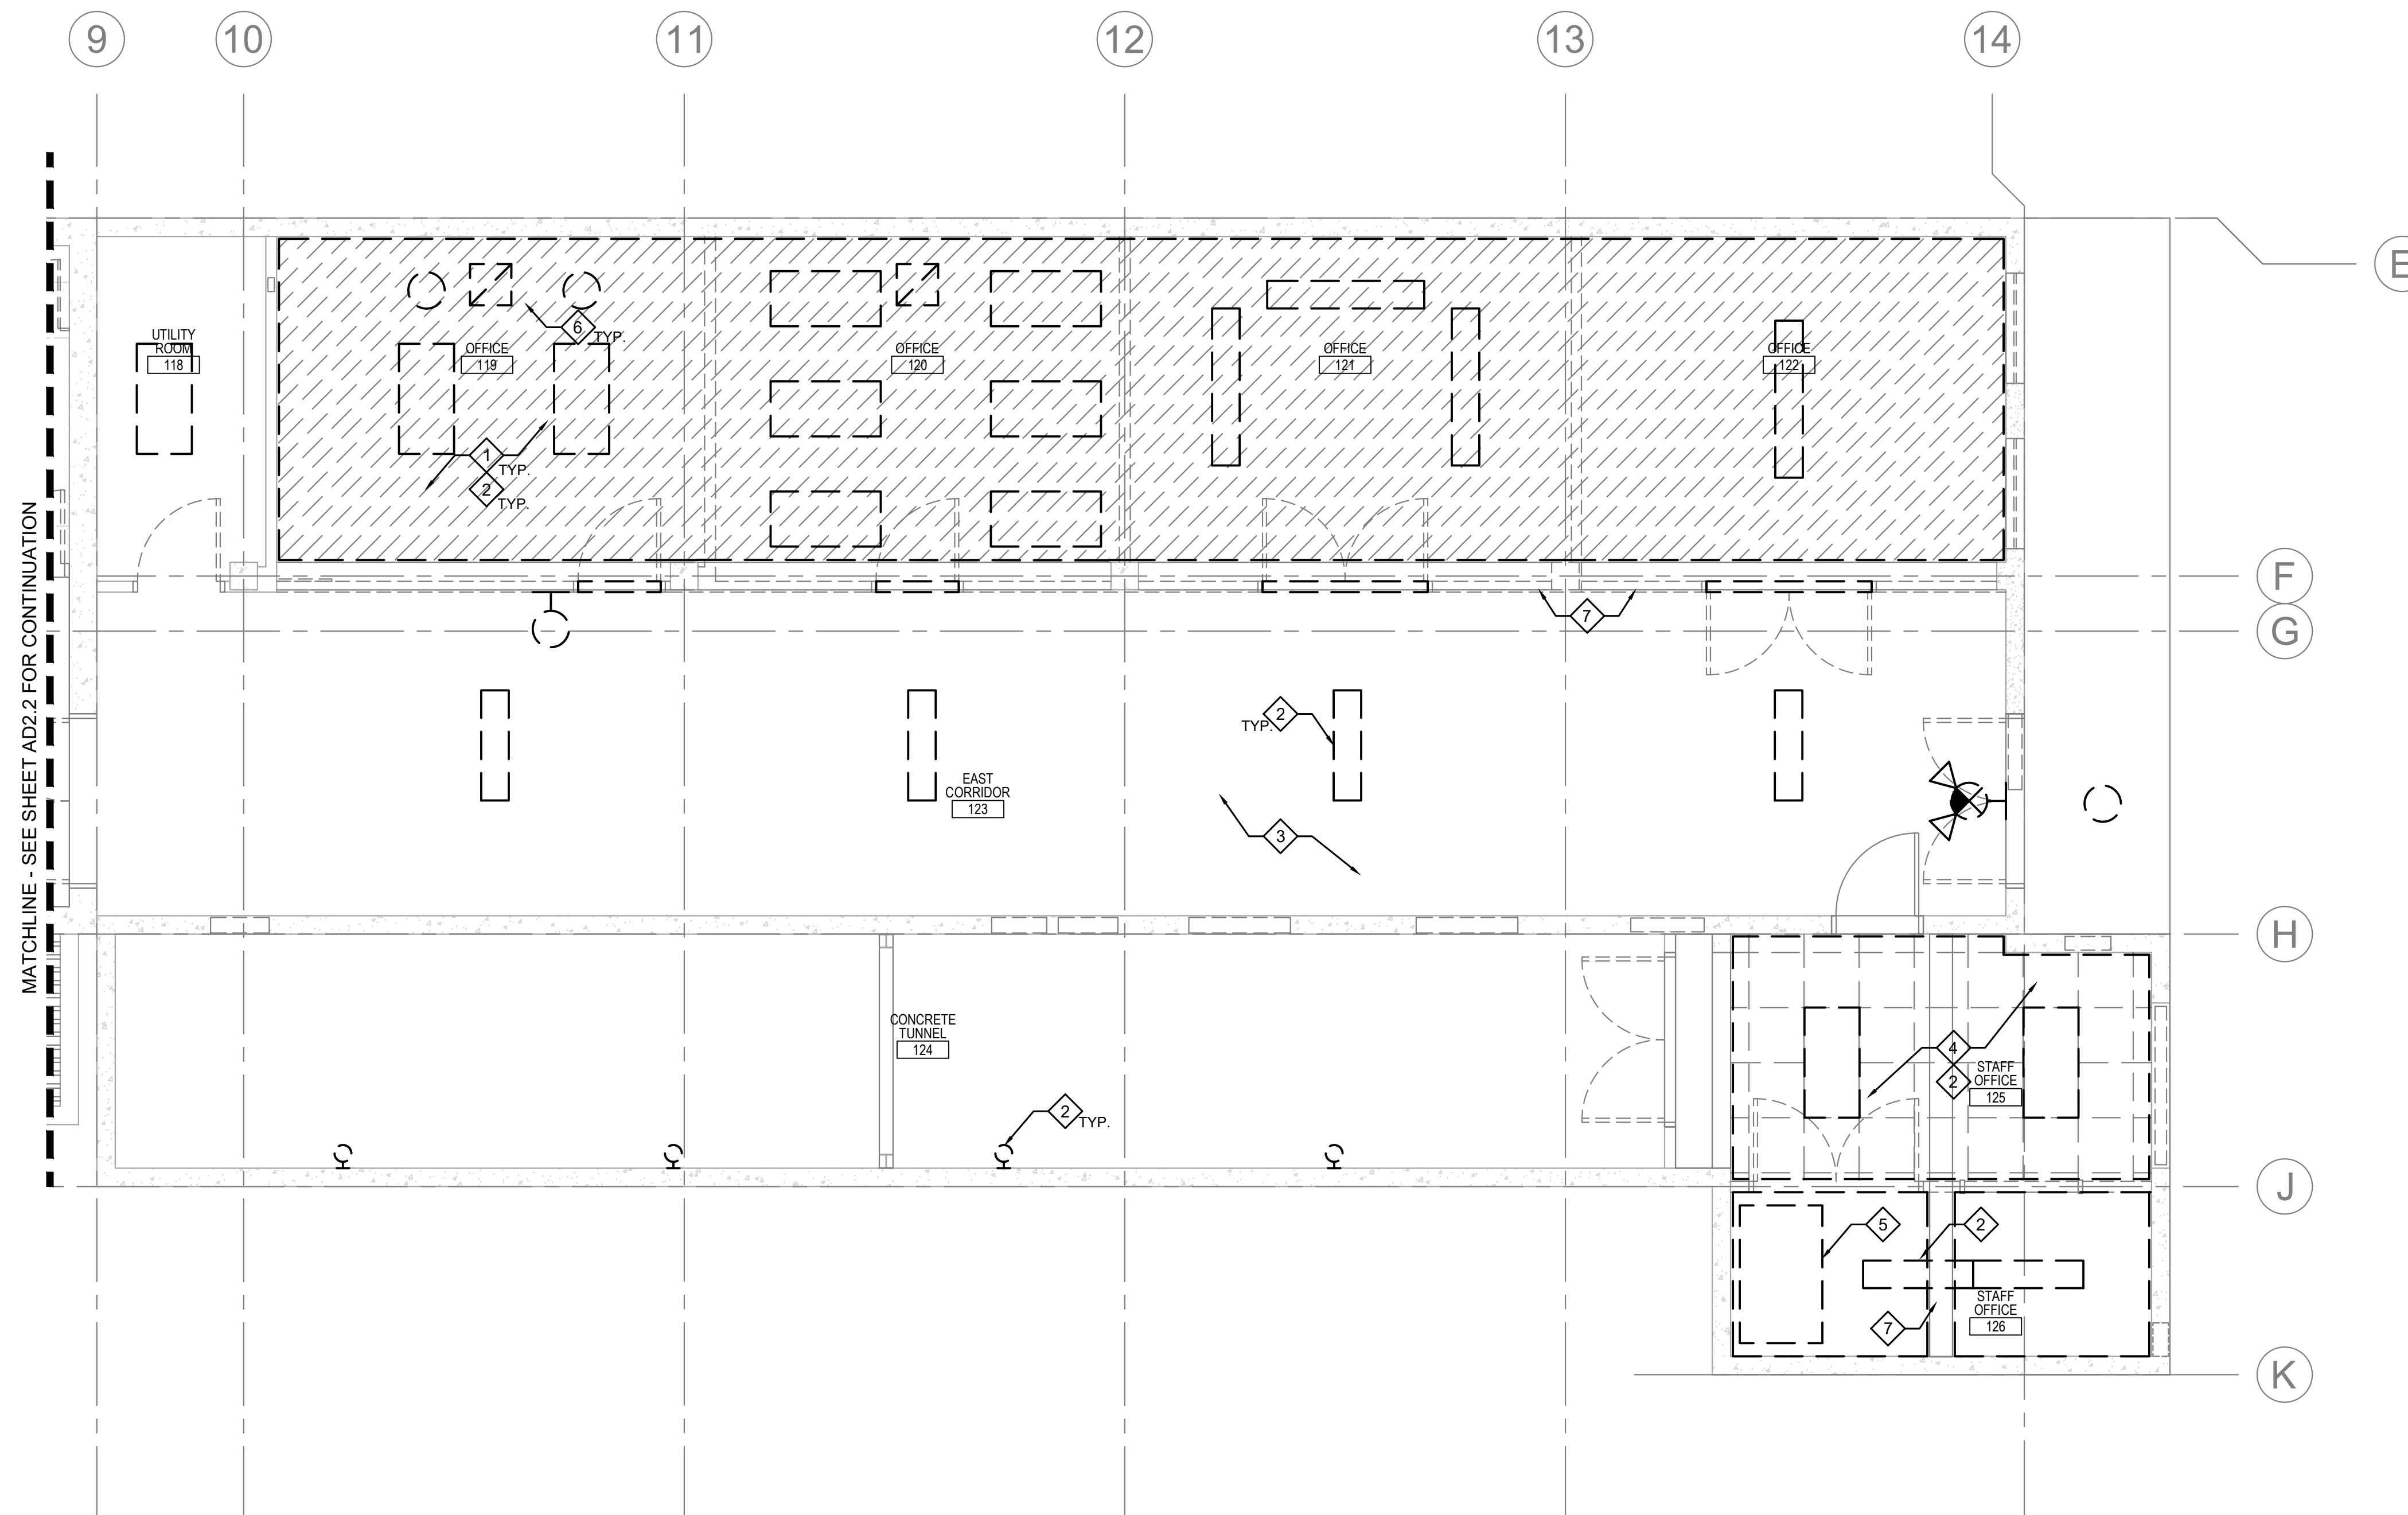SCALE: 1/4" = 1'-0"



1 ARCHITECTURAL ENLARGED DEMO REFLECTED CEILING PLAN - AREA C
1ST. LEVEL

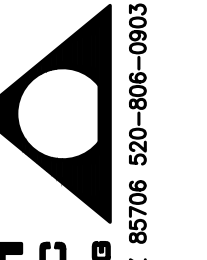
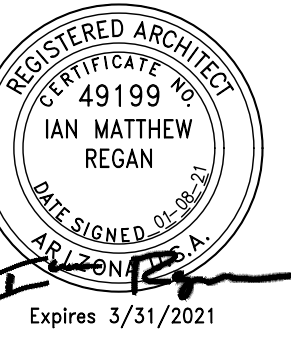
SCALE: 1/4" = 1'-0"

DEMOLITION GENERAL NOTES:

- A. REFER TO THE ENTIRE SET FOR ADDITIONAL INFORMATION AND REQUIREMENTS.
- B. COORDINATE ALL WORK WITH STRUCTURAL, ELECTRICAL, MECHANICAL DRAWINGS & OTHER DISCIPLINES INVOLVED.
- C. VERIFY ALL FIELD CONDITIONS & DIMENSIONS, NOTIFY ARCHITECT OF ANY DISCREPANCIES PRIOR TO COMMENCEMENT OF WORK.
- D. UNLESS NOTED OTHERWISE, ALL WORK DESCRIBED SHALL BE PERFORMED BY CONTRACTOR. FOR ITEMS REQUIRING OWNER DIRECTION, CONTRACTOR SHALL COORDINATE DIRECTLY WITH OWNER. THIS INCLUDES BUT IS NOT LIMITED TO FURNITURE RELOCATION, EQUIPMENT RELOCATION, I.T. ITEMS, ETC.
- E. DO NOT SCALE DRAWINGS; IF DIMENSIONS ARE NOT PROVIDED, CONTACT ARCHITECT FOR CLARIFICATION.
- F. CONTRACTOR TO PROVIDE DETAILED PHASING, DEBRIS, DUST CONTROL METHODS, ISOLATION, AND ACCESS TO RESTROOMS TO OWNER FOR APPROVAL PRIOR TO INITIATION OF WORK.
- G. MAINTAIN A SAFE AND CLEAN WORK AREA - REMOVE ALL TRASH AND DEBRIS AT THE END OF EACH WORK SHIFT.
- H. PROVIDE PERSONNEL PROTECTION FROM DEBRIS & MATERIAL FALL PER OWNER STANDARDS, INCLUDING BUT NOT LIMITED TO SCAFFOLDING FOR OVERHEAD PROTECTION WITH TOE BOARDS, & VISQUEEN DUST BARRIER.
- I. CONTRACTOR TO AVOID MOVING MATERIALS OR TOOLS THROUGH OPERATING AREAS.
- J. CONTRACTOR TO VERIFY AND COORDINATE WITH OWNER BEFORE DISCONNECTING OR SHUTTING OFF ANY UTILITIES DURING CONSTRUCTION.
- K. COORDINATE ALL DISMANTLING, REMOVALS, STAGING, AND OTHER WORK WITH OWNER PRIOR TO INITIATION OF WORK.
- L. PROVIDE TEMPORARY INDEPENDENT SUPPORT FOR SYSTEMS AND EQUIPMENT SERVING OPERATIONAL AREAS, INCLUDING BUT NOT LIMITED TO: FIRE PROTECTION, LIGHTING, PIPING, CONDUITS, ETC.
- M. ALL INTERIOR AND EXTERIOR STRUCTURE IS EXISTING TO REMAIN UNLESS NOTED OTHERWISE.



RCP KEYNOTES:

- 1. REMOVE EXISTING GYP BOARD FRAMED CEILING. REMOVE ALL ABANDONED COMPONENTS. PREP FOR NEW FINISH. SEE RENOVATION RCP.
- 2. REMOVE LIGHTING, CONDUITS, AND SWITCHING. SEE ELECTRICAL.
- 3. EXISTING CEILING TO BE PREP'D FOR NEW FINISH.
- 4. REMOVE ACOUSTIC CEILING GRID AND TILE. PREP CEILING FOR NEW FINISH.
- 5. REMOVE EXISTING MECHANICAL AND CONDENSATE PIPE. SEE MECHANICAL.
- 6. EXISTING MECHANICAL TO BE REMOVED. SEE MECHANICAL.
- 7. EXISTING BEAM AND STRUCTURE TO REMAIN. PROTECT DURING CONSTRUCTION.



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WINDOWS ON
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OUTREACH

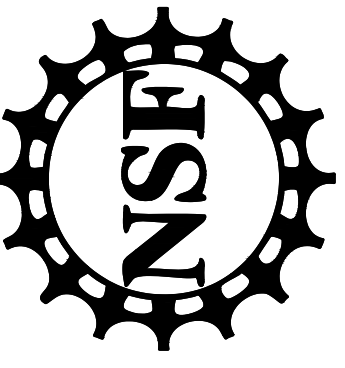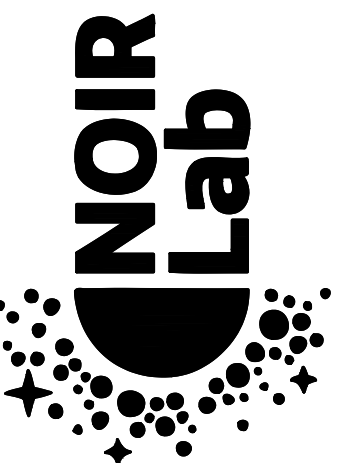


KITT PEAK - Sells, AZ 85634

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PROJECT NUMBER: 11904.00
DRAWN BY:
CHECKED BY: IR
CAD FILE: 11904.00-AD2.3
SCALE: AS NOTED

ENLARGED DEMO
REFLECTED CEILING
AREA C

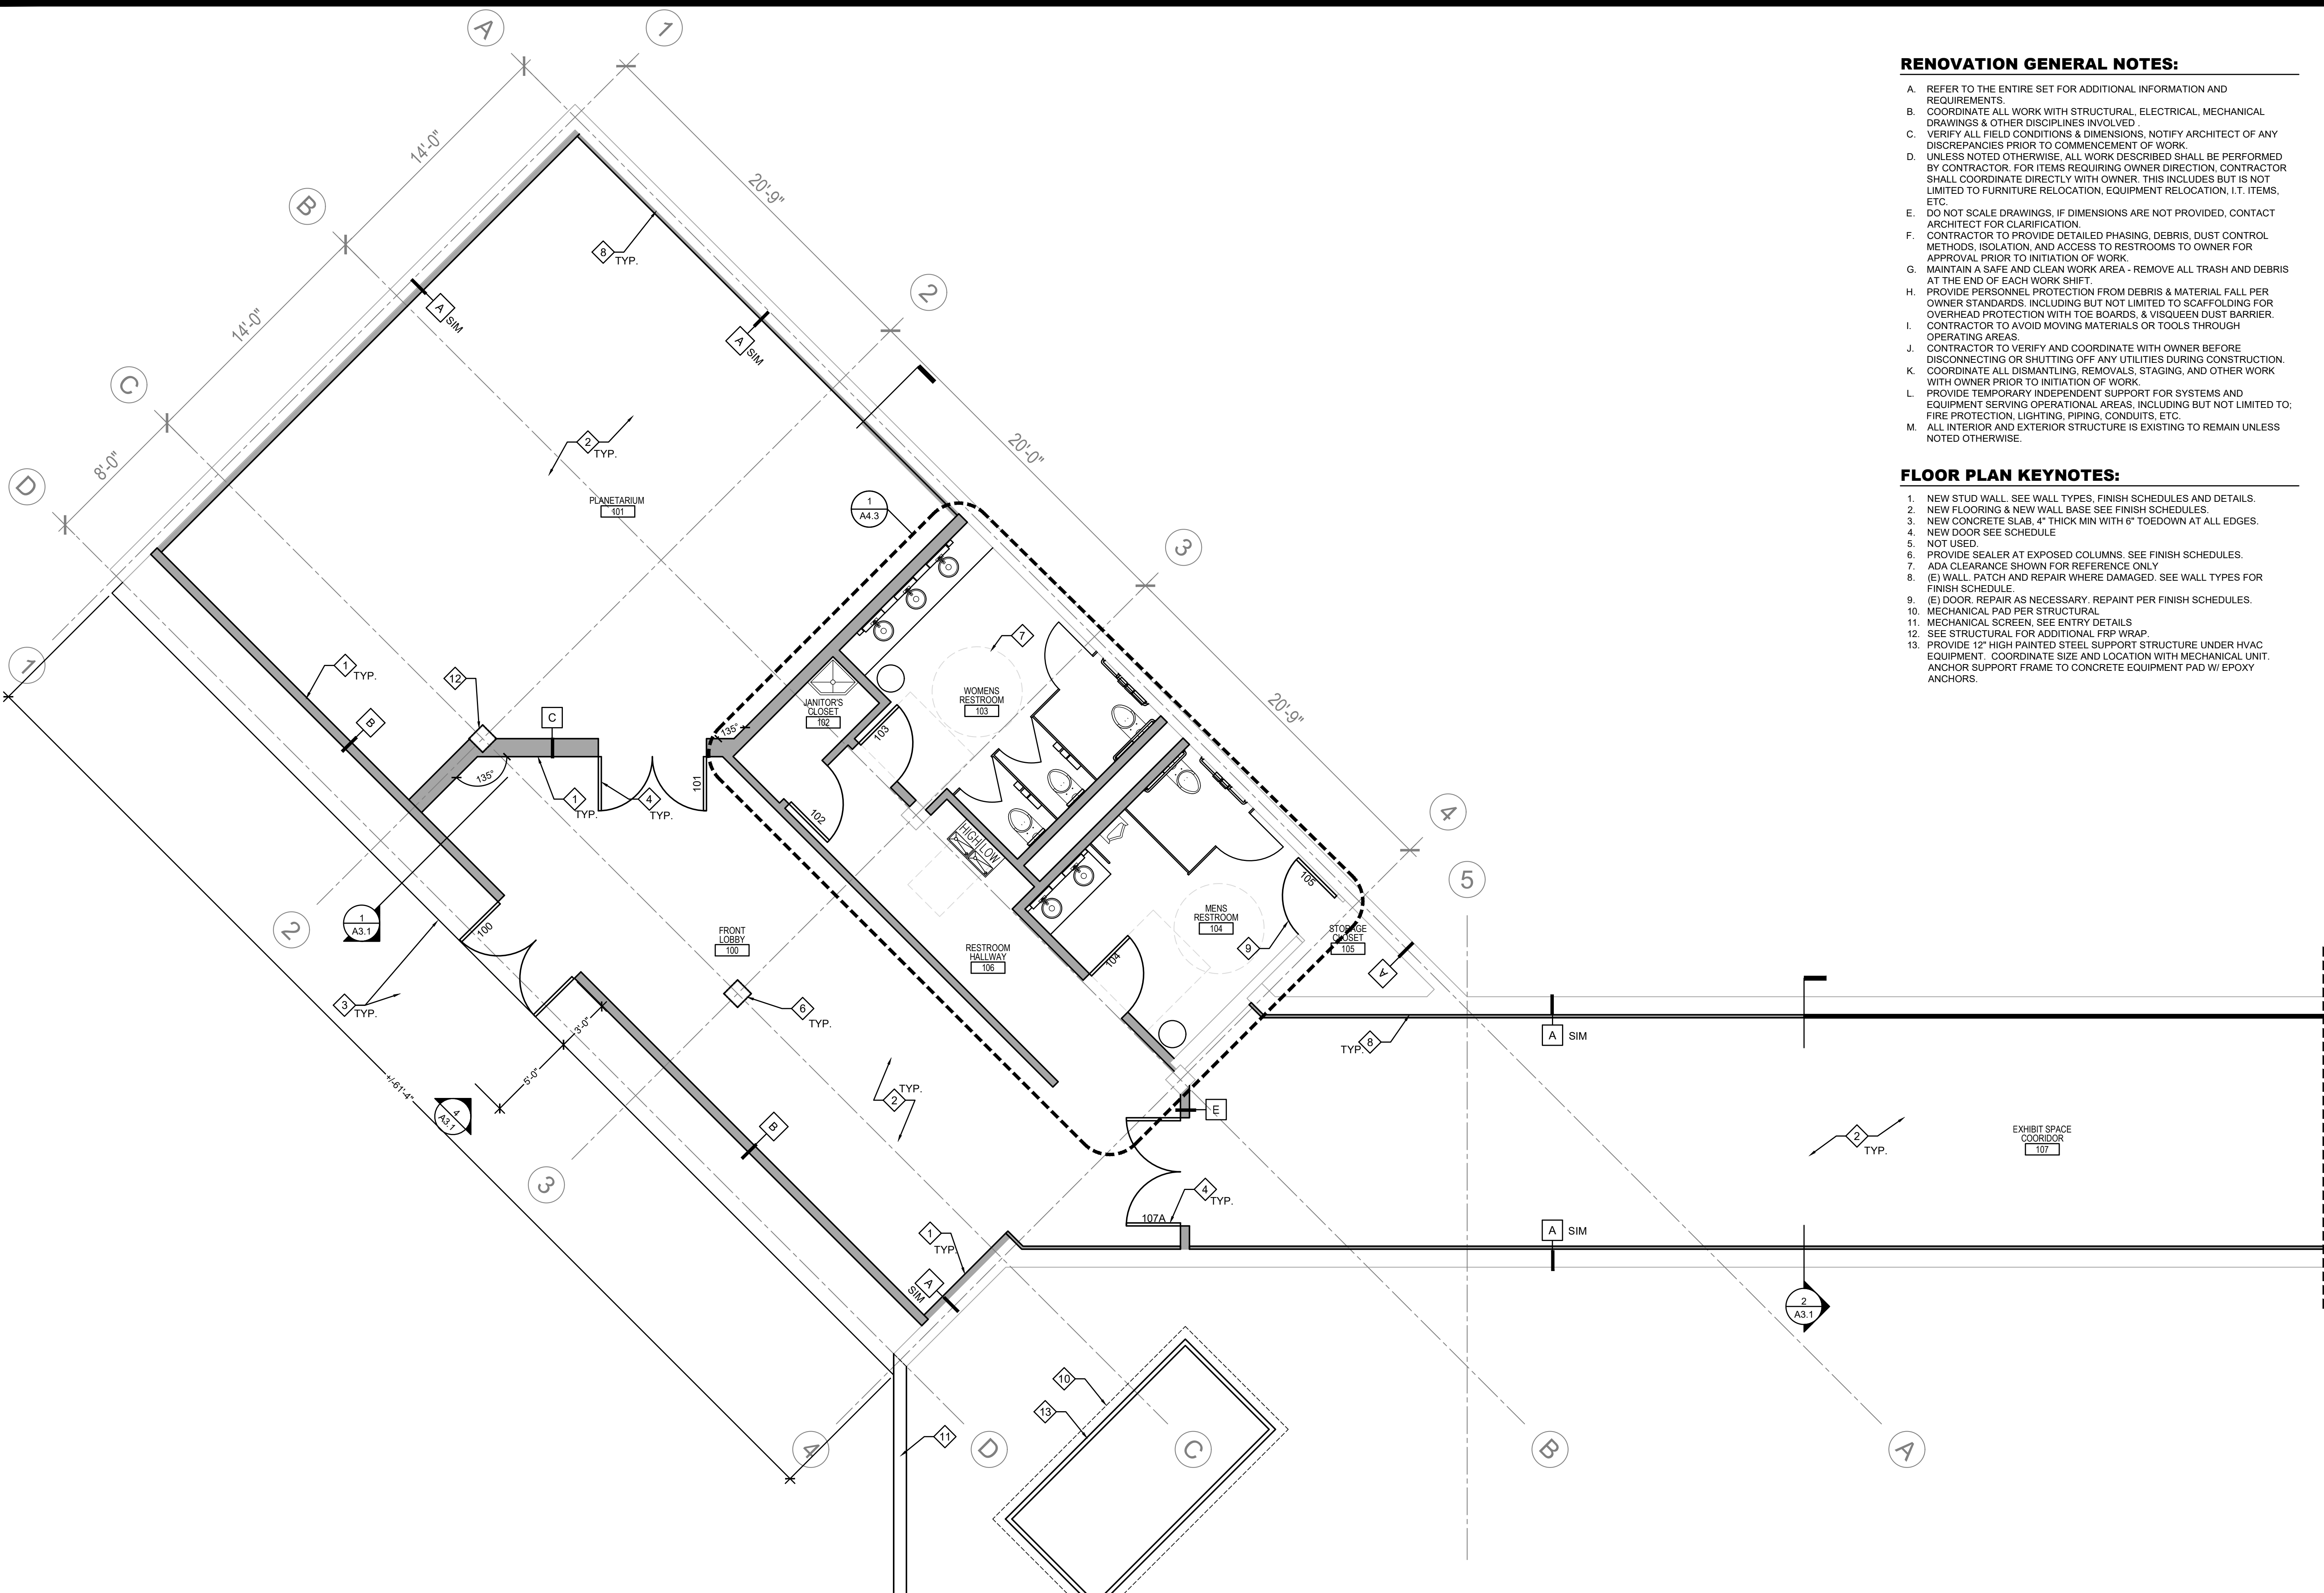AD2.3



RENOVATION GENERAL NOTES:


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- H. PROVIDE PERSONNEL PROTECTION FROM DEBRIS & MATERIAL FALL PER OWNER STANDARDS, INCLUDING BUT NOT LIMITED TO SCAFFOLDING FOR OVERHEAD PROTECTION WITH TOE BOARDS, & VISQUEEN DUST BARRIER.
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- L. PROVIDE TEMPORARY INDEPENDENT SUPPORT FOR SYSTEMS AND EQUIPMENT SERVING OPERATIONAL AREAS, INCLUDING BUT NOT LIMITED TO: FIRE PROTECTION, LIGHTING, PIPING, CONDUITS, ETC.
- M. ALL INTERIOR AND EXTERIOR STRUCTURE IS EXISTING TO REMAIN UNLESS NOTED OTHERWISE.

FLOOR PLAN KEYNOTES:

- 1. NEW STUD WALL. SEE WALL TYPES, FINISH SCHEDULES AND DETAILS.
- 2. NEW FLOORING & NEW WALL BASE SEE FINISH SCHEDULES.
- 3. NEW CONCRETE SLAB, 4" THICK MIN WITH 6" TOEDOWN AT ALL EDGES.
- 4. NEW DOOR SEE SCHEDULE.
- 5. NOT USED.
- 6. PROVIDE SEALER AT EXPOSED COLUMNS. SEE FINISH SCHEDULES.
- 7. ADA CLEARANCE SHOWN FOR REFERENCE ONLY.
- 8. (E) WALL. PATCH AND REPAIR WHERE DAMAGED. SEE WALL TYPES FOR FINISH SCHEDULE.
- 9. (E) DOOR. REPAIR AS NECESSARY. REPAINT PER FINISH SCHEDULES.
- 10. MECHANICAL PAD PER STRUCTURAL.
- 11. MECHANICAL SCREEN, SEE ENTRY DETAILS.
- 12. SEE STRUCTURAL FOR ADDITIONAL FRP WRAP.
- 13. PROVIDE 12" HIGH PAINTED STEEL SUPPORT STRUCTURE UNDER HVAC EQUIPMENT. COORDINATE SIZE AND LOCATION WITH MECHANICAL UNIT. ANCHOR SUPPORT FRAME TO CONCRETE EQUIPMENT PAD W/ EPOXY ANCHORS.



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MATCHLINE - SEE SHEET A1.2 FOR CONTINUATION

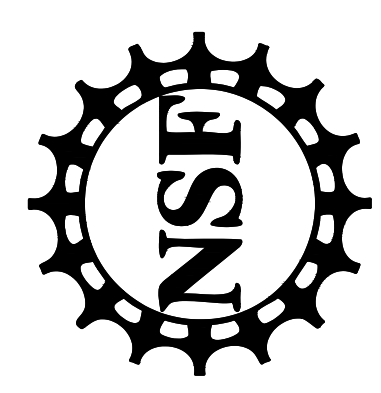DATE	DESCRIPTION
01/08/21	I.F.C.


PROJECT NUMBER: 11904.00
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 CHECKED BY: IR
 CAD FILE: 11904.00-A1.1
 SCALE: AS NOTED

ENLARGED RENO
FLOOR PLAN
AREA A

A1.1



1 ARCHITECTURAL ENLARGED RENO FLOOR PLAN - AREA A
1ST. LEVEL

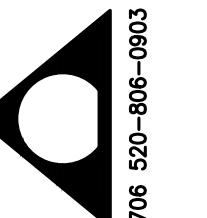SCALE: 1/4" = 1'-0"



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SCALE: AS NOTED

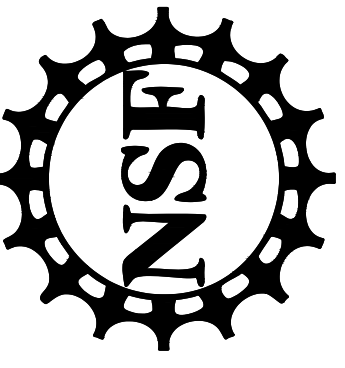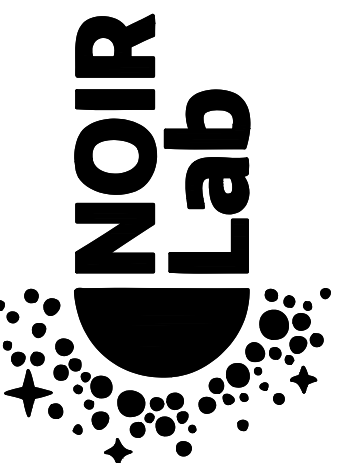ENLARGED RENO
FLOOR PLAN
AREA B


A1.2

RENOVATION GENERAL NOTES:

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FLOOR PLAN KEYNOTES:

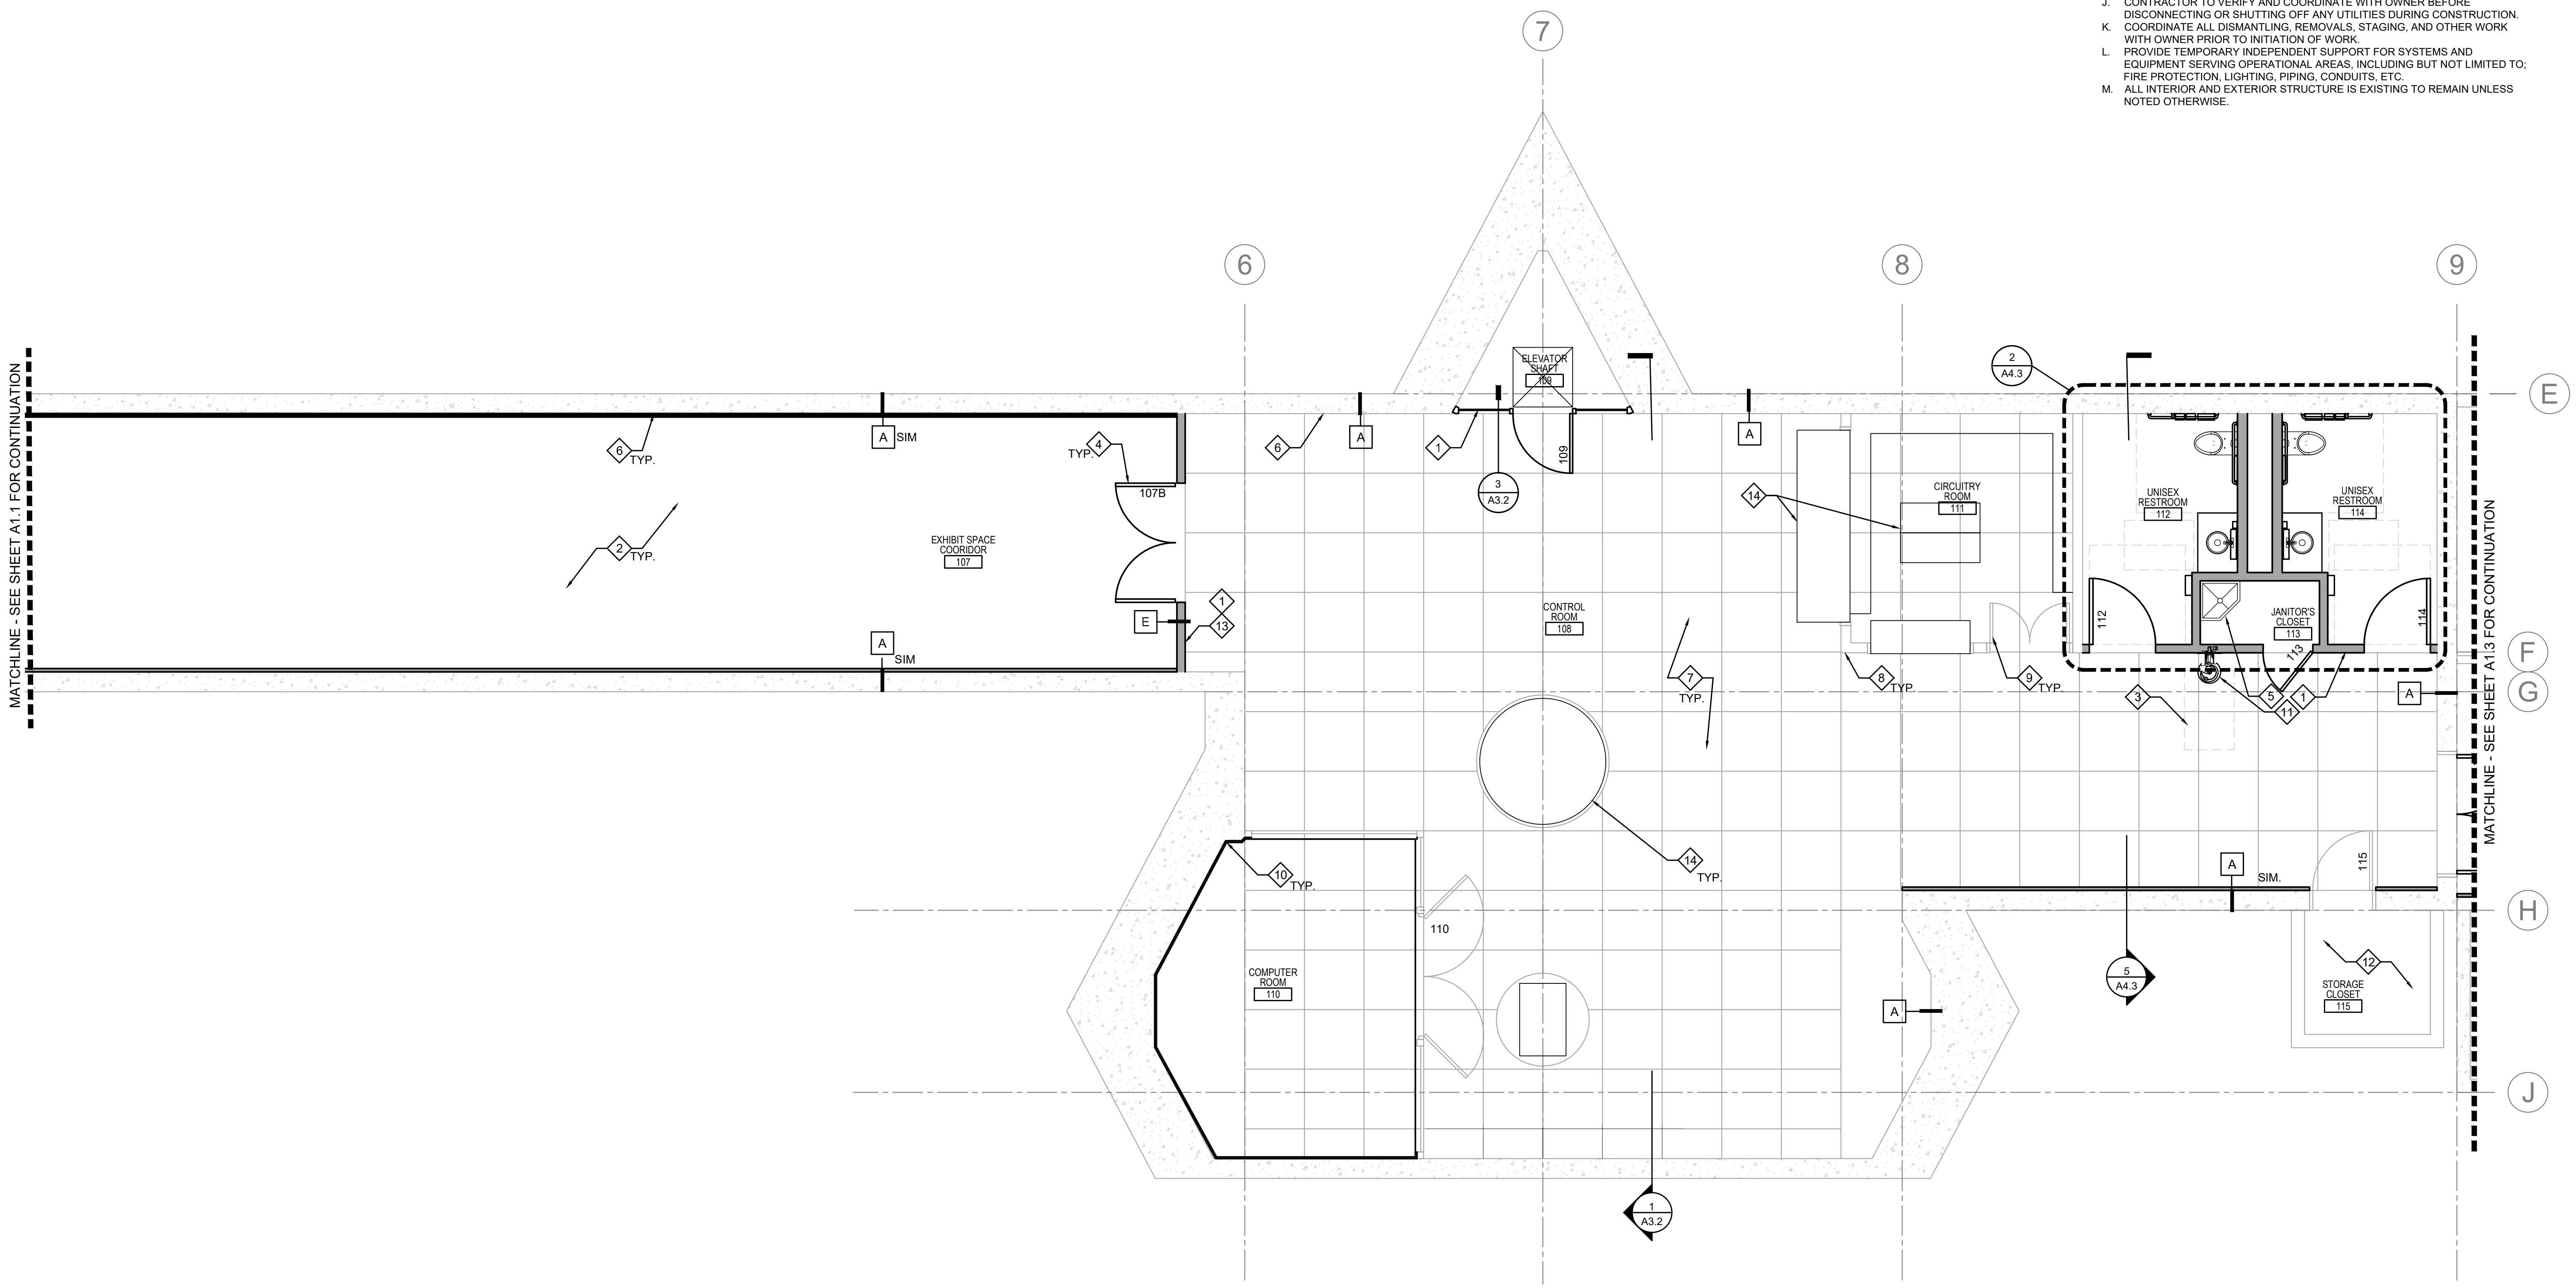- 1. NEW STUD WALL. SEE WALL TYPES, FINISH SCHEDULES AND DETAILS.
- 2. NEW FLOORING & WALL BASE SEE FINISH SCHEDULES.
- 3. ADA CLEARANCE, SHOWN FOR REFERENCE ONLY.
- 4. NEW DOOR AS SHOWN SEE SCHEDULE.
- 5. NEW PLUMBING FIXTURES. SEE MECHANICAL SHEETS.
- 6. EXISTING WALLS TO BE PAINTED. SEE FINISH SCHEDULE.
- 7. PROVIDE NEW CARPET OVER EXISTING RAISED FLOORING SYSTEM. COORDINATE WITH OWNER FOR PROTECTION OF EXISTING EQUIPMENT.
- 8. (E) WALL TO REMAIN. PATCH AND REPAIR WHERE DAMAGED TO MATCH EXISTING.
- 9. (E) DOOR. REPAIR IF NECESSARY. REPAIR PER FINISH SCHEDULES.
- 10. REFINISH EXISTING WALL. PATCH AND REPAIR 1X1 TILES AS NEEDED.
- 11. NEW DRINKING FOUNTAIN, SEE MECHANICAL.
- 12. NO WORK THIS AREA.
- 13. ALIGN WALL WITH RAISED FLOOR EDGE.
- 14. EXISTING MILLWORK / EQUIPMENT TO REMAIN AND BE PROTECTED DURING RENOVATION.



1 ARCHITECTURAL ENLARGED RENO PLAN - AREA B
1ST. LEVEL

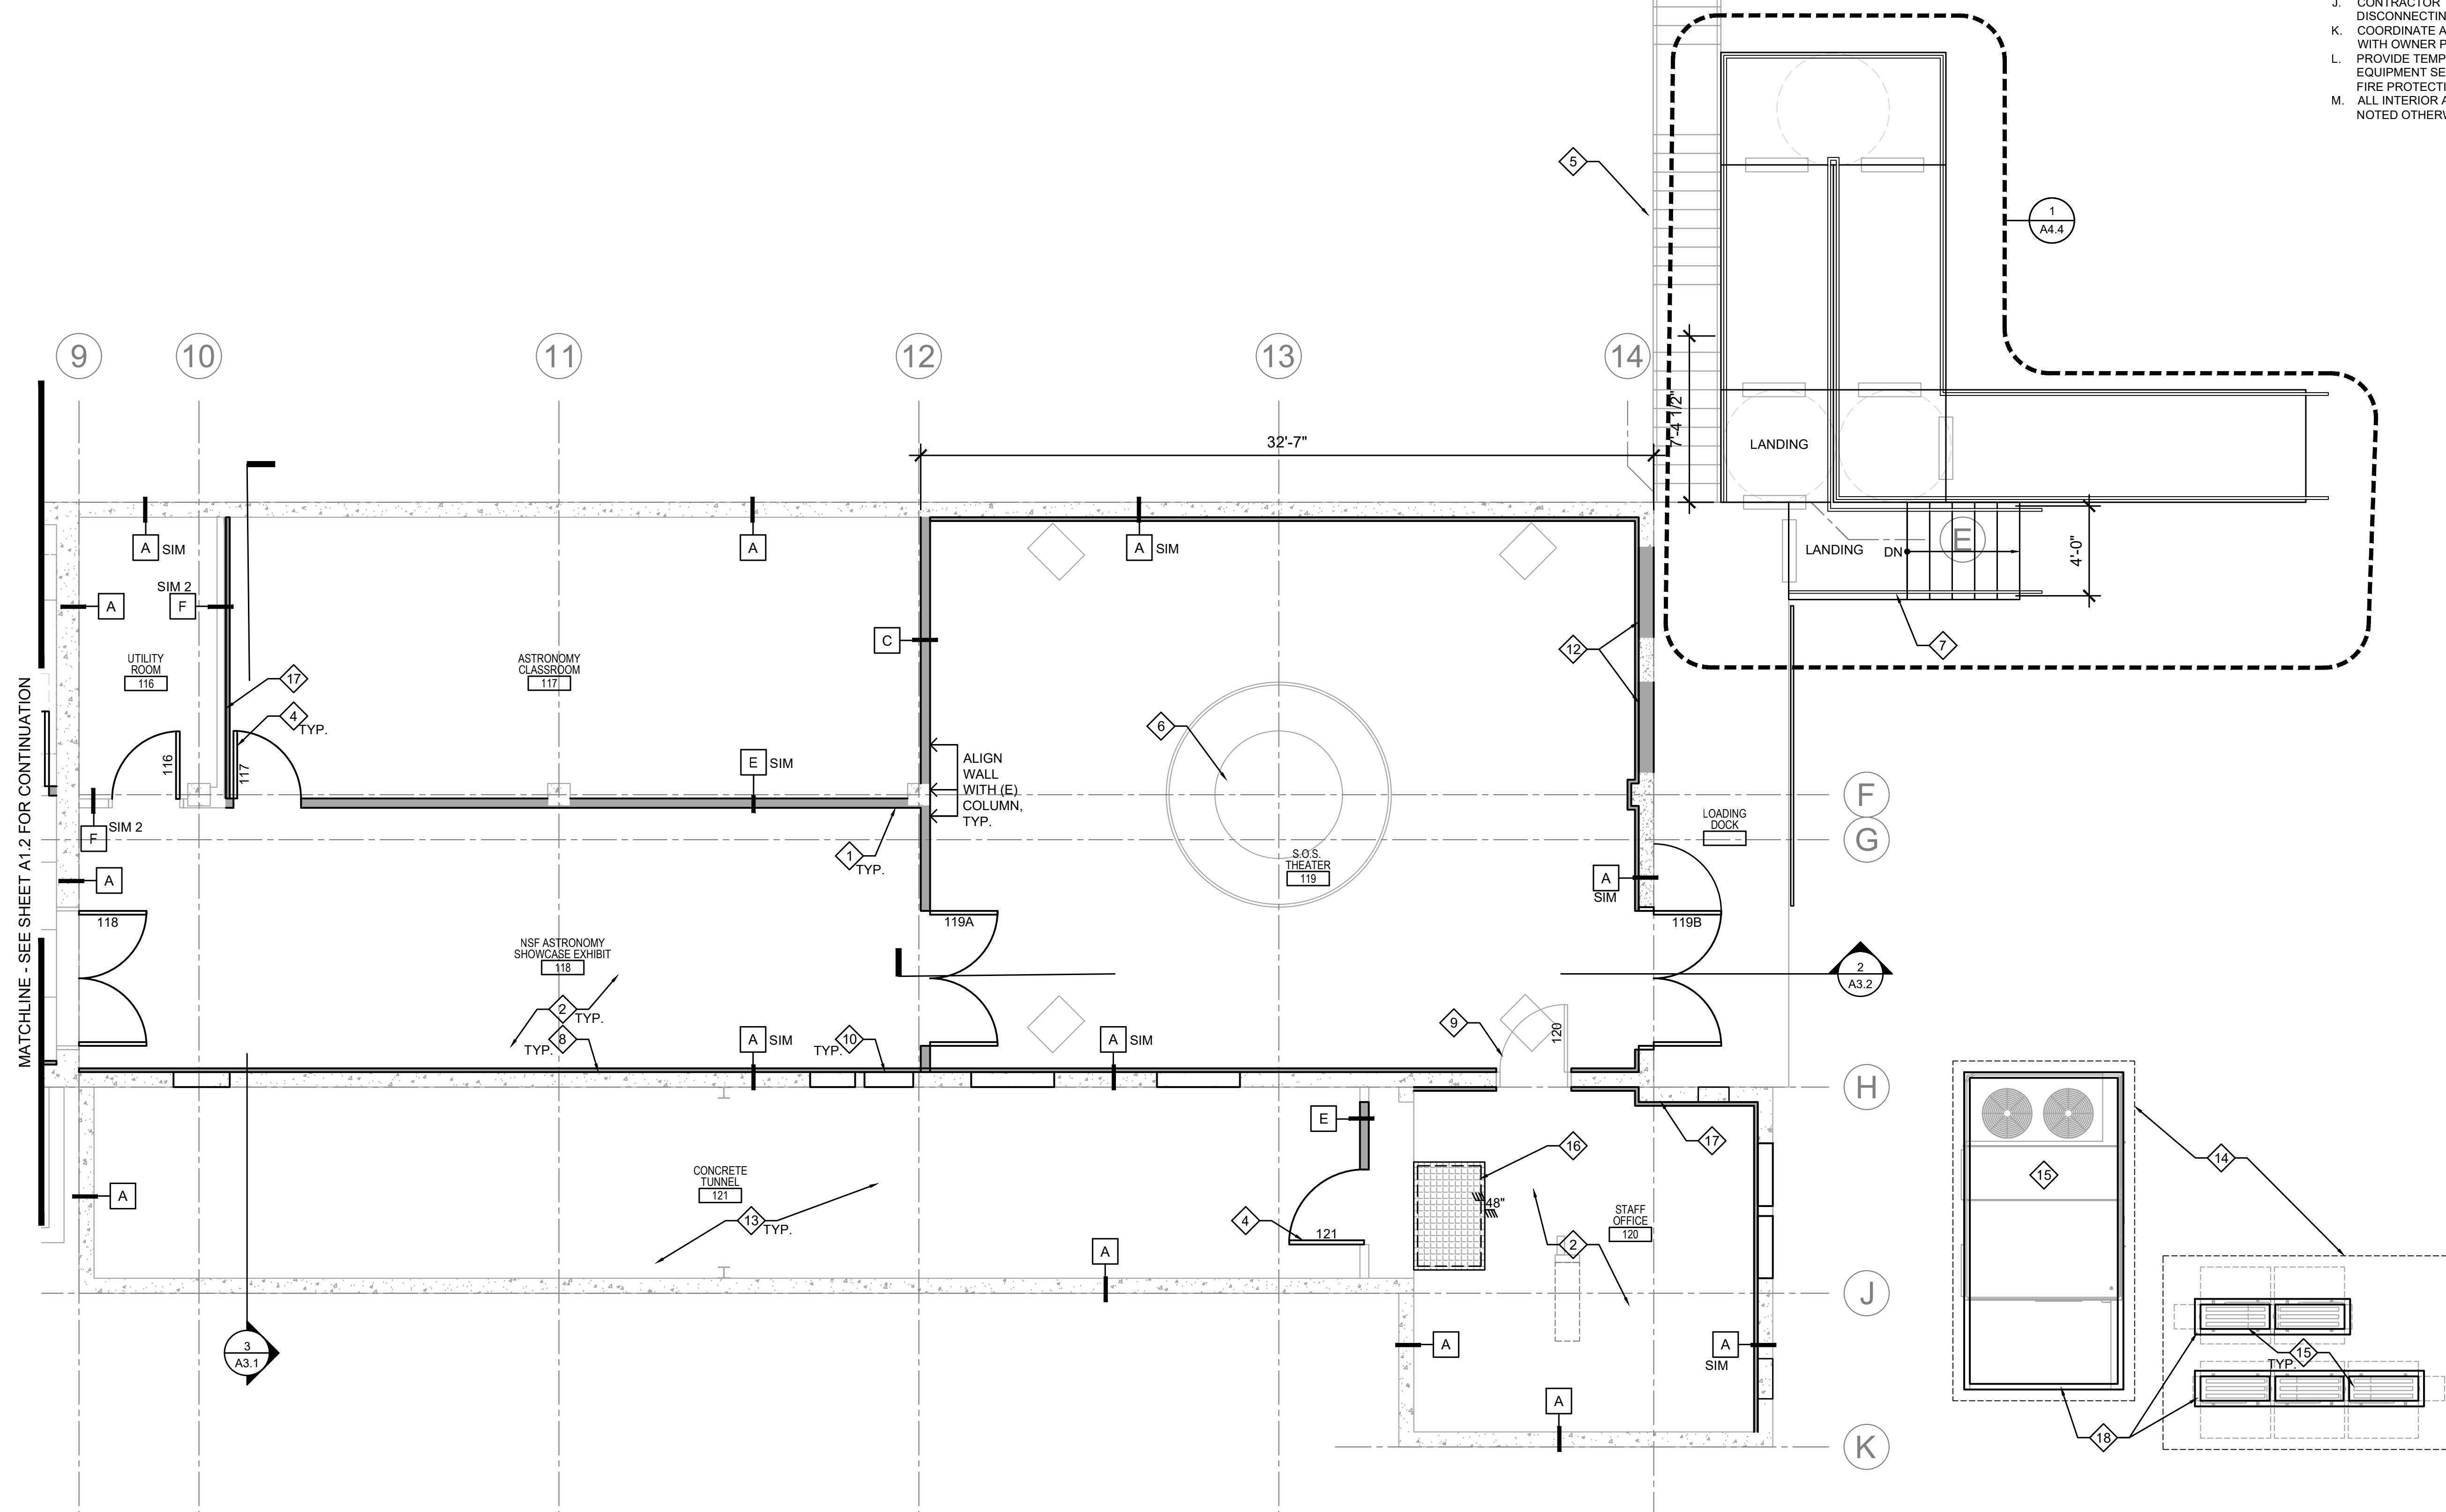
SCALE: 1/4" = 1'-0"

FLOOR PLAN KEYNOTES:

1. NEW STUD WALL. SEE WALL TYPES, FINISH SCHEDULES AND DETAILS.
2. NEW FLOORING & WALL BASE SEE FINISH SCHEDULES.
3. NEW HEAVY DUTY ALUMINUM ACCESS RAMP, RAILING, AND LANDING BY AMERICAN ACCESS INC OR SIMILAR. SEE DETAILS SHEET A4.4 AND STRUCTURAL DRAWINGS FOR MORE INFO. PAINT TO MATCH EXISTING
4. NEW DOOR. SEE FINISH SCHEDULES.
5. EXISTING STAIRS TO REMAIN.
6. SOS THEATER EQUIPMENT, BY OTHERS.
7. NEW HEAVY DUTY ALUMINUM STEPS, RAILING, AND LANDING BY AMERICAN ACCESS INC. OR SIMILAR. SEE DETAILS SHEET A4.4 AND STRUCTURAL DRAWINGS FOR MORE INFO. PAINT TO MATCH EXISTING.
8. (E) WALL. PATCH AND REPAIR WHERE DAMAGED TO MATCH EXISTING.
9. (E) DOOR. REPAIR IF NECESSARY. REPAINT PER FINISH SCHEDULES.
10. NEW CUT OUTS @ EXISTING CONCRETE FOR MECHANICAL DUCTWORK. COORDINATE WITH MECHANICAL FOR EXACT PLACEMENT.
11. EXISTING RAILING TO BE PAINTED, COLOR TBD.
12. NEW INFILL OPENING. SEE WALL TYPES AND FINISH SCHEDULES. EXTERIOR PAINT TO MATCH EXISTING.
13. NO WORK THIS AREA.
14. MECHANICAL PAD PER STRUCTURAL.
15. MECHANICAL UNITS SHOWN FOR REFERENCE. SEE MECHANICAL.
16. 2X2 HSS PLATFORM 48" HIGH TO MATCH HEIGHT OF TUNNEL. PROVIDE 1/4 GRATING.
17. ACOUSTICAL PANELING, REFER TO WALL TYPES.
18. PROVIDE 12" HIGH PAINTED STEEL SUPPORT STRUCTURE UNDER HVAC EQUIPMENT. COORDINATE SIZE AND LOCATION WITH MECHANICAL UNIT. ANCHOR SUPPORT FRAME TO CONCRETE EQUIPMENT PAD W/ EPOXY ANCHORS.

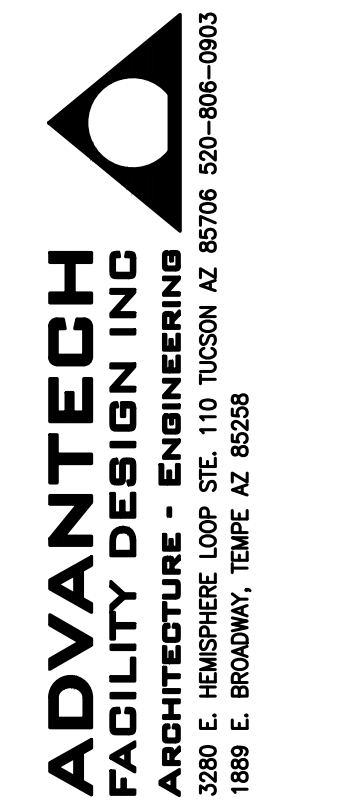
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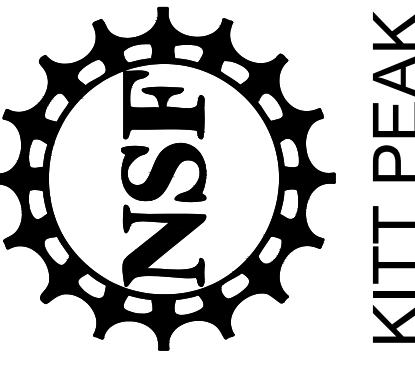


1 ARCHITECTURAL ENLARGED RENO FLOOR PLAN - AREA C
1ST. LEVEL

SCALE: 1/4" = 1'-0"



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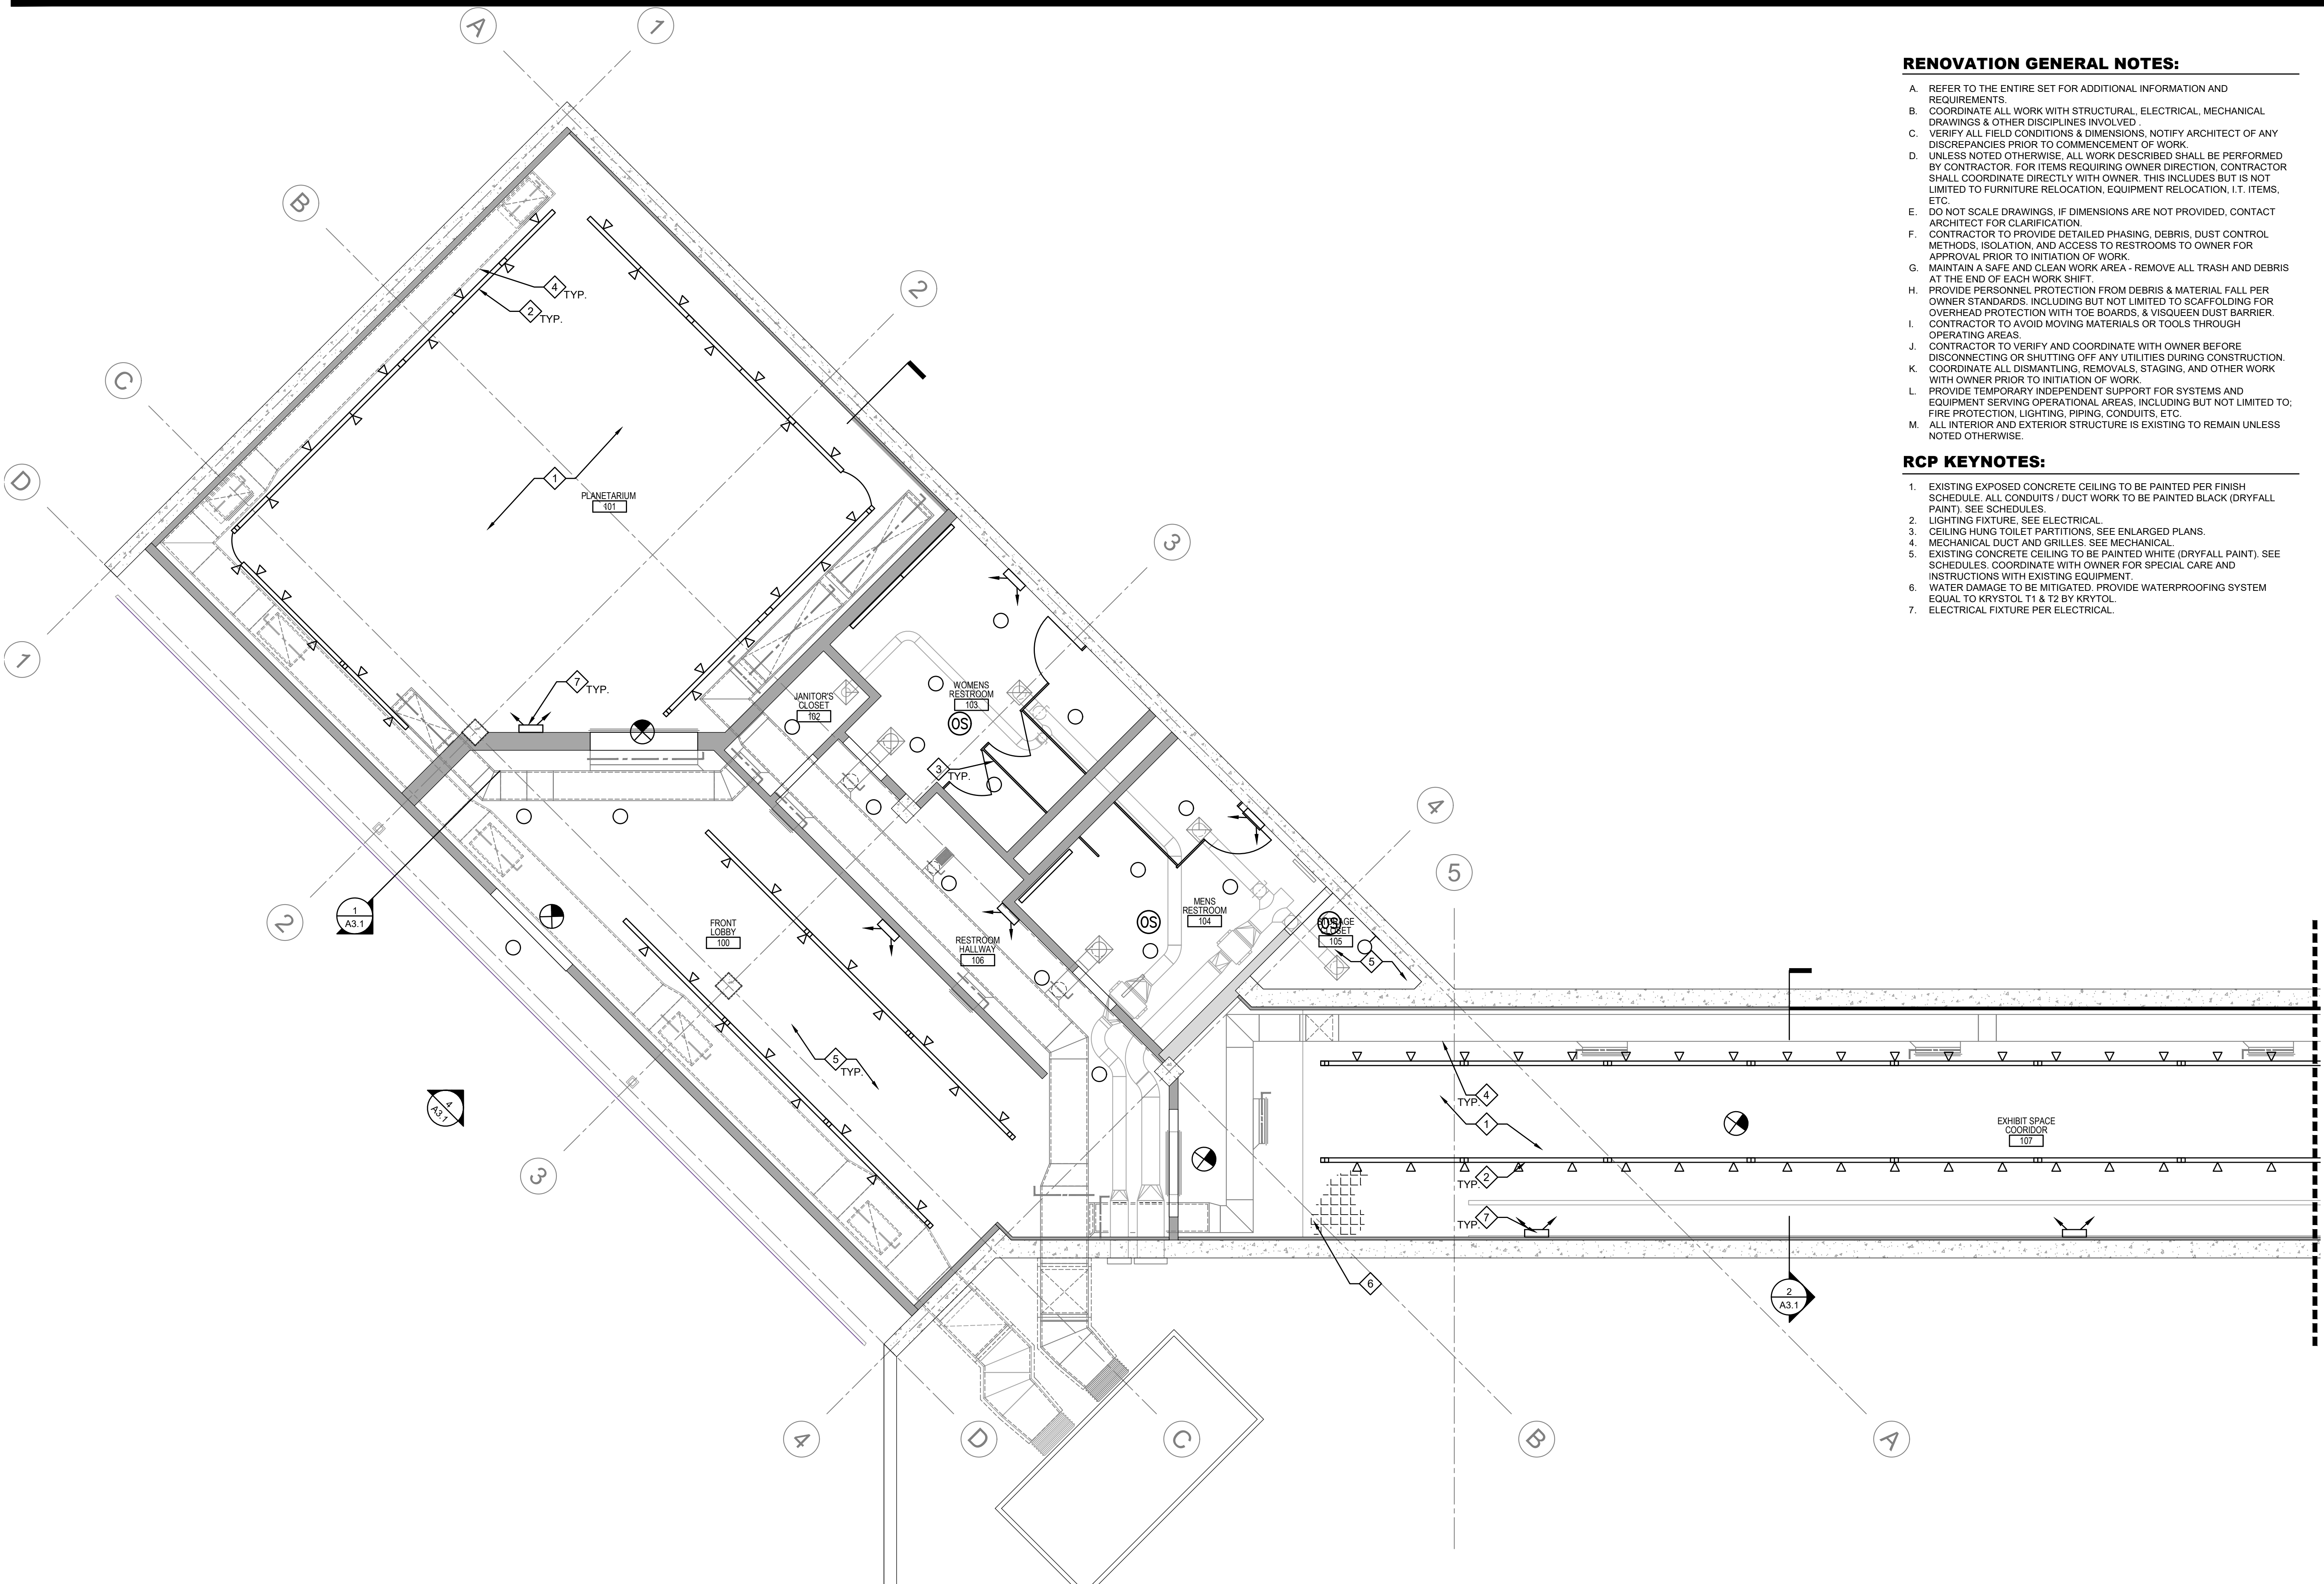
KITT PEAK - Sells, AZ 85634

△	DATE	DESCRIPTION
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PROJECT NUMBER: 11904.00
DRAWN BY:
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CAD FILE: 11904.00-A1.3
SCALE: AS NOTED

ENLARGED RENO
FLOOR PLAN
AREA C

A1.3



RENOVATION GENERAL NOTES:


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RCP KEYNOTES:

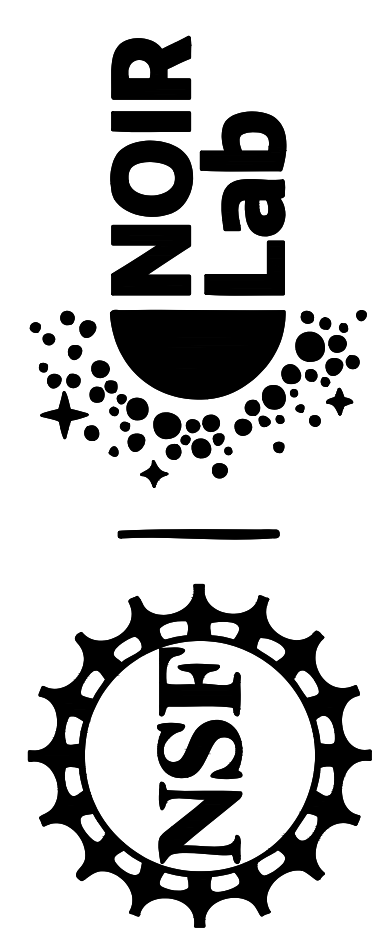- 1. EXISTING EXPOSED CONCRETE CEILING TO BE PAINTED PER FINISH SCHEDULE. ALL CONDUITS / DUCT WORK TO BE PAINTED BLACK (DRYFALL PAINT). SEE SCHEDULES.
- 2. LIGHTING FIXTURE, SEE ELECTRICAL.
- 3. CEILING HUNG TOILET PARTITIONS. SEE ENLARGED PLANS.
- 4. MECHANICAL DUCT AND GRILLES. SEE MECHANICAL.
- 5. EXISTING CONCRETE CEILING TO BE PAINTED WHITE (DRYFALL PAINT). SEE SCHEDULES. COORDINATE WITH OWNER FOR SPECIAL CARE AND INSTRUCTIONS WITH EXISTING EQUIPMENT.
- 6. WATER DAMAGE TO BE MITIGATED. PROVIDE WATERPROOFING SYSTEM EQUAL TO KRYSTOL T1 & T2 BY KRYTOL.
- 7. ELECTRICAL FIXTURE PER ELECTRICAL.



WINDOWS ON
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DATE	DESCRIPTION
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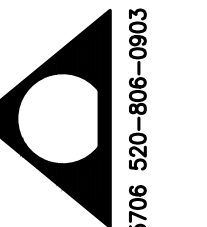
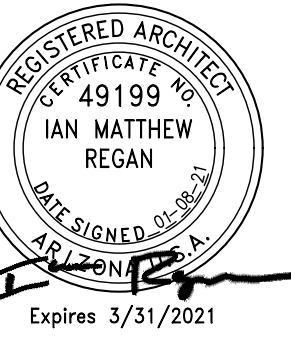
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ENLARGED RENO
REFLECTED CEILING
AREA A

A2.1

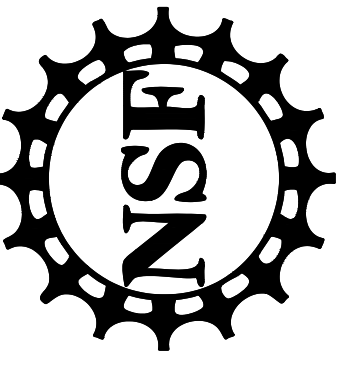
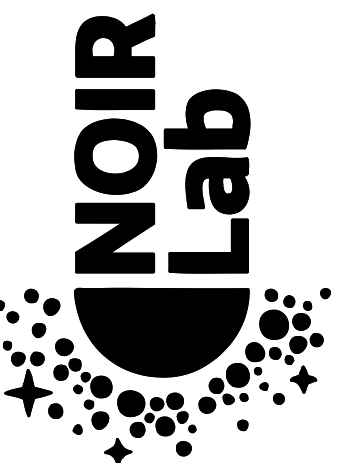
1 ARCHITECTURAL ENLARGED RENO REFLECTED CEILING PLAN - AREA A
1ST. LEVEL

SCALE: 1/4" = 1'-0"



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ARCHITECTURE - ENGINEERING
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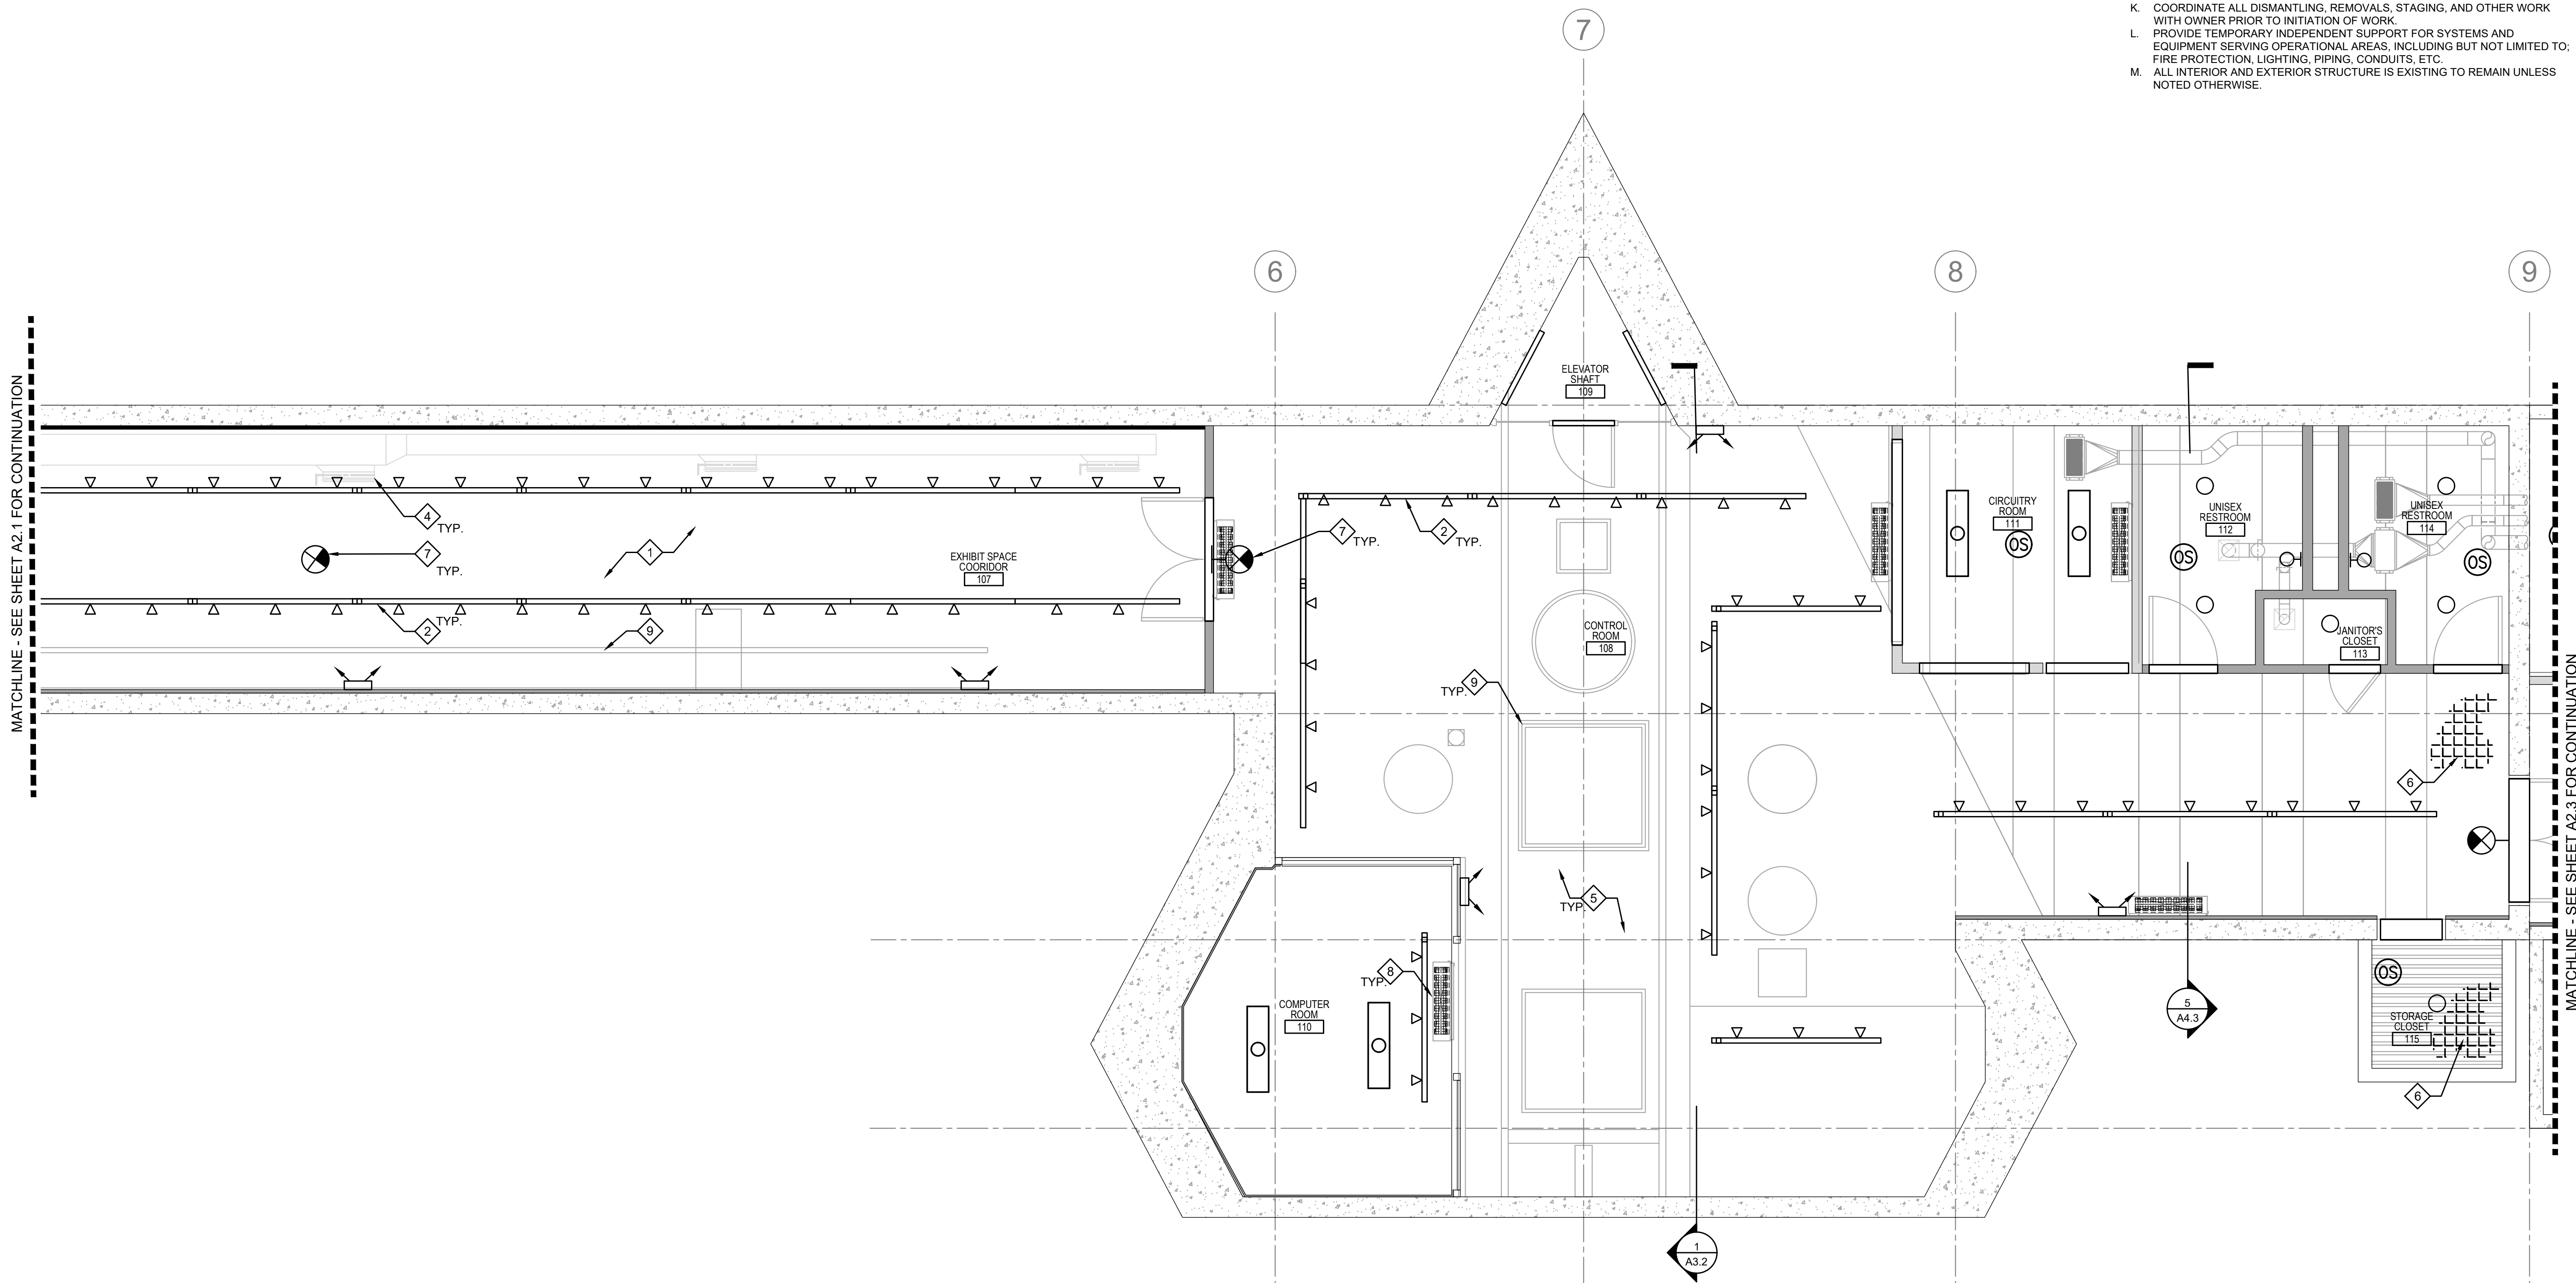
KITT PEAK - Sells, AZ 85634

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2. LIGHTING FIXTURE, SEE ELECTRICAL.
3. NOT USED.
4. MECHANICAL DUCT AND GRILLES, SEE MECHANICAL.
5. EXISTING CONCRETE CEILING TO BE PAINTED WHITE (DRYFALL PAINT). SEE SCHEDULES. COORDINATE WITH OWNER FOR SPECIAL CARE AND INSTRUCTIONS WITH EXISTING EQUIPMENT.
6. WATER DAMAGE TO BE MITIGATED. PROVIDE WATERPROOFING SYSTEM EQUAL TO KRYSTOL T1 & T2 BY KRYTOL.
7. ELECTRICAL FIXTURE PER ELECTRICAL.
8. HEAT PUMP COIL FAN, TYP. SEE MECHANICAL. SEE ELECTRICAL.
9. ALL EQUIPMENT AND PORTALS TO BE PROTECTED IN PLACE

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1 ARCHITECTURAL ENLARGED RENO REFLECTED CEILING PLAN - AREA B
1ST. LEVEL



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DATE	DESCRIPTION
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PROJECT NUMBER: 11904.00
DRAWN BY:
CHECKED BY: IR
CAD FILE: 11904.00-A2.2
SCALE: AS NOTED



ENLARGED RENO
REFLECTED CEILING
AREA B

A2.2



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1889 E. BROADWAY, TEMPE, AZ 85288

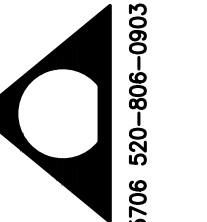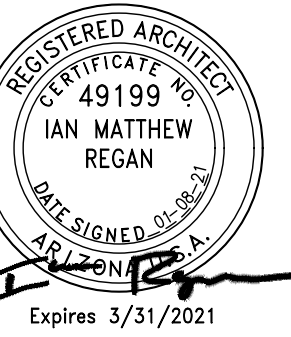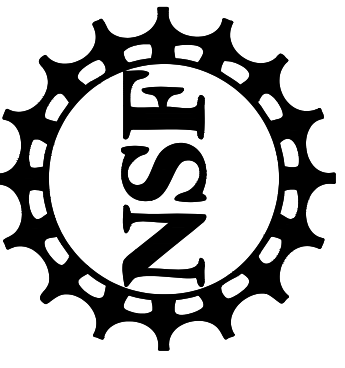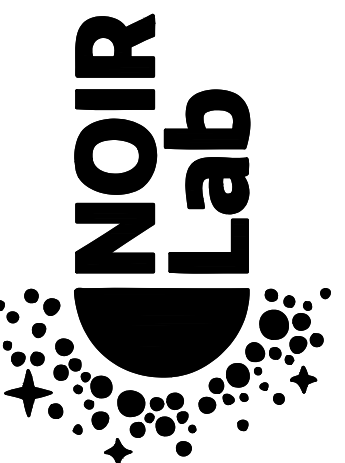WINDOWS ON
THE UNIVERSE
CENTER FOR
ASTRONOMY
OUTREACH




KITT PEAK - Sells, AZ 85634

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RCP KEYNOTES:

- 1. EXISTING EXPOSED CONCRETE CEILING TO BE PAINTED PER FINISH SCHEDULE. ALL CONDUITS / DUCT WORK TO BE PAINTED BLACK (DRYFALL PAINT). SEE SCHEDULES.
- 2. LIGHTING FIXTURE, SEE ELECTRICAL.
- 3. ELECTRICAL FIXTURE PER ELECTRICAL.
- 4. MECHANICAL DUCT AND GRILLES, SEE MECHANICAL.
- 5. EXISTING CONCRETE CEILING TO BE PAINTED WHITE (DRYFALL PAINT). SEE SCHEDULES. COORDINATE WITH OWNER FOR SPECIAL CARE AND INSTRUCTIONS WITH EXISTING EQUIPMENT.
- 6. WATER DAMAGE TO BE MITIGATED. PROVIDE WATERPROOFING SYSTEM EQUAL TO KRYSTOL T1 & T2 BY KRYTOL.
- 7. NEW EQUIPMENT BELOW, SHOWN FOR REFERENCE ONLY.
- 8. SOS SHERE HANGING SYSTEM, BY OWNERS. CONTRACTOR INSTALLED. USE SIMPSON TITAN HD 1/4" X 2" GALVANIZED SCREWS INTO CONCRETE BEAM.
- 9. REFER TO STRUCTURAL FOR NEW CONCRETE BEAMS.



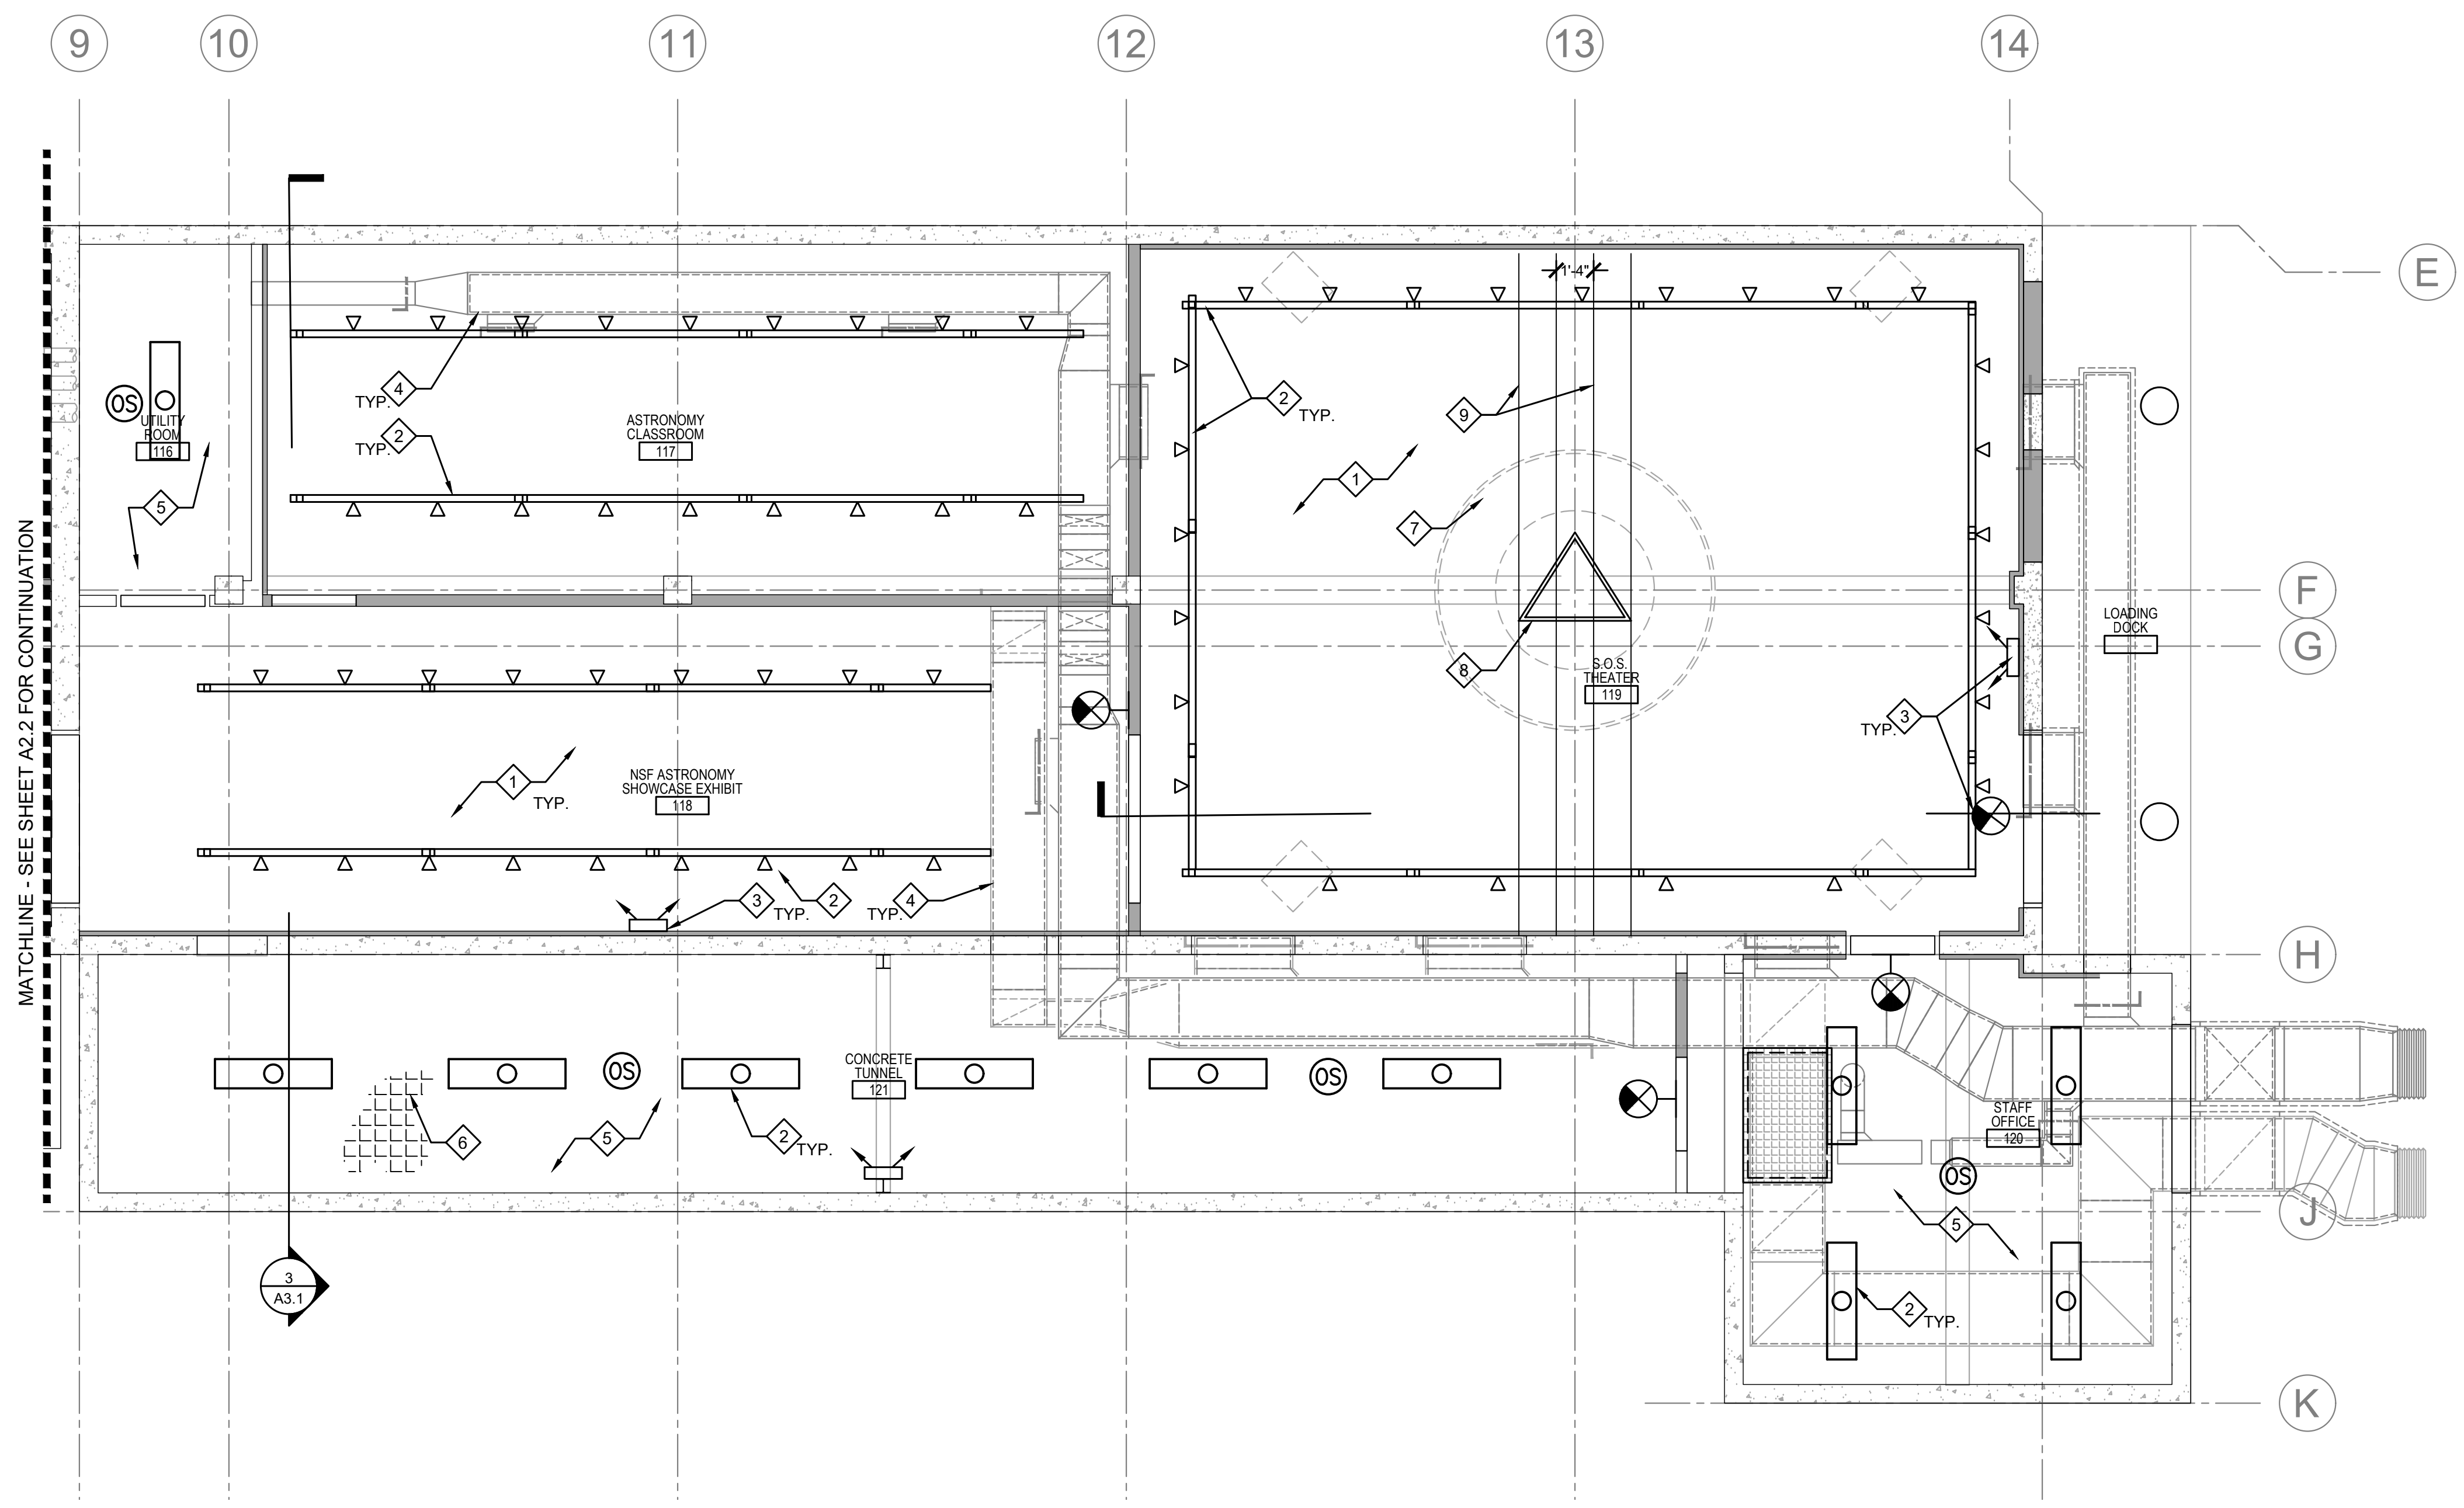1 ARCHITECTURAL ENLARGED RENO REFLECTED CEILING PLAN - AREA C
1ST. LEVEL


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△	DATE	DESCRIPTION
0	01/08/21	I.F.C.

PROJECT NUMBER: 11904.00
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CAD FILE: 11904.00-A2.3
SCALE: AS NOTED

ENLARGED RENO
REFLECTED CEILING
AREA C

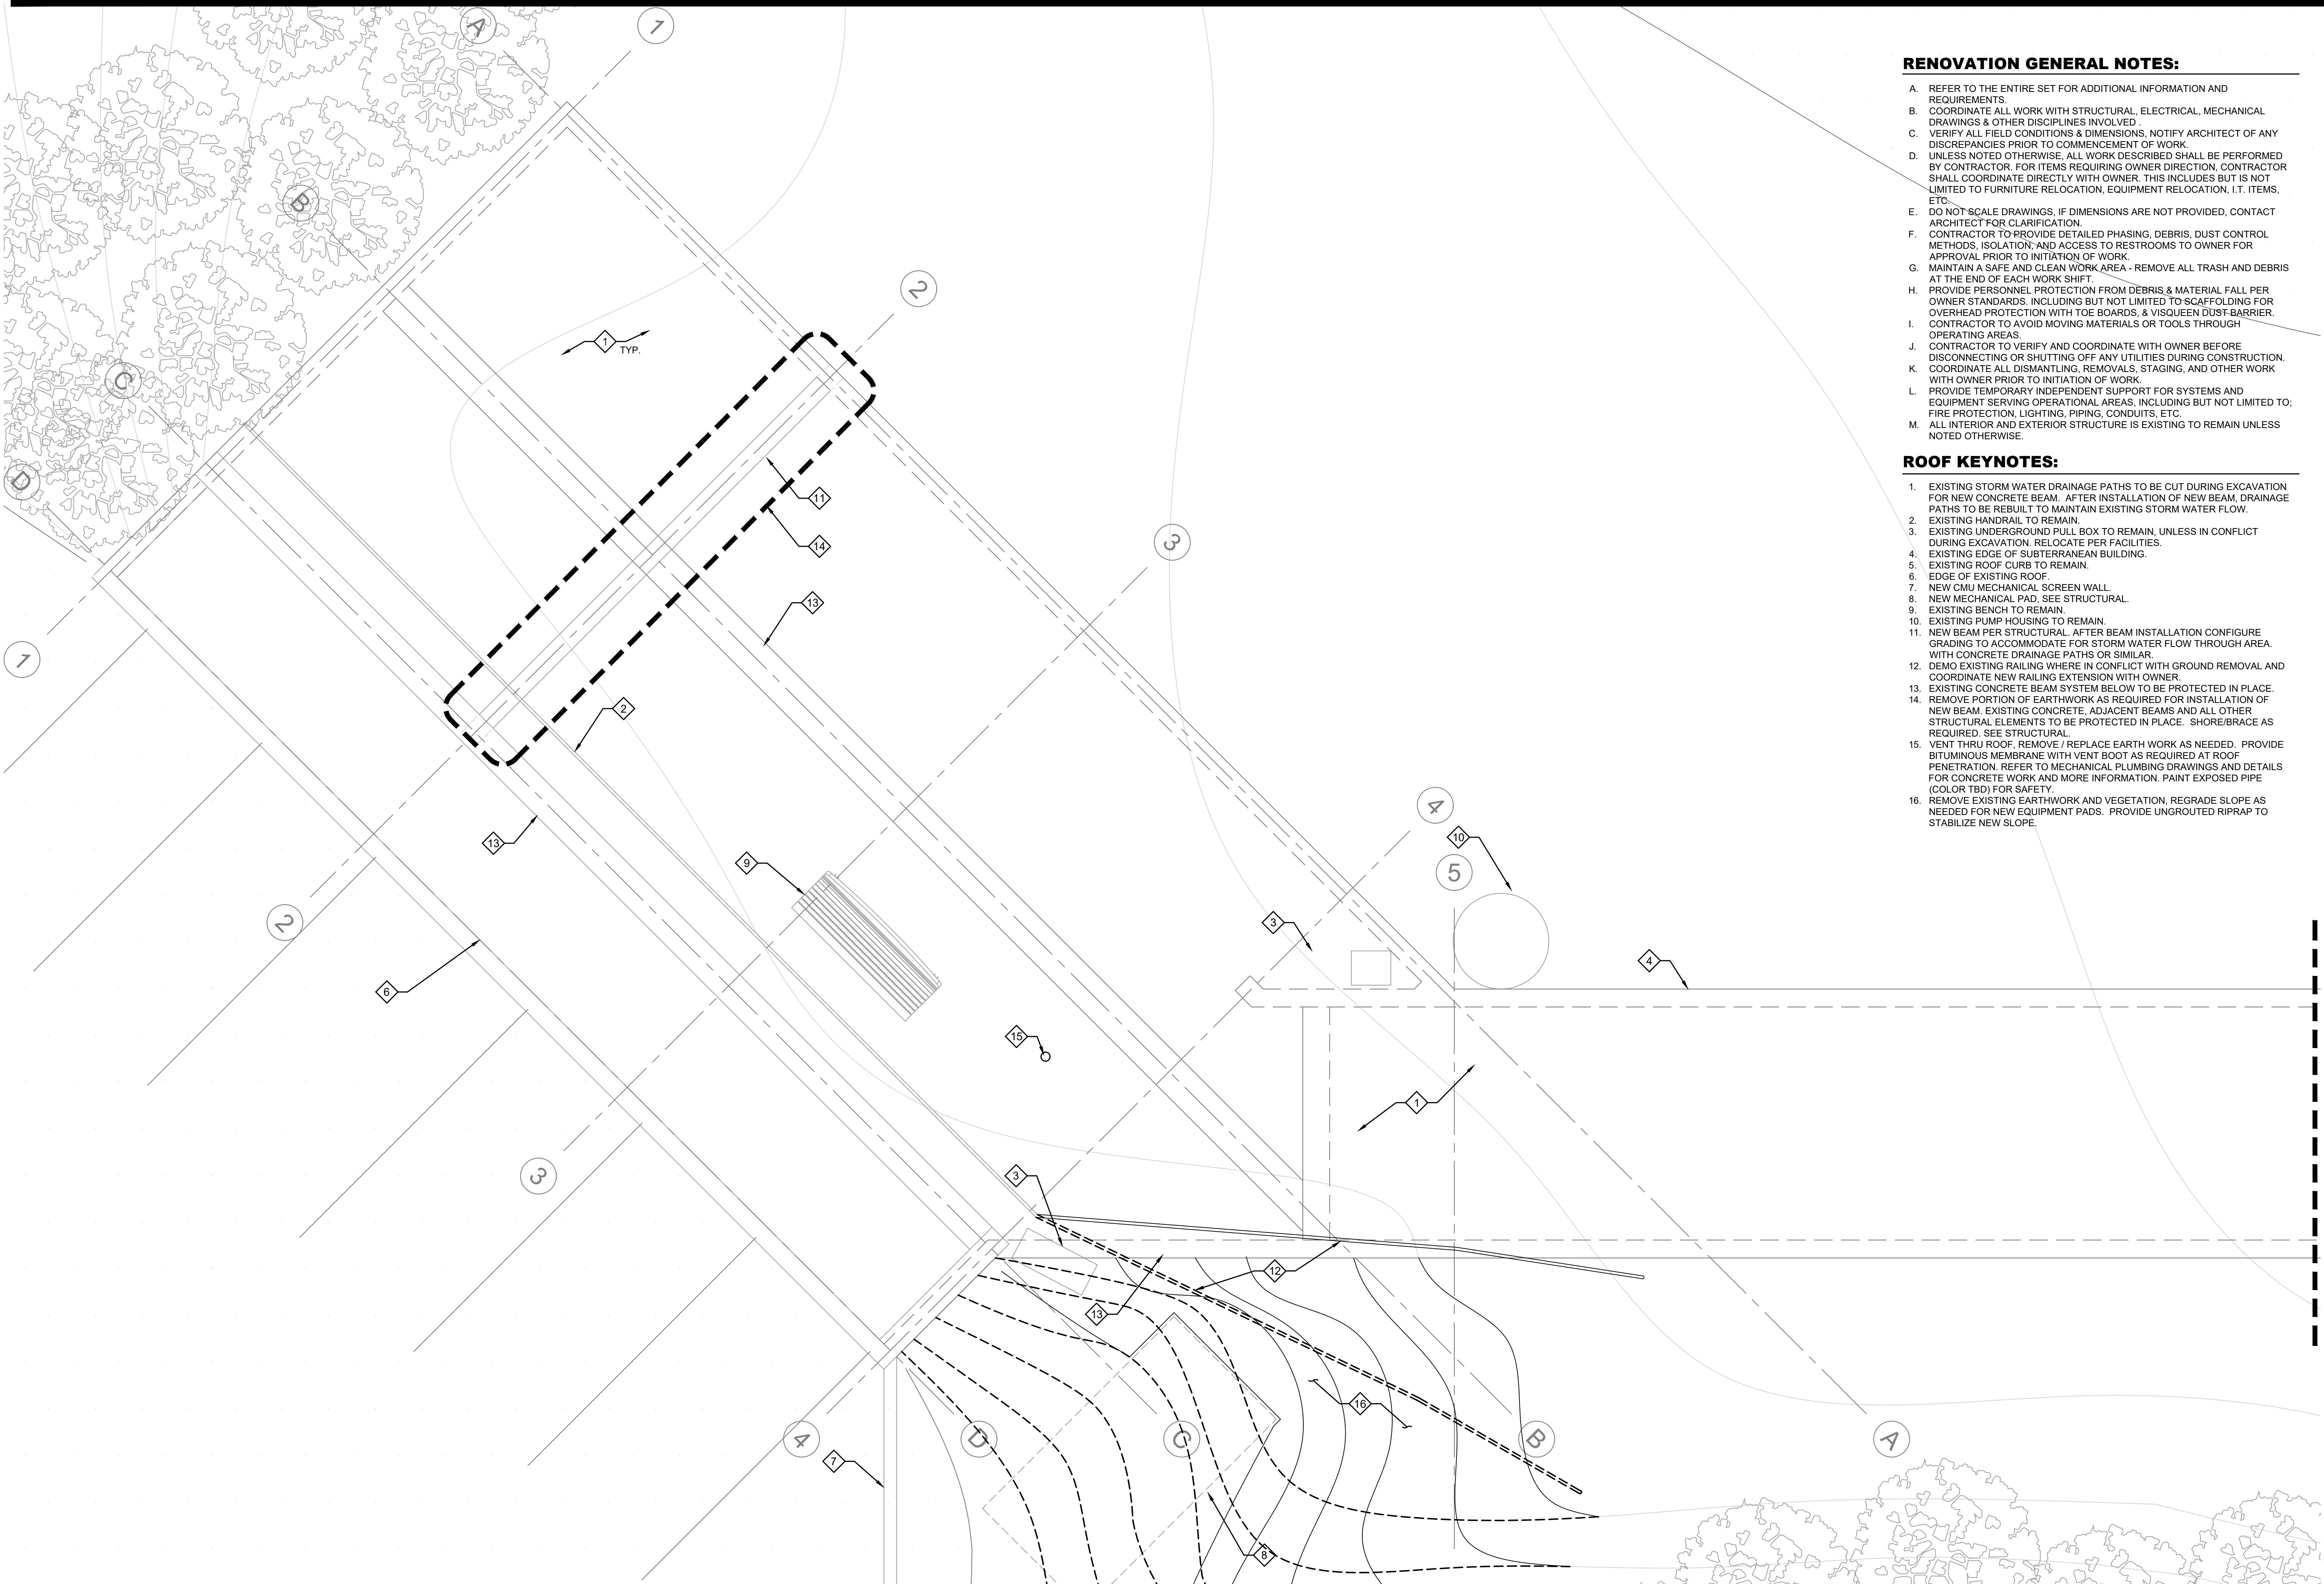A2.3



RENOVATION GENERAL NOTES:


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ROOF KEYNOTES:

- 1. EXISTING STORM WATER DRAINAGE PATHS TO BE CUT DURING EXCAVATION FOR NEW CONCRETE BEAM. AFTER INSTALLATION OF NEW BEAM, DRAINAGE PATHS TO BE REBUILT TO MAINTAIN EXISTING STORM WATER FLOW.
- 2. EXISTING HANDRAIL TO REMAIN.
- 3. EXISTING UNDERGROUND PULL BOX TO REMAIN, UNLESS IN CONFLICT DURING EXCAVATION. RELOCATE PER FACILITIES.
- 4. EXISTING EDGE OF SUBTERRANEAN BUILDING.
- 5. EXISTING ROOF CURB TO REMAIN.
- 6. EDGE OF EXISTING ROOF.
- 7. NEW CMU MECHANICAL SCREEN WALL.
- 8. NEW MECHANICAL PAD, SEE STRUCTURAL.
- 9. EXISTING BENCH TO REMAIN.
- 10. EXISTING PUMP HOUSING TO REMAIN.
- 11. NEW BEAM PER STRUCTURAL. AFTER BEAM INSTALLATION CONFIGURE GRADING TO ACCOMMODATE FOR STORM WATER FLOW THROUGH AREA WITH CONCRETE DRAINAGE PATHS OR SIMILAR.
- 12. DEMO EXISTING RAILING WHERE IN CONFLICT WITH GROUND REMOVAL AND COORDINATE NEW RAILING EXTENSION WITH OWNER.
- 13. EXISTING CONCRETE BEAM SYSTEM BELOW TO BE PROTECTED IN PLACE.
- 14. REMOVE PORTION OF EARTHWORK AS REQUIRED FOR INSTALLATION OF NEW BEAM. EXISTING CONCRETE, ADJACENT BEAMS AND ALL OTHER STRUCTURAL ELEMENTS TO BE PROTECTED IN PLACE. SHORE/BRACE AS REQUIRED. SEE STRUCTURAL.
- 15. VENT THRU ROOF. REMOVE / REPLACE EARTH WORK AS NEEDED. PROVIDE BITUMINOUS MEMBRANE WITH VENT BOOT AS REQUIRED AT ROOF PENETRATION. REFER TO MECHANICAL PLUMBING DRAWINGS AND DETAILS FOR CONCRETE WORK AND MORE INFORMATION. PAINT EXPOSED PIPE (COLOR TBD) FOR SAFETY.
- 16. REMOVE EXISTING EARTHWORK AND VEGETATION. REGRADE SLOPE AS NEEDED FOR NEW EQUIPMENT PADS. PROVIDE UNGROUTED RIPRAP TO STABILIZE NEW SLOPE.



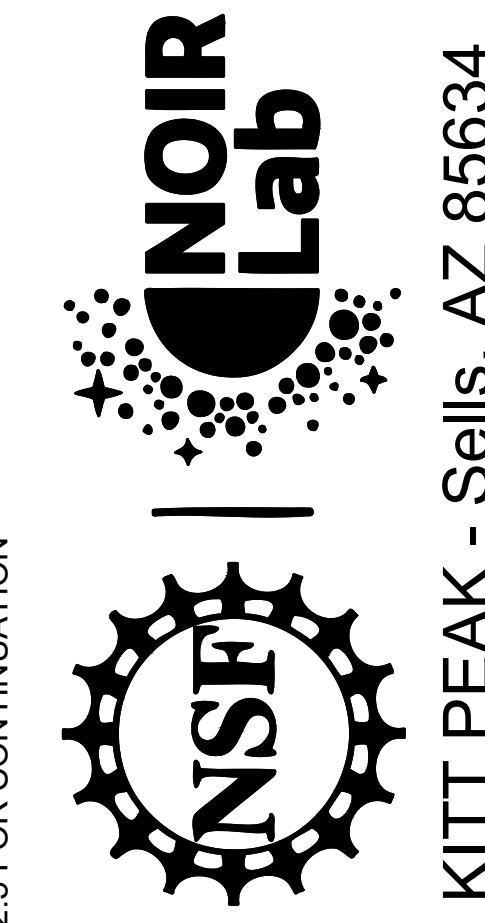WINDOWS ON
THE UNIVERSE
CENTER FOR
ASTRONOMY
OUTREACH



KITT PEAK - Sells, AZ 85634

△	DATE	DESCRIPTION
0	01/08/21	I.F.C.

PROJECT NUMBER: 11904.00
 DRAWN BY:
 CHECKED BY: IR
 CAD FILE: 11904.00-A2.4
 SCALE: AS NOTED

ENLARGED RENO
ROOF
AREA A

A2.4

1 ARCHITECTURAL ENLARGED RENO ROOF PLAN - AREA A
1ST. LEVEL

SCALE: 1/4" = 1'-0"
N

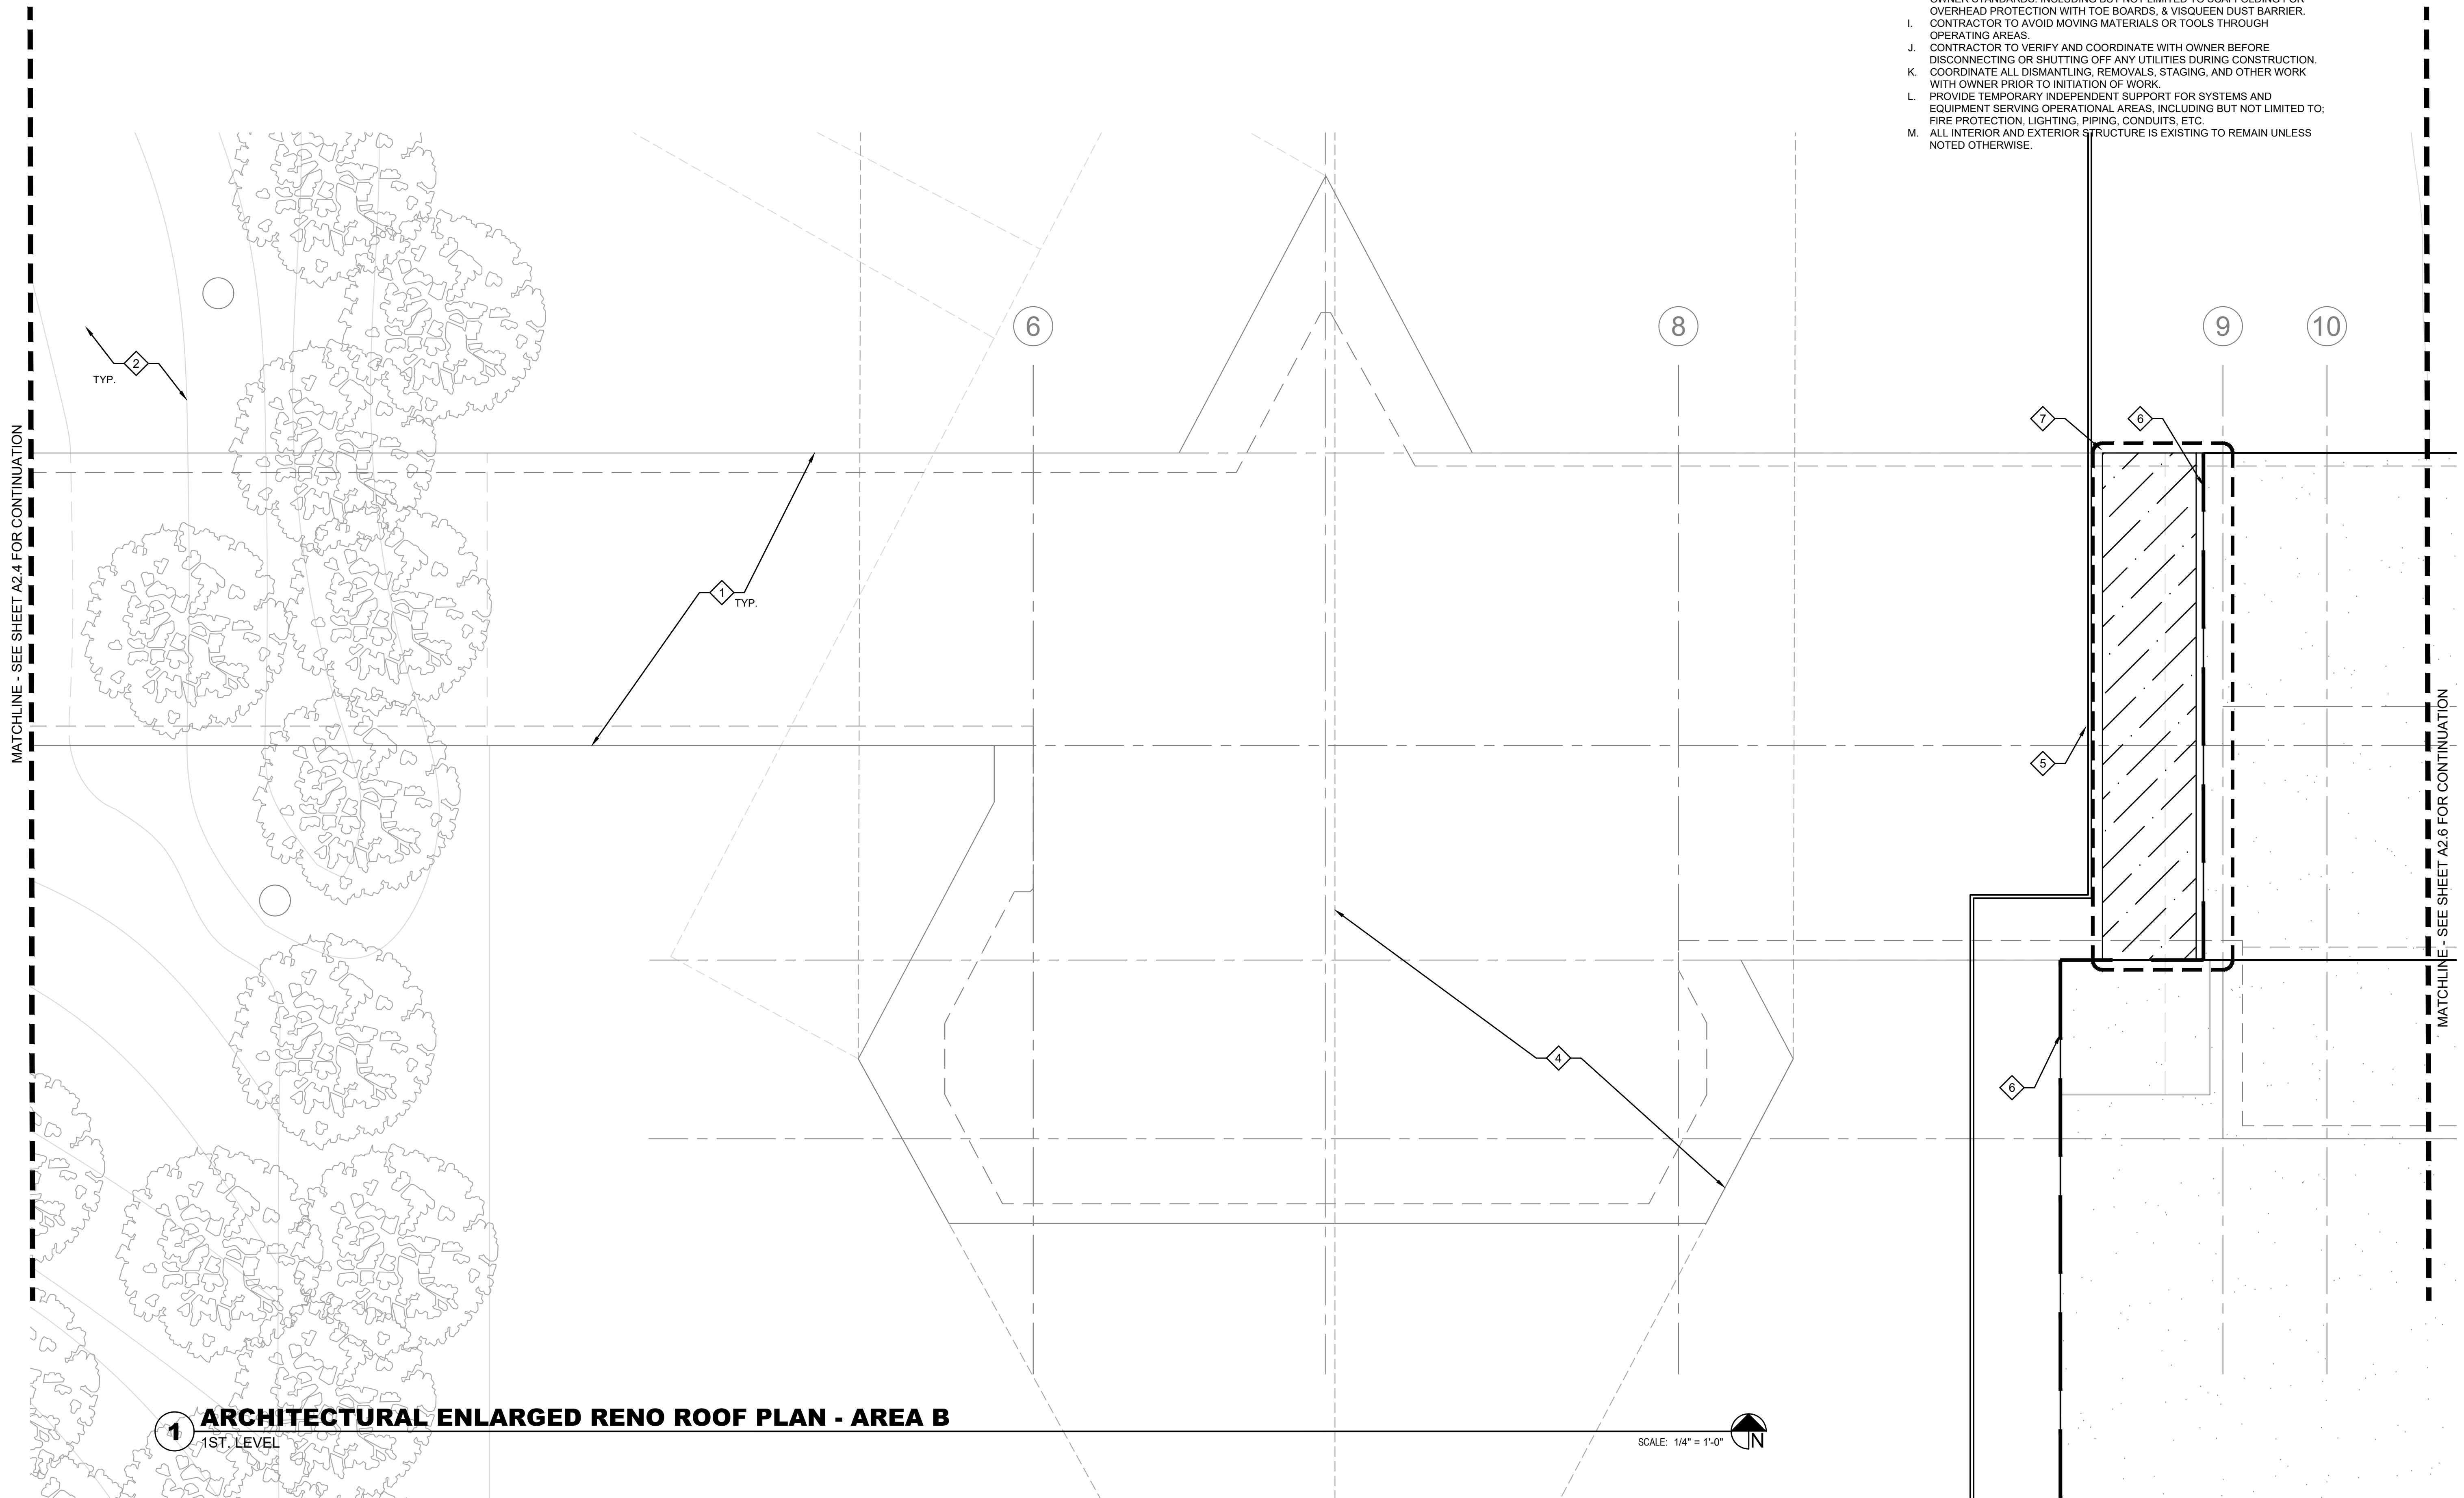
MATCH-LINE - SEE SHEET A2.5 FOR CONTINUATION

ROOF KEYNOTES:

1. EXISTING SUBTERRANEAN STRUCTURE TO REMAIN.
2. EXISTING STORM WATER DRAINAGE PATHS TO REMAIN.
3. NOT USED
4. EXISTING TELESCOPE SHAFT TO BE PROTECTED DURING CONSTRUCTION.
5. EXISTING FENCING TO REMAIN.
6. EXISTING SEALANT BETWEEN STONE AND EXTERIOR WALL IS DETERIORATING. REMOVE EXISTING SEALANT, CLEAN JOINT, AND REPLACE WITH SIKAFLEX-15 LM OR EQUAL.
7. BID ALTERNATE # 1: CONTRACTOR TO PROVIDE ALTERNATE PRICING FOR REMOVAL OF EXISTING EARTH WORK BACKFILL (+/- 20" DEEP) TO FULLY EXPOSE RETAINING WALL. PROVIDE A FULLY ADHERED WATERPROOF MEMBRANE SYSTEM. BASIS OF DESIGN: DELTA - MS - BELOW GRADE DIMPLED MEMBRANE. CONTRACTOR TO REINSTALL / COMPACT BACKFILL AS REQUIRED. RE-INSTALL GROUND COVER PER EXISTING CONDITIONS.

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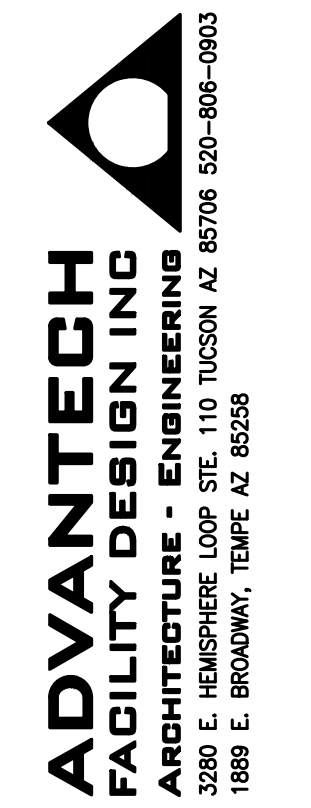


MATCHLINE - SEE SHEET A2.4 FOR CONTINUATION


MATCHLINE - SEE SHEET A2.6 FOR CONTINUATION

1 ARCHITECTURAL ENLARGED RENO ROOF PLAN - AREA B
1ST LEVEL

SCALE: 1/4" = 1'-0"



WINDOWS ON
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OUTREACH

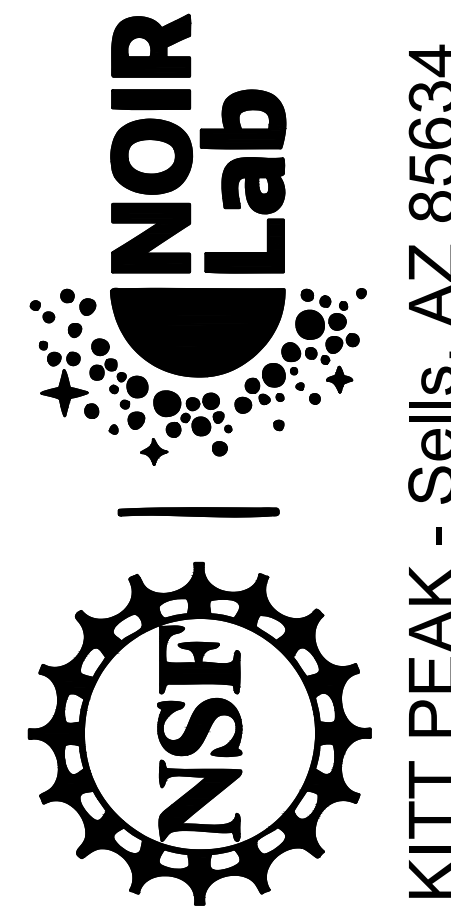


KITT PEAK - Sells, AZ 85634

Δ	DATE	DESCRIPTION
0	01/08/21	I.F.C.

PROJECT NUMBER: 11904.00
DRAWN BY: IR
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CAD FILE: 11904.00-A2.5
SCALE: AS NOTED



ENLARGED RENO
ROOF
AREA B

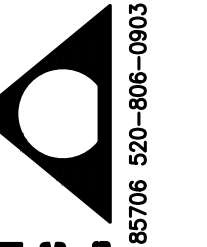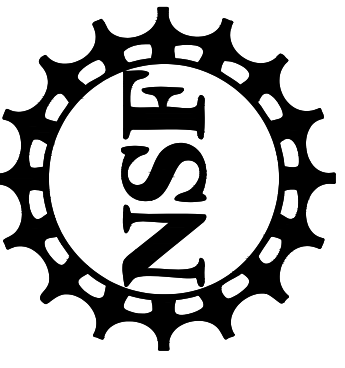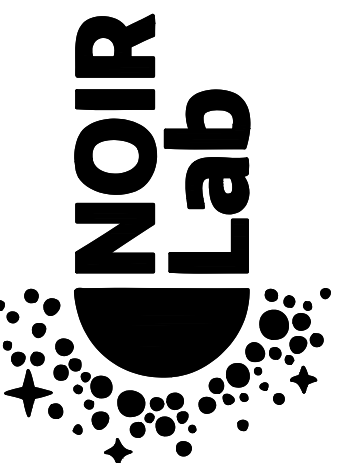A2.5



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3280 E. HENSHIRE LOOP STE. 110 TUCSON AZ 85706 520-806-0903
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WINDOWS ON
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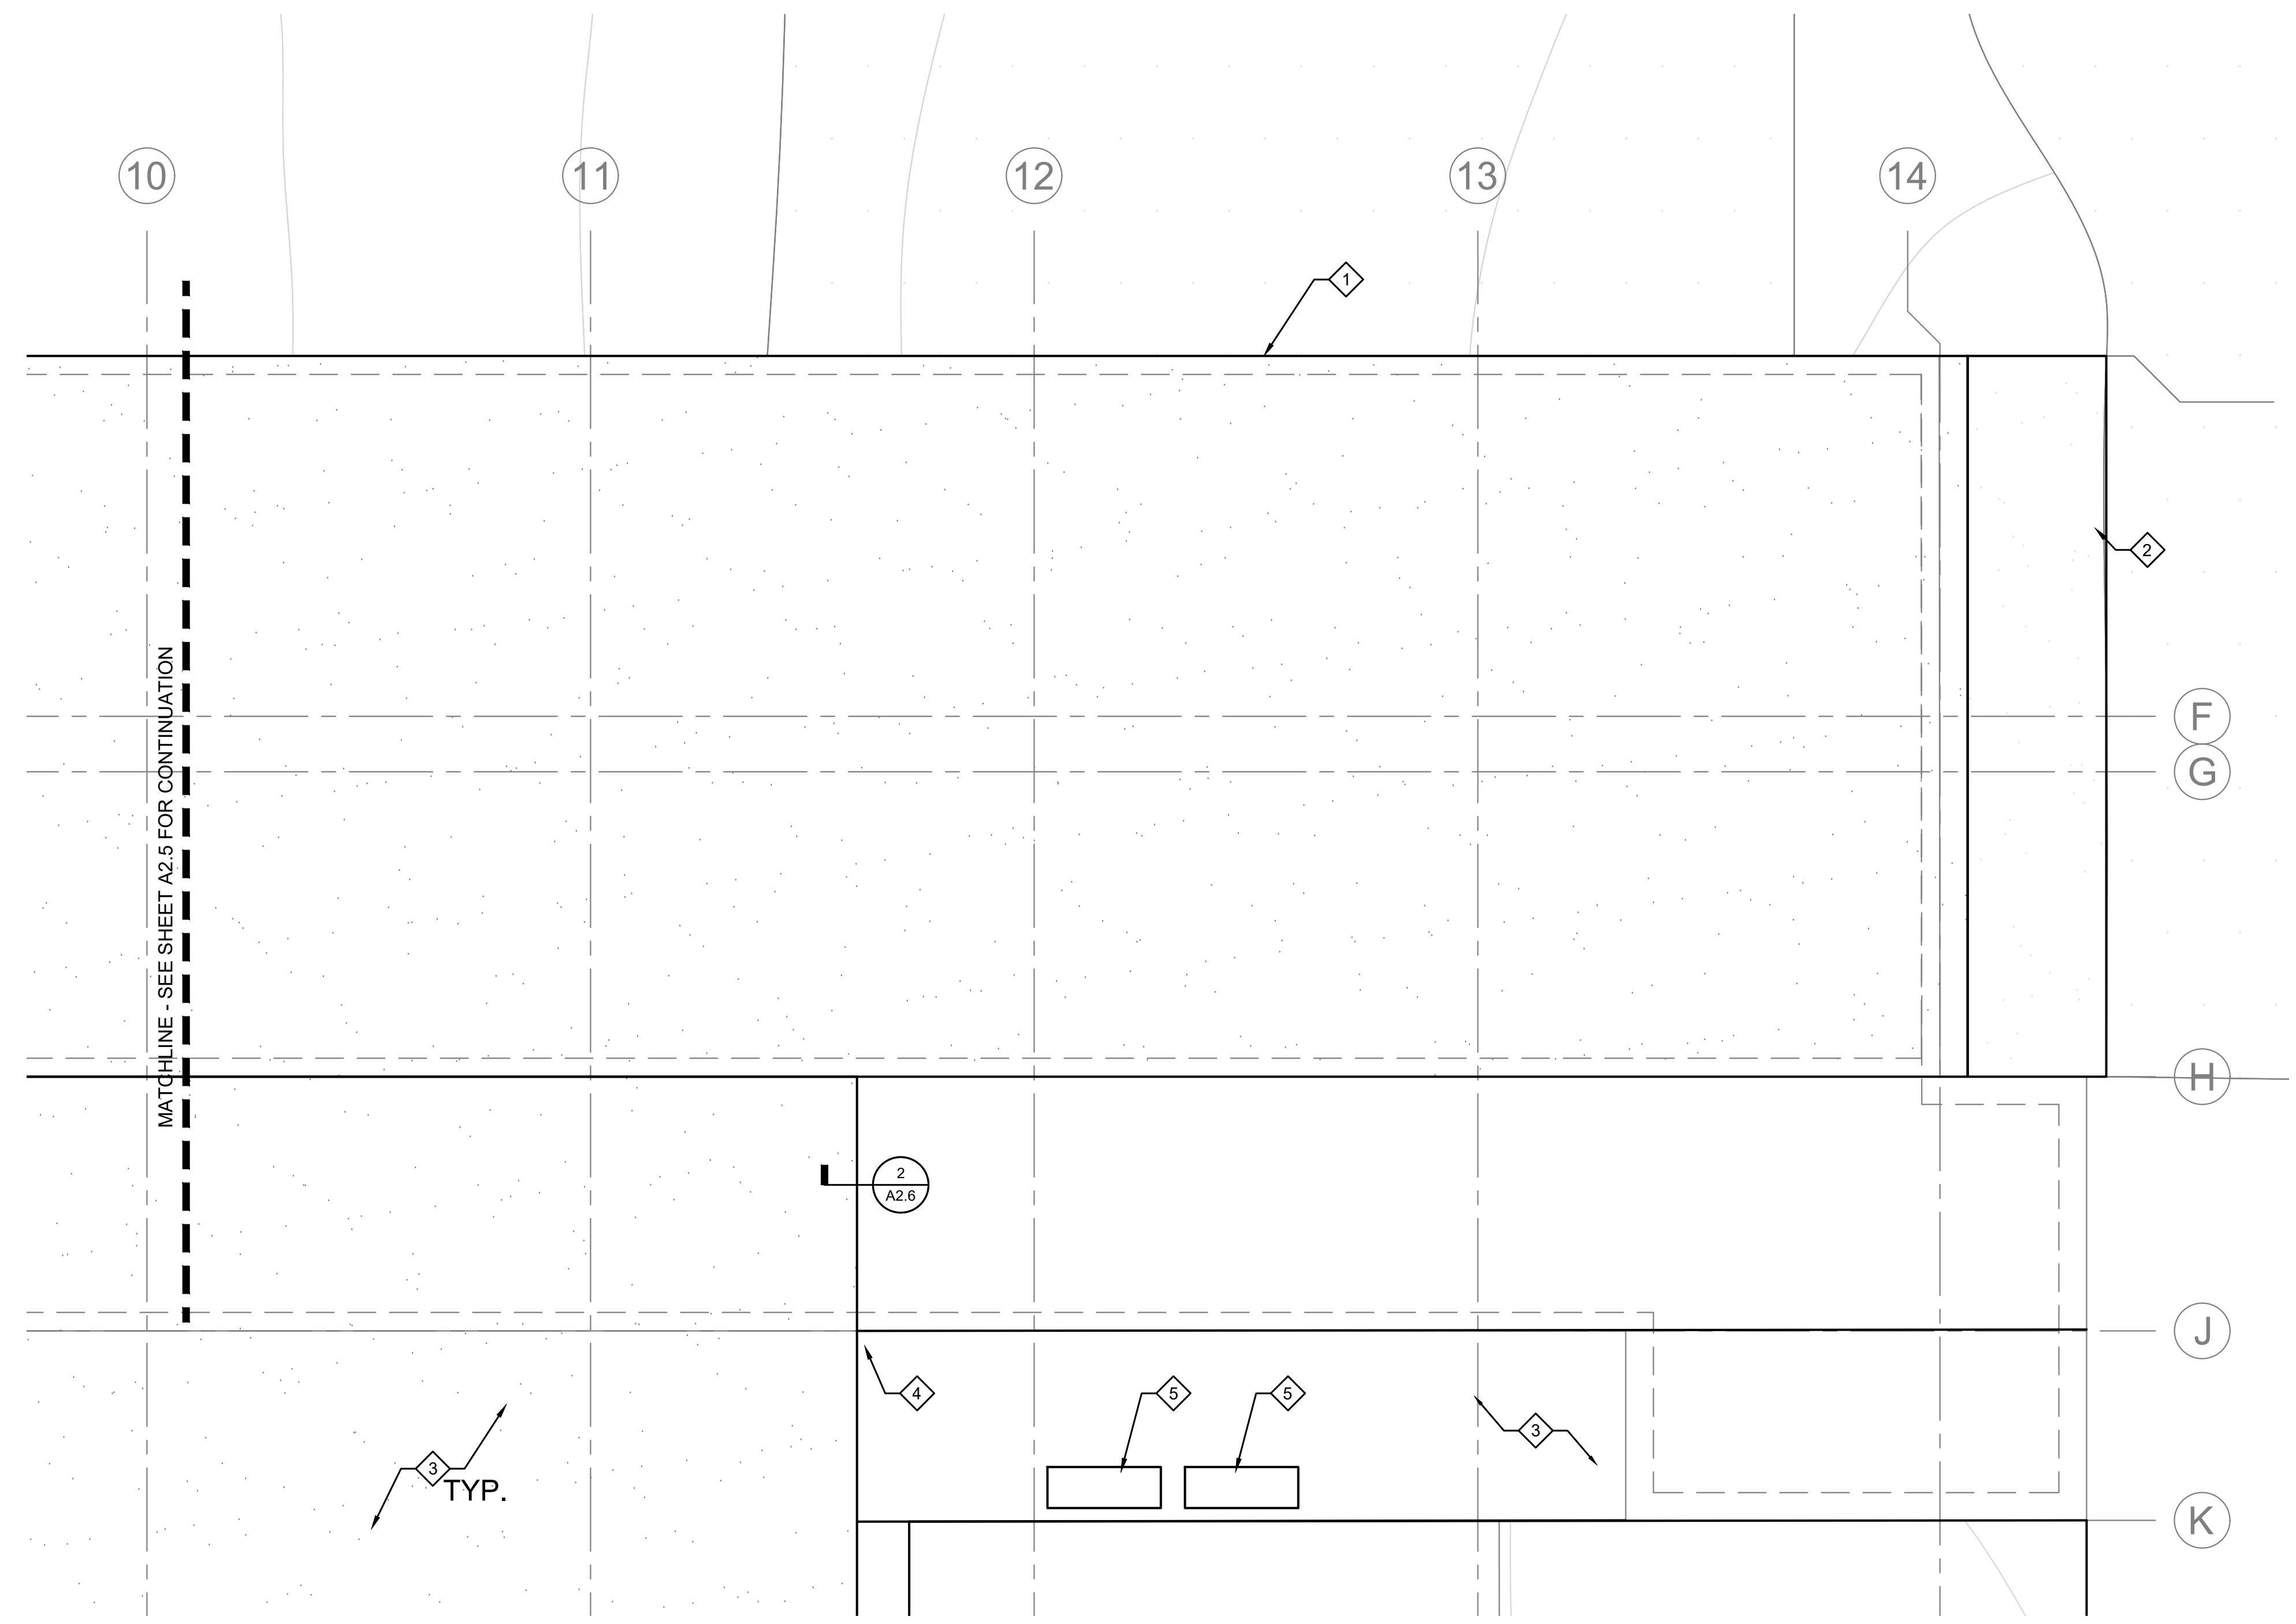
KITT PEAK - Sells, AZ 85634

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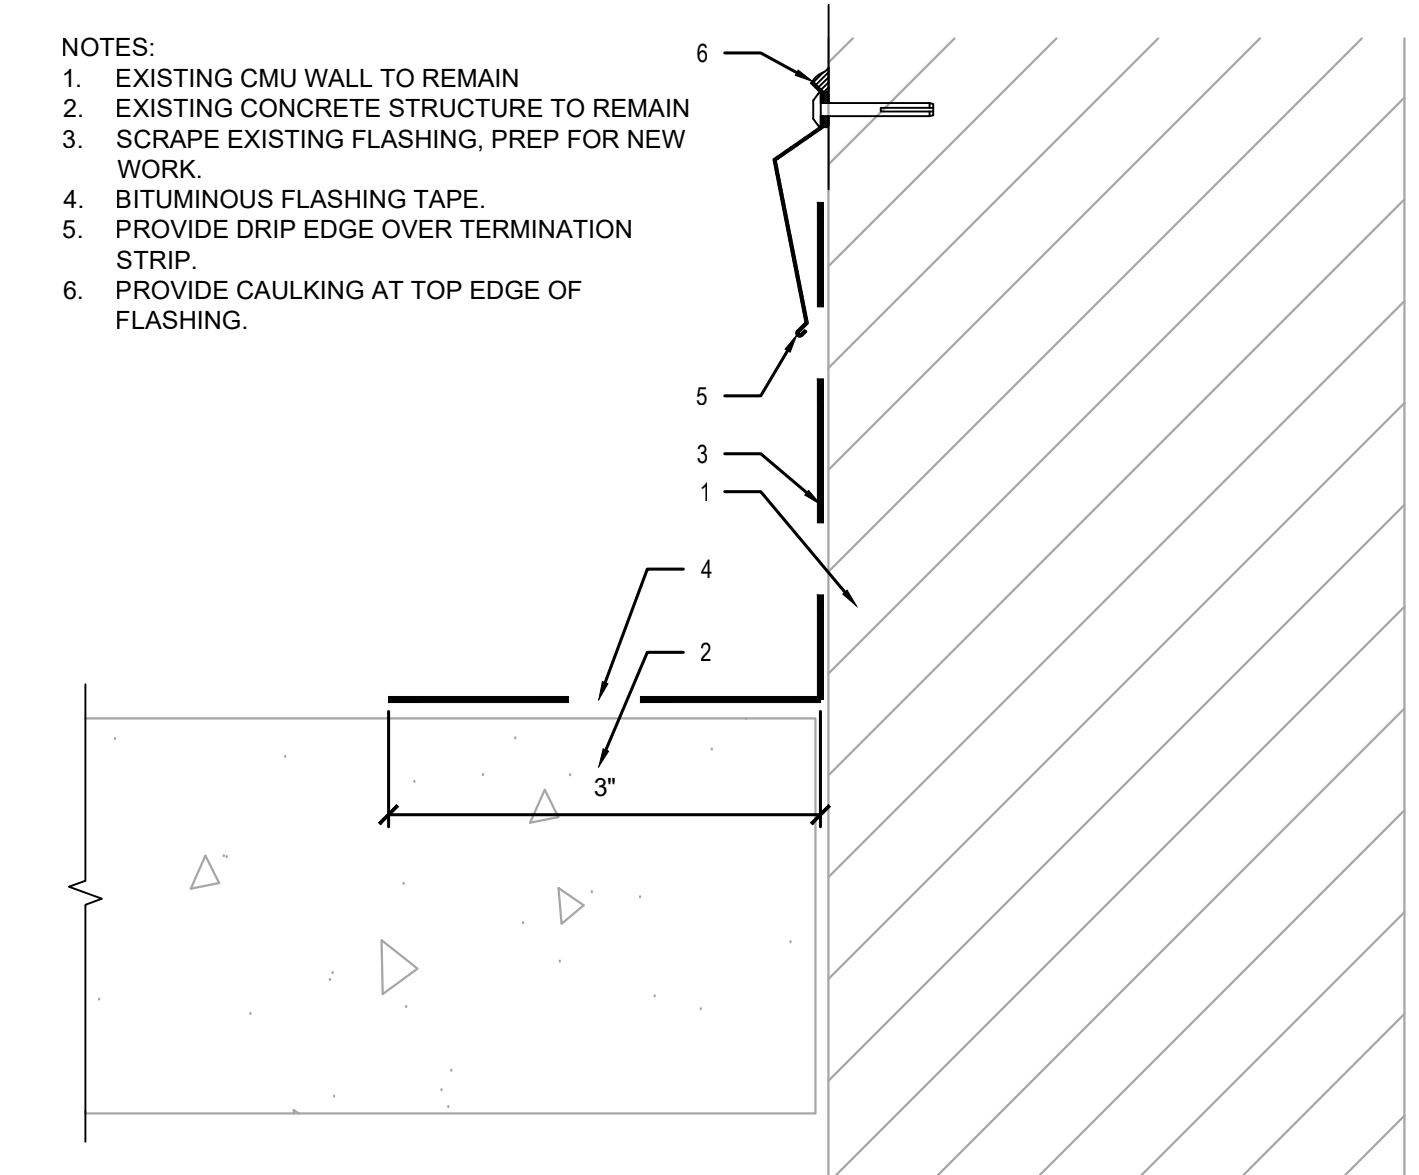
RCP KEYNOTES:

- 1. EXISTING BUILDING OVER SQS THEATER TO REMAIN.
- 2. BROKEN WINDOW TO BE REPAIRED TO AVOID FUTURE WEATHER ISSUES ABOVE THEATER.
- 3. EXISTING ROOFING AND FLASHING TO BE REPAIRED WHERE NEEDED.
- 4. IDENTIFIED FLASHING/ROOFING ISSUE TO BE REPAIRED.
- 5. EXISTING MECHANICAL TO BE PROTECTED IN PLACE AND TO REMAIN.



1 ARCHITECTURAL ENLARGED RENO ROOF PLAN - AREA C
1ST. LEVEL

SCALE: 1/4" = 1'-0"



- NOTES:
- 1. EXISTING CMU WALL TO REMAIN
 - 2. EXISTING CONCRETE STRUCTURE TO REMAIN
 - 3. SCRAPE EXISTING FLASHING, PREP FOR NEW WORK.
 - 4. BITUMINOUS FLASHING TAPE
 - 5. PROVIDE DRIP EDGE OVER TERMINATION STRIP.
 - 6. PROVIDE CAULKING AT TOP EDGE OF FLASHING.

2 EX. CONCRETE JOINT SEAL


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DATE	DESCRIPTION
01/08/21	I.F.C.

PROJECT NUMBER: 11904.00
DRAWN BY:
CHECKED BY: IR
CAD FILE: 11904.00-A2.6
SCALE: AS NOTED


ENLARGED RENO
ROOF
AREA C

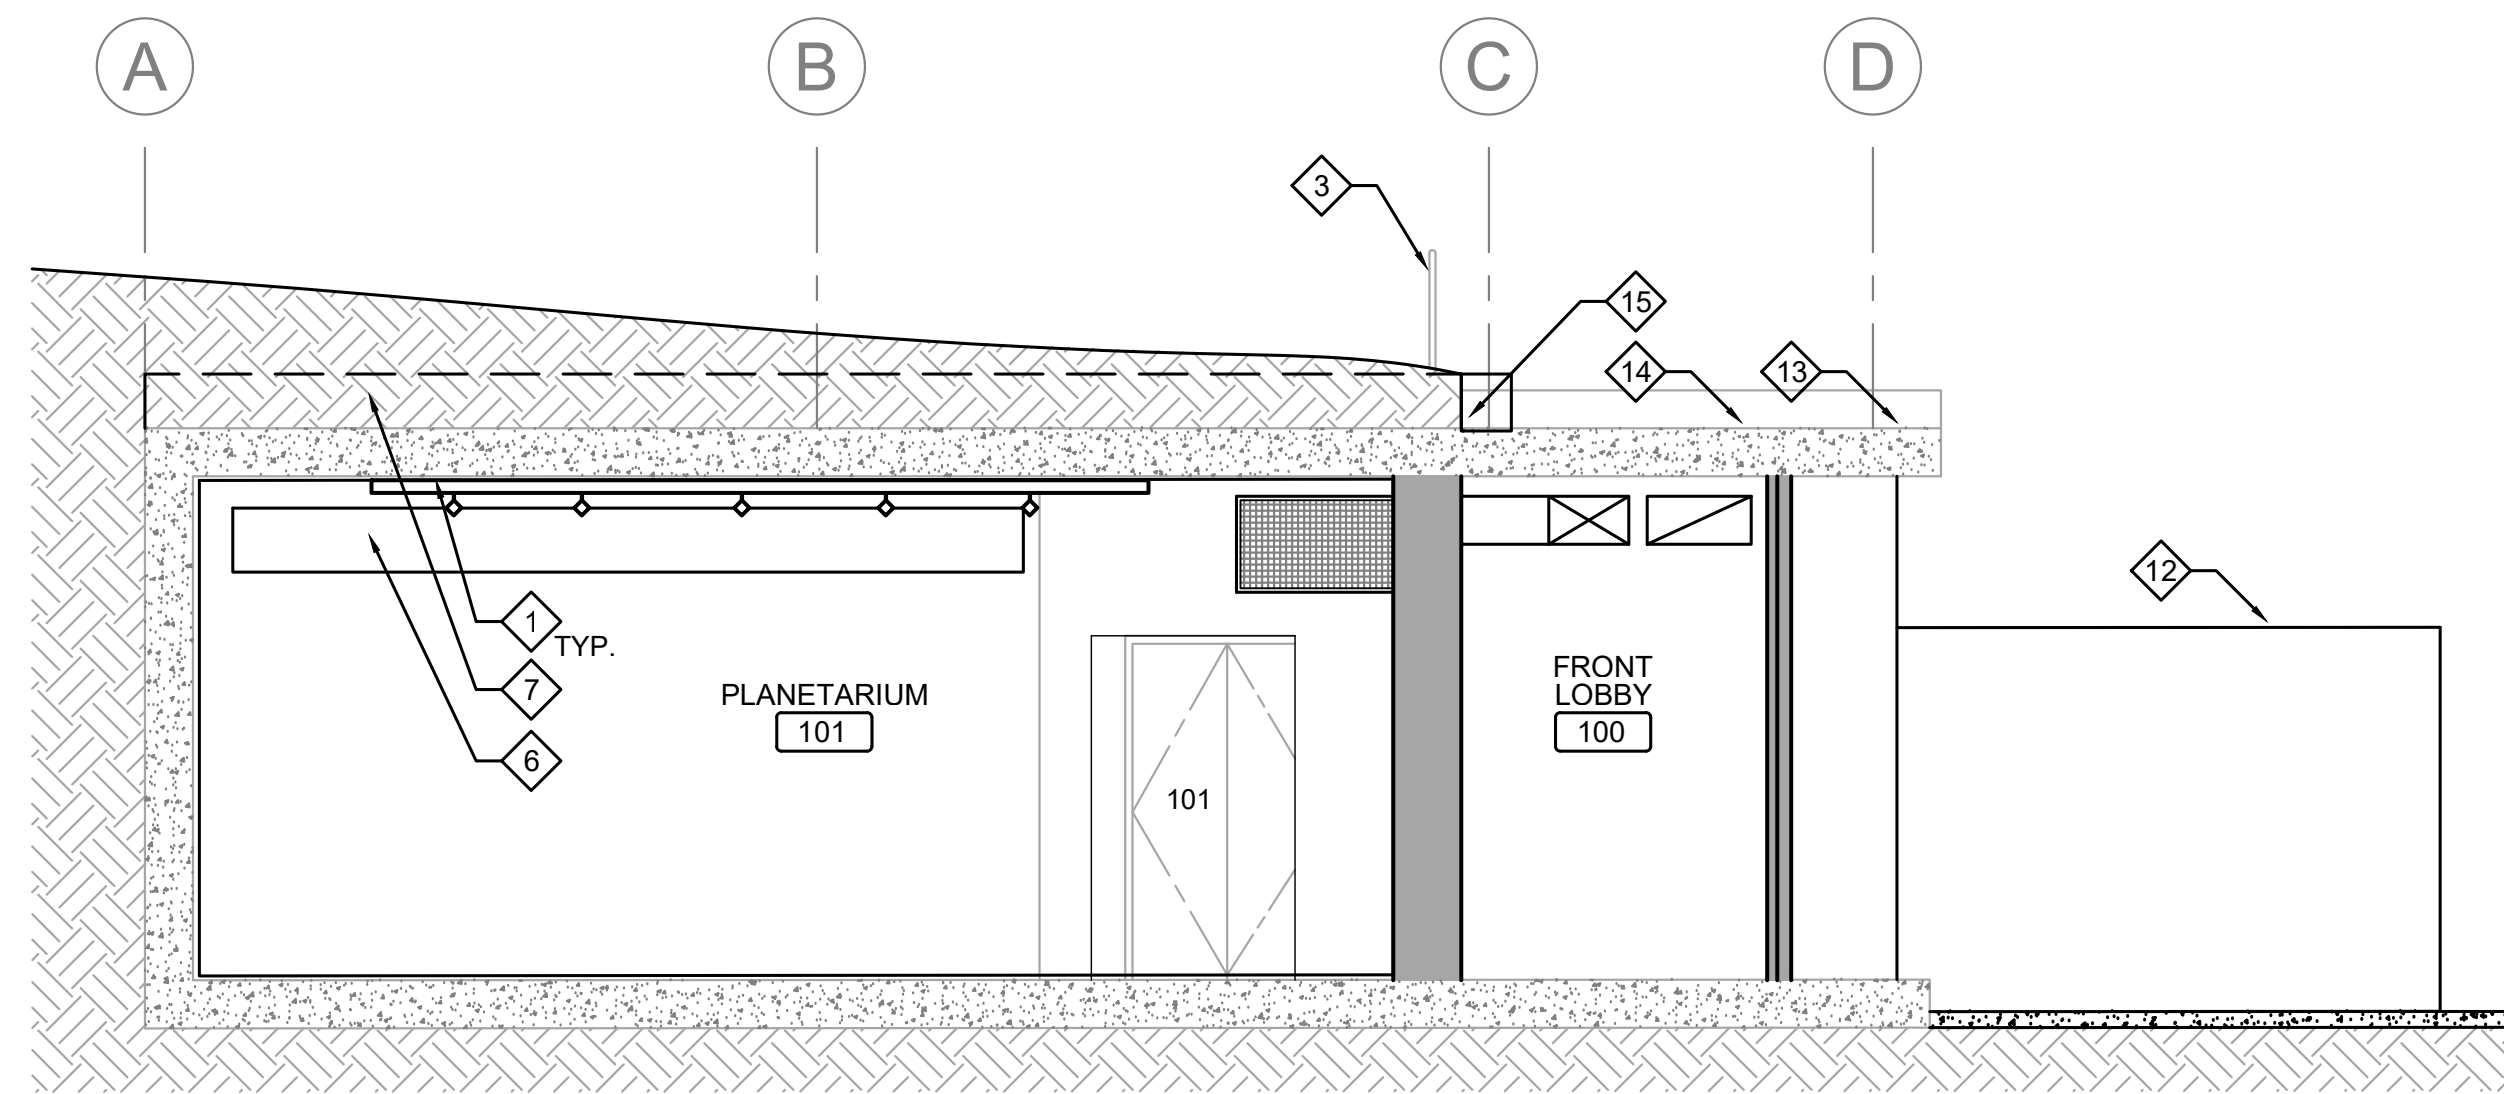A2.6




1 ARCHITECTURAL BUILDING SECTION
1ST. LEVEL
SCALE: 1/4" = 1'-0"

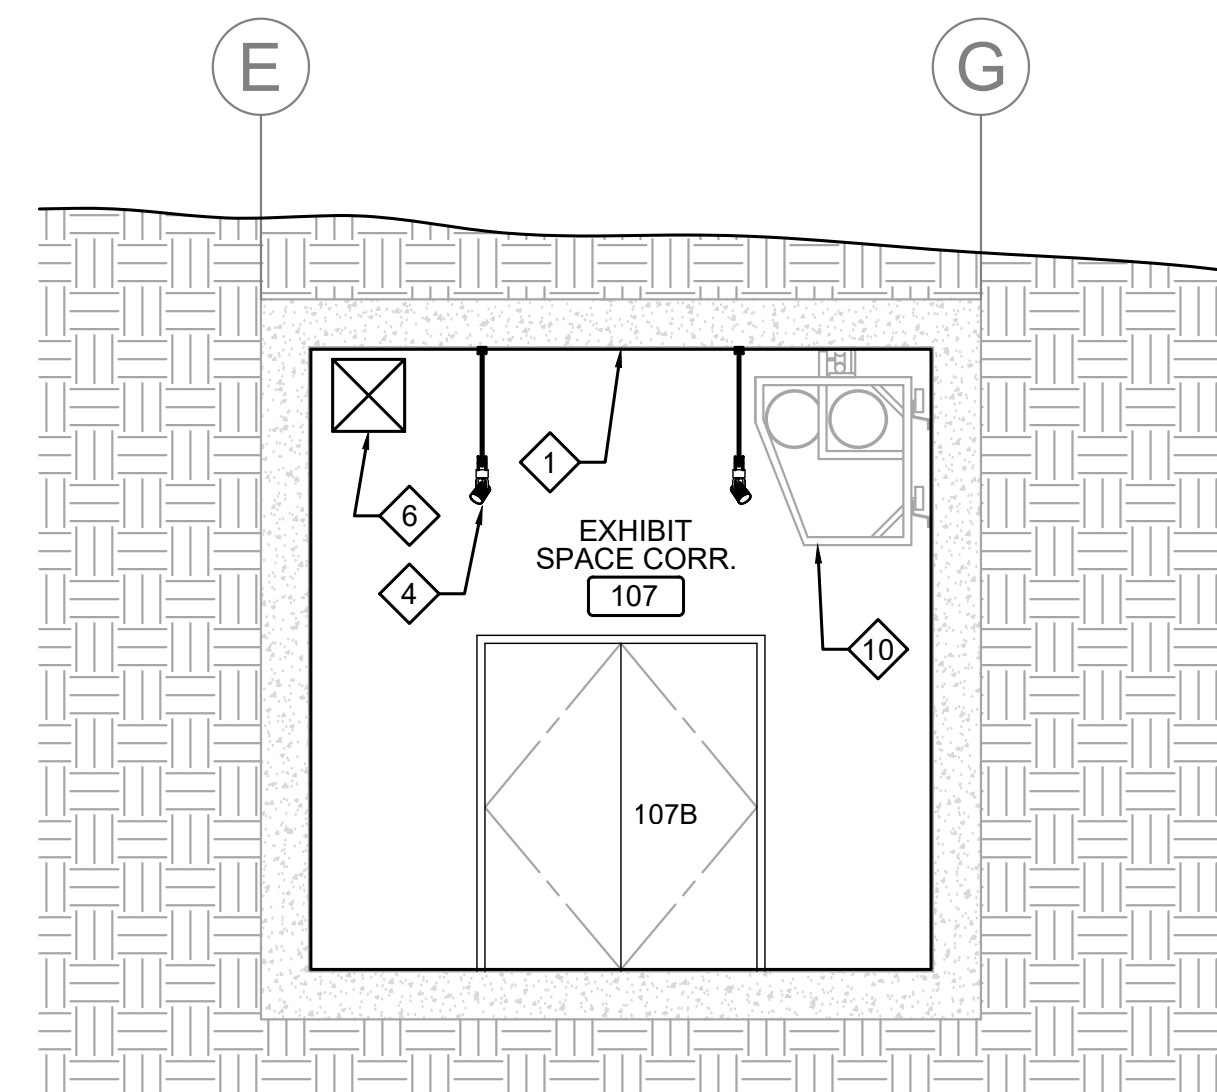SCALE: 1/4" = 1'-0"




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1ST. LEVEL
SCALE: 1/4" = 1'-0"

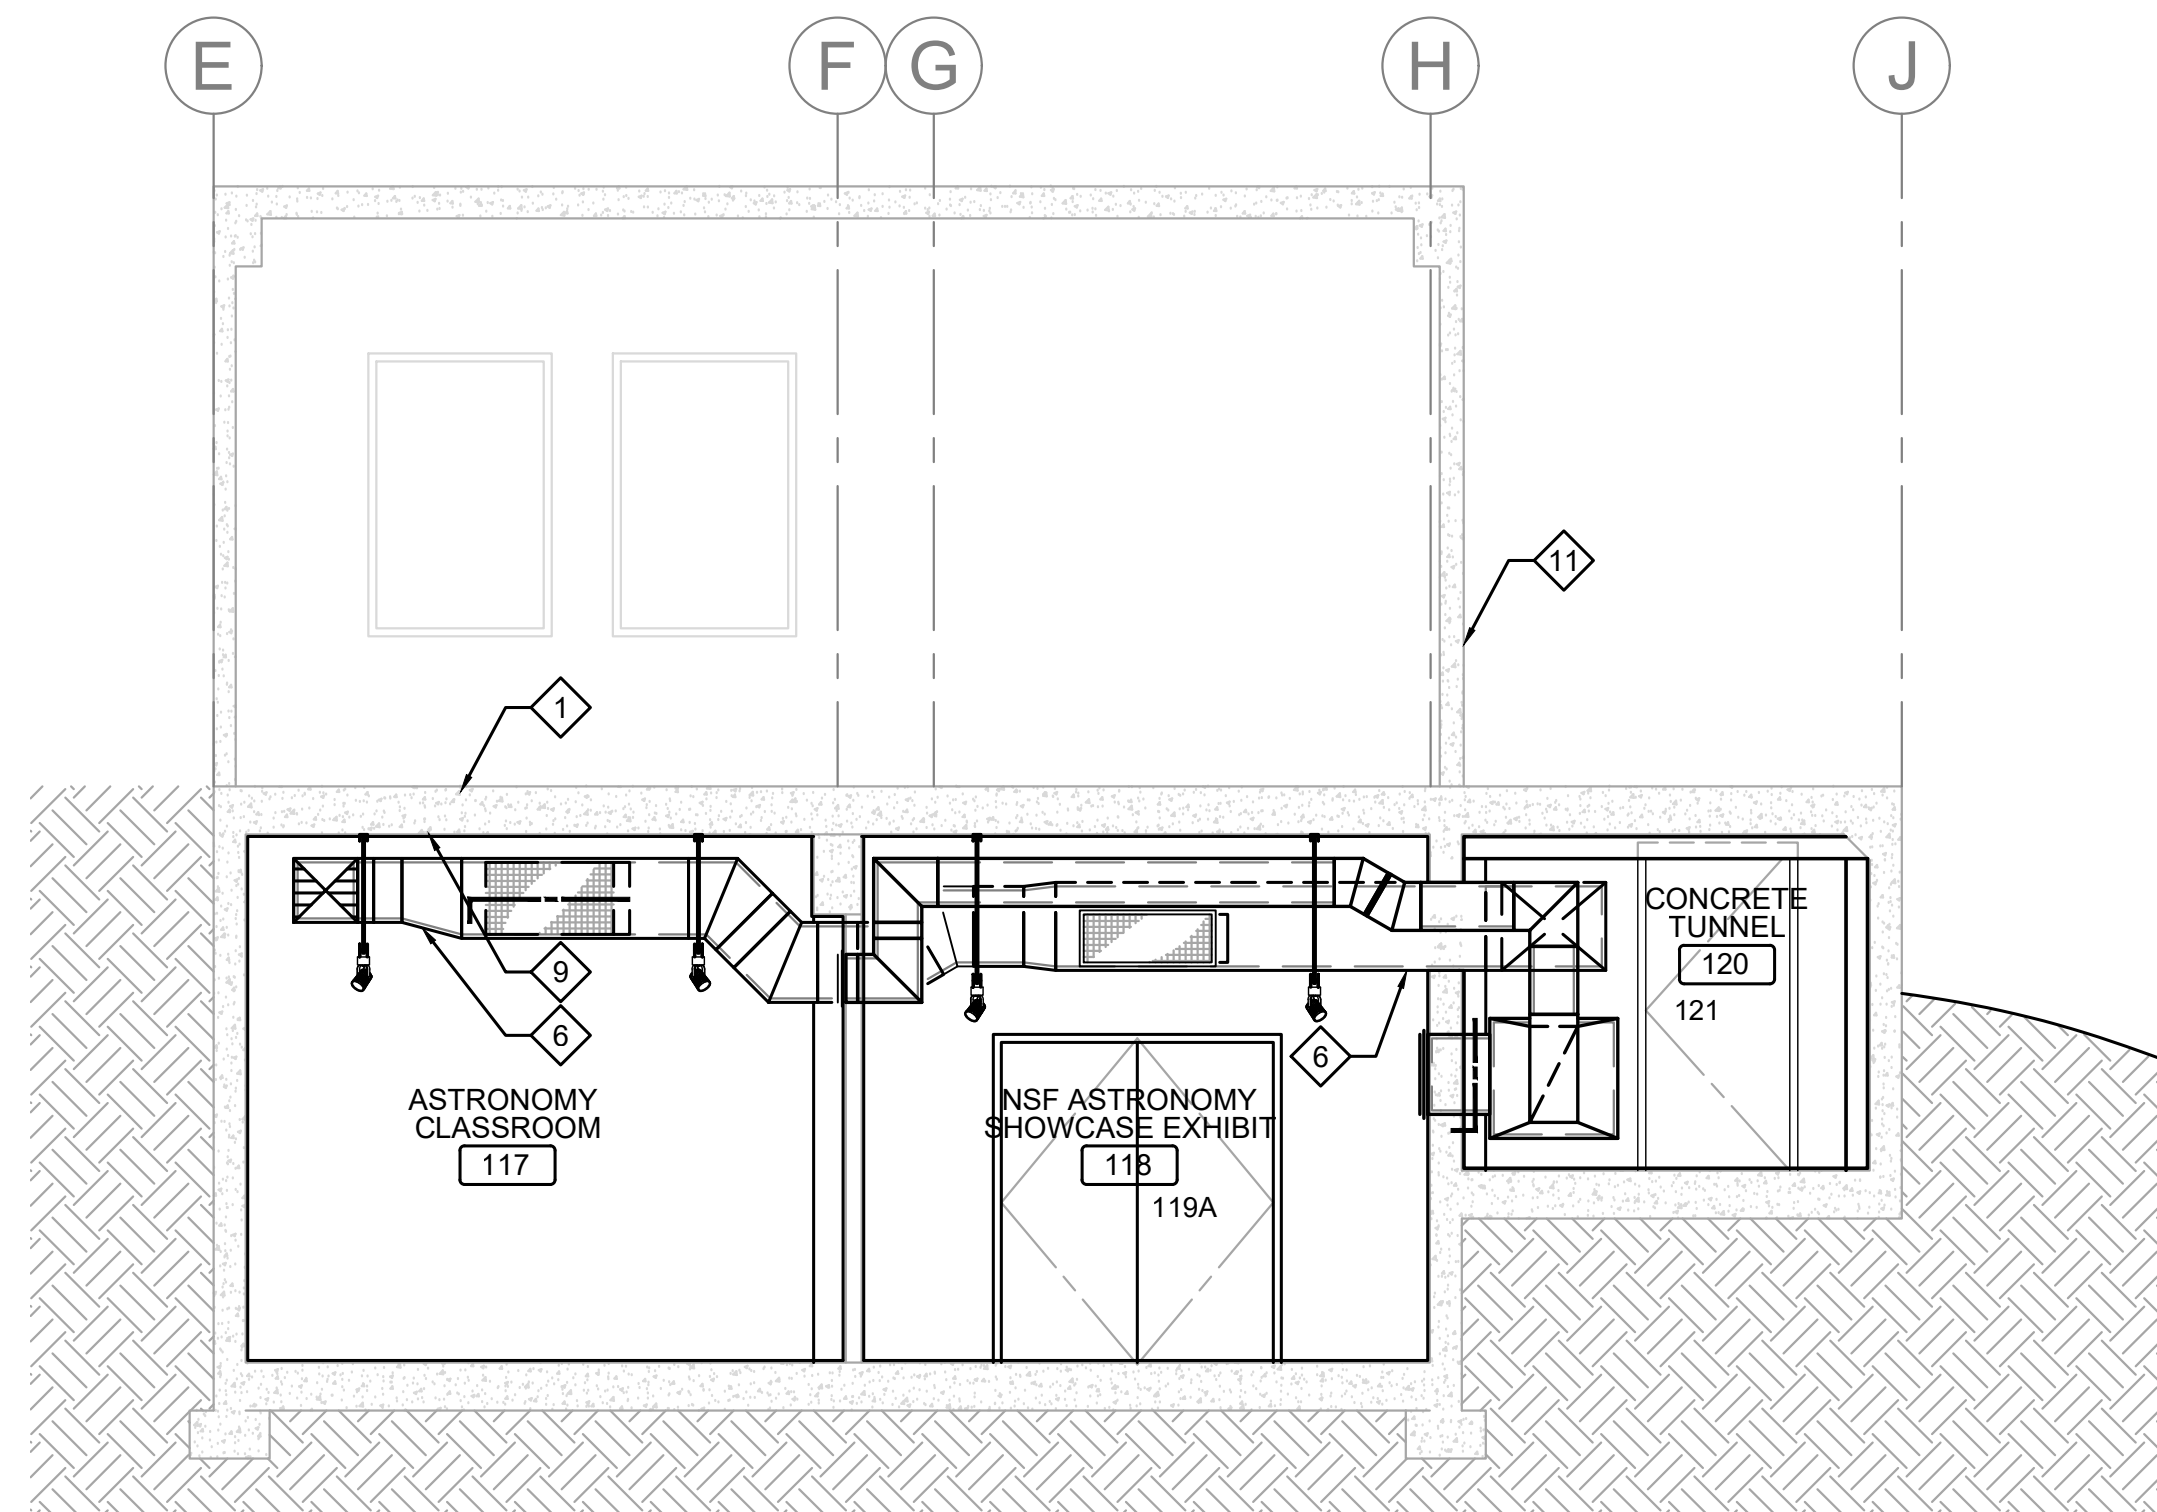SCALE: 1/4" = 1'-0"



3 ARCHITECTURAL BUILDING SECTION
1ST. LEVEL
SCALE: 1/4" = 1'-0"

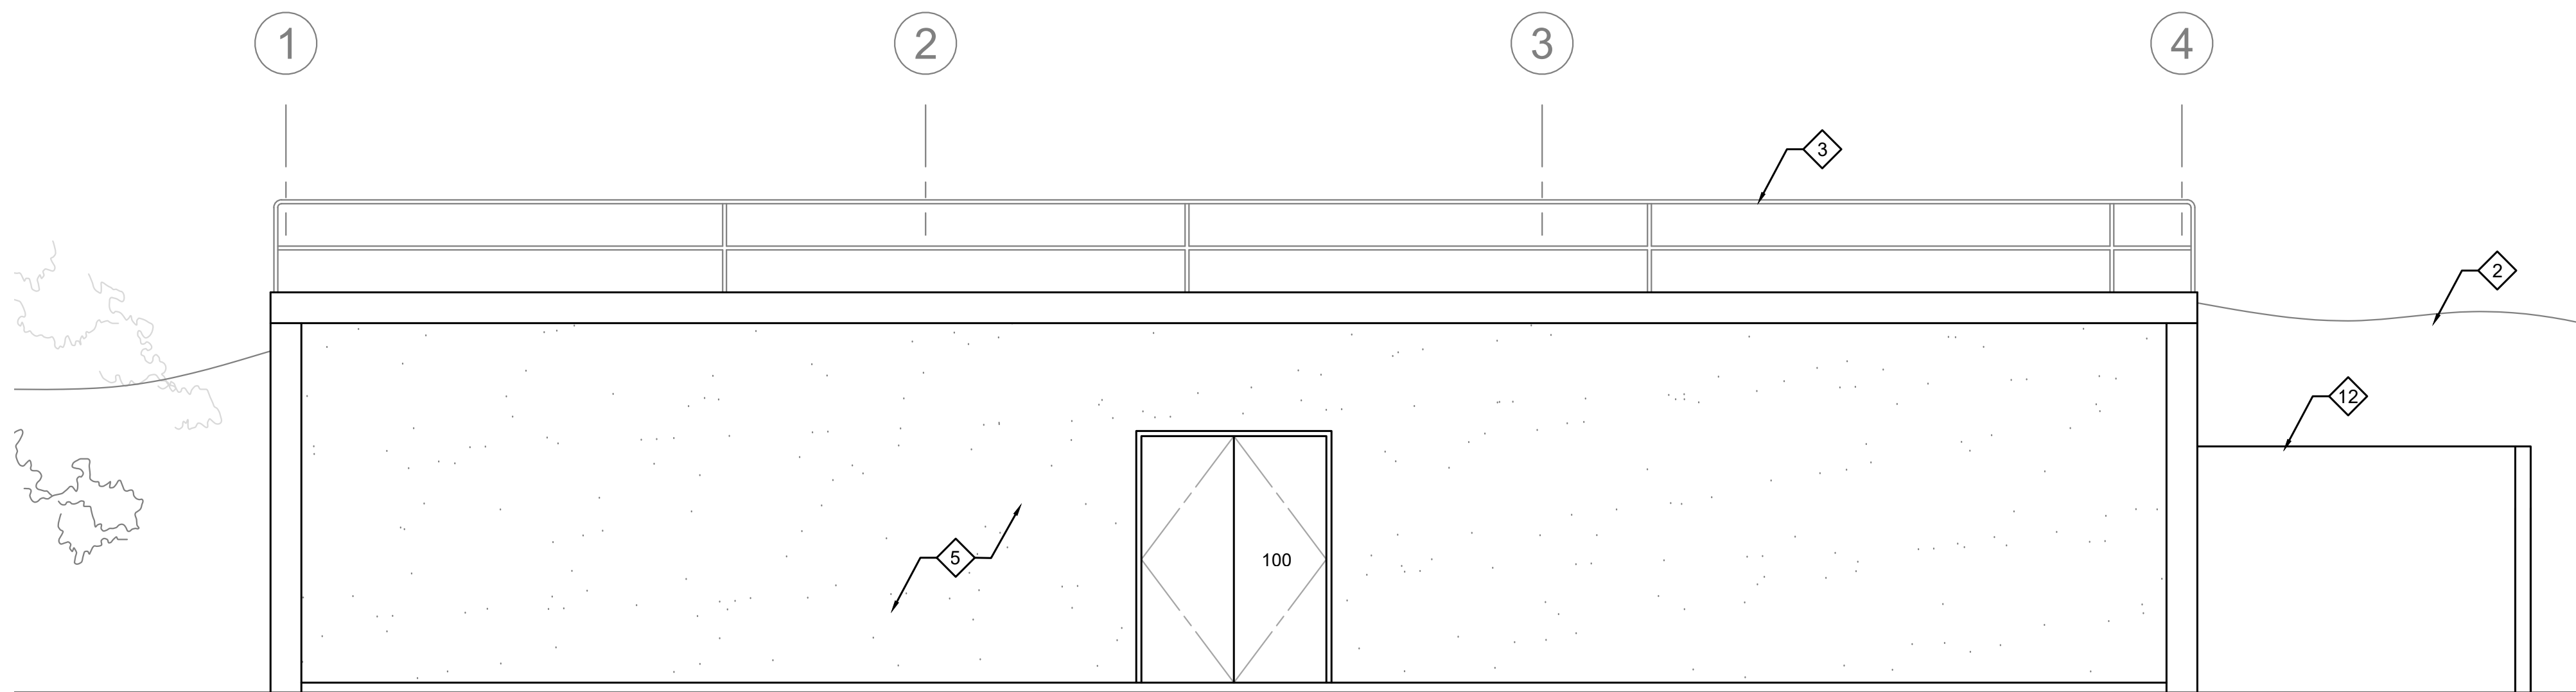SCALE: 1/4" = 1'-0"



4 ARCHITECTURAL BUILDING ELEVATION
1ST. LEVEL
SCALE: 1/4" = 1'-0"

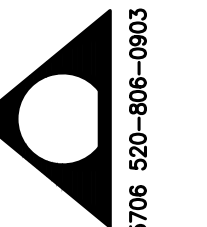
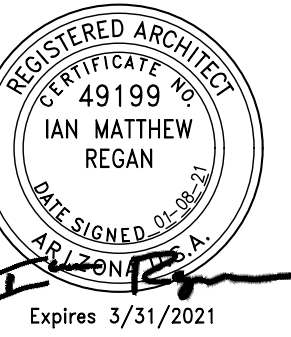
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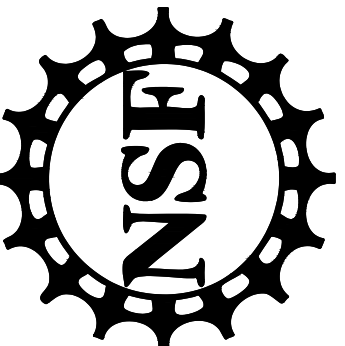
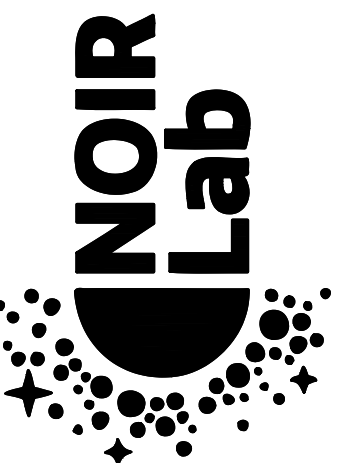
KEYNOTES:

- 1. EXISTING CONCRETE CEILING TO REMAIN
- 2. EXISTING ROCK WALL BEYOND TO REMAIN
- 3. EXISTING PIPE RAILING BEYOND TO REMAIN
- 4. NEW LIGHTING, REFER TO ELECTRICAL FOR MORE INFO.
- 5. NEW WALL PARTITION SEE FLOOR PLAN FOR MORE INFORMATION
- 6. NEW MECHANICAL DUCT SEE MECHANICAL FOR MORE INFORMATION
- 7. REFER TO STRUCTURAL FOR NEW BEAM LOCATED ABOVE CONCRETE DECK, EARTHWORK TO BE REMOVED AND REINSTALLED.
- 8. NOT USED.
- 9. CEILING FINISH PER FINISH SCHEDULE.
- 10. (E) SPECTROGRAPH/ TRACK SYSTEM TO REMAIN, PROTECT DURING CONSTRUCTION.
- 11. (E) SECOND STORY BUILDING TO REMAIN.
- 12. CMU MECHANICAL SCREEN WALL. SEE SITE PLAN.
- 13. EXISTING ROOF CURB TO REMAIN
- 14. EXISTING CURB BEYOND.
- 15. EXISTING BEAM TO BE PROTECTED IN PLACE.



ADVANTECH
FACILITY DESIGN INC.
ARCHITECTURE - ENGINEERING
3280 E. HEMISPHERE LOOP STE. 110 TUCSON AZ 85706
1889 E. BROADWAY, TEMPE, AZ 85288

WINDOWS ON
THE UNIVERSE
CENTER FOR
ASTRONOMY
OUTREACH




KITT PEAK - Sells, AZ 85634

DATE	DESCRIPTION
01/08/21	I.F.C.

PROJECT NUMBER: 11904.00
DRAWN BY: FH
CHECKED BY: IR
CAD FILE: 11904.00-A3.1
SCALE: AS NOTED

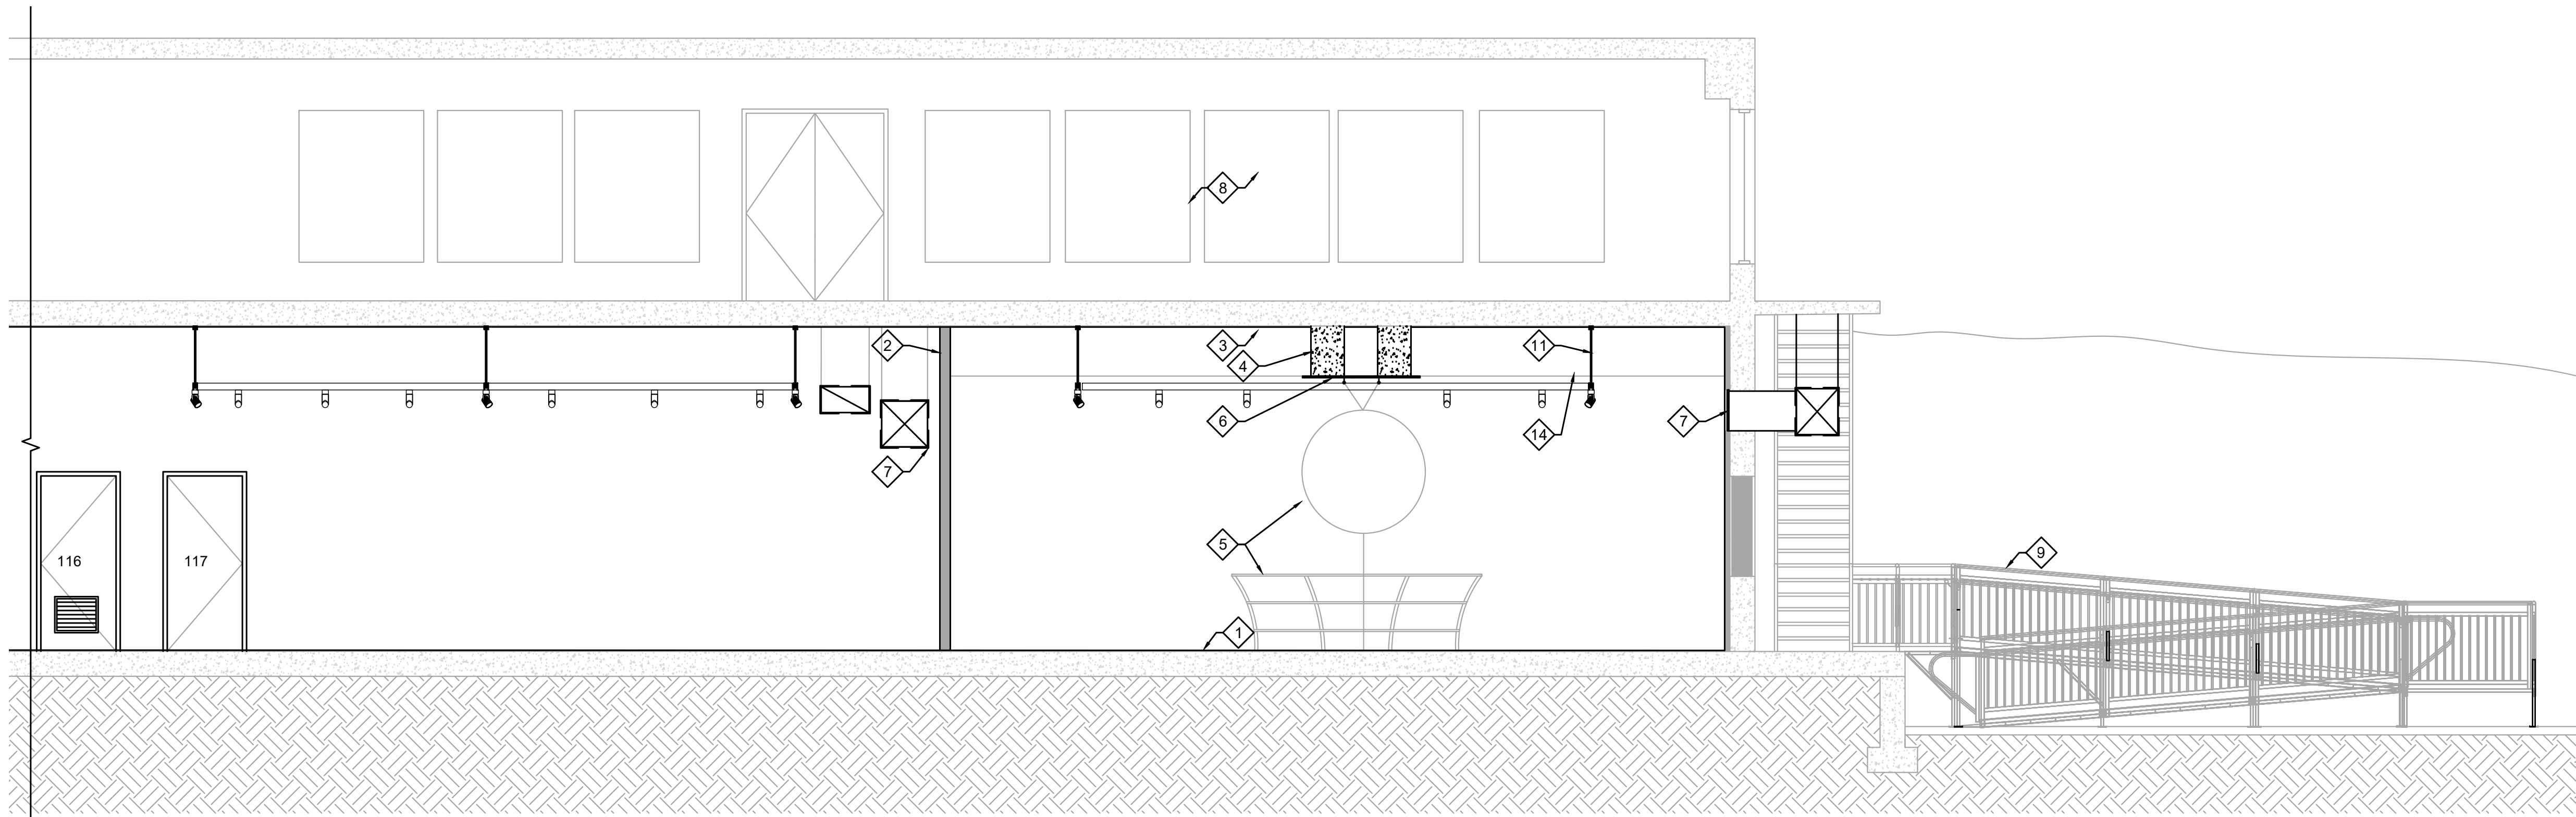BUILDING SECTIONS
AND ELEVATION



2 ARCHITECTURAL BUILDING SECTION
1ST. LEVEL

SCALE: 1/4" = 1'-0"

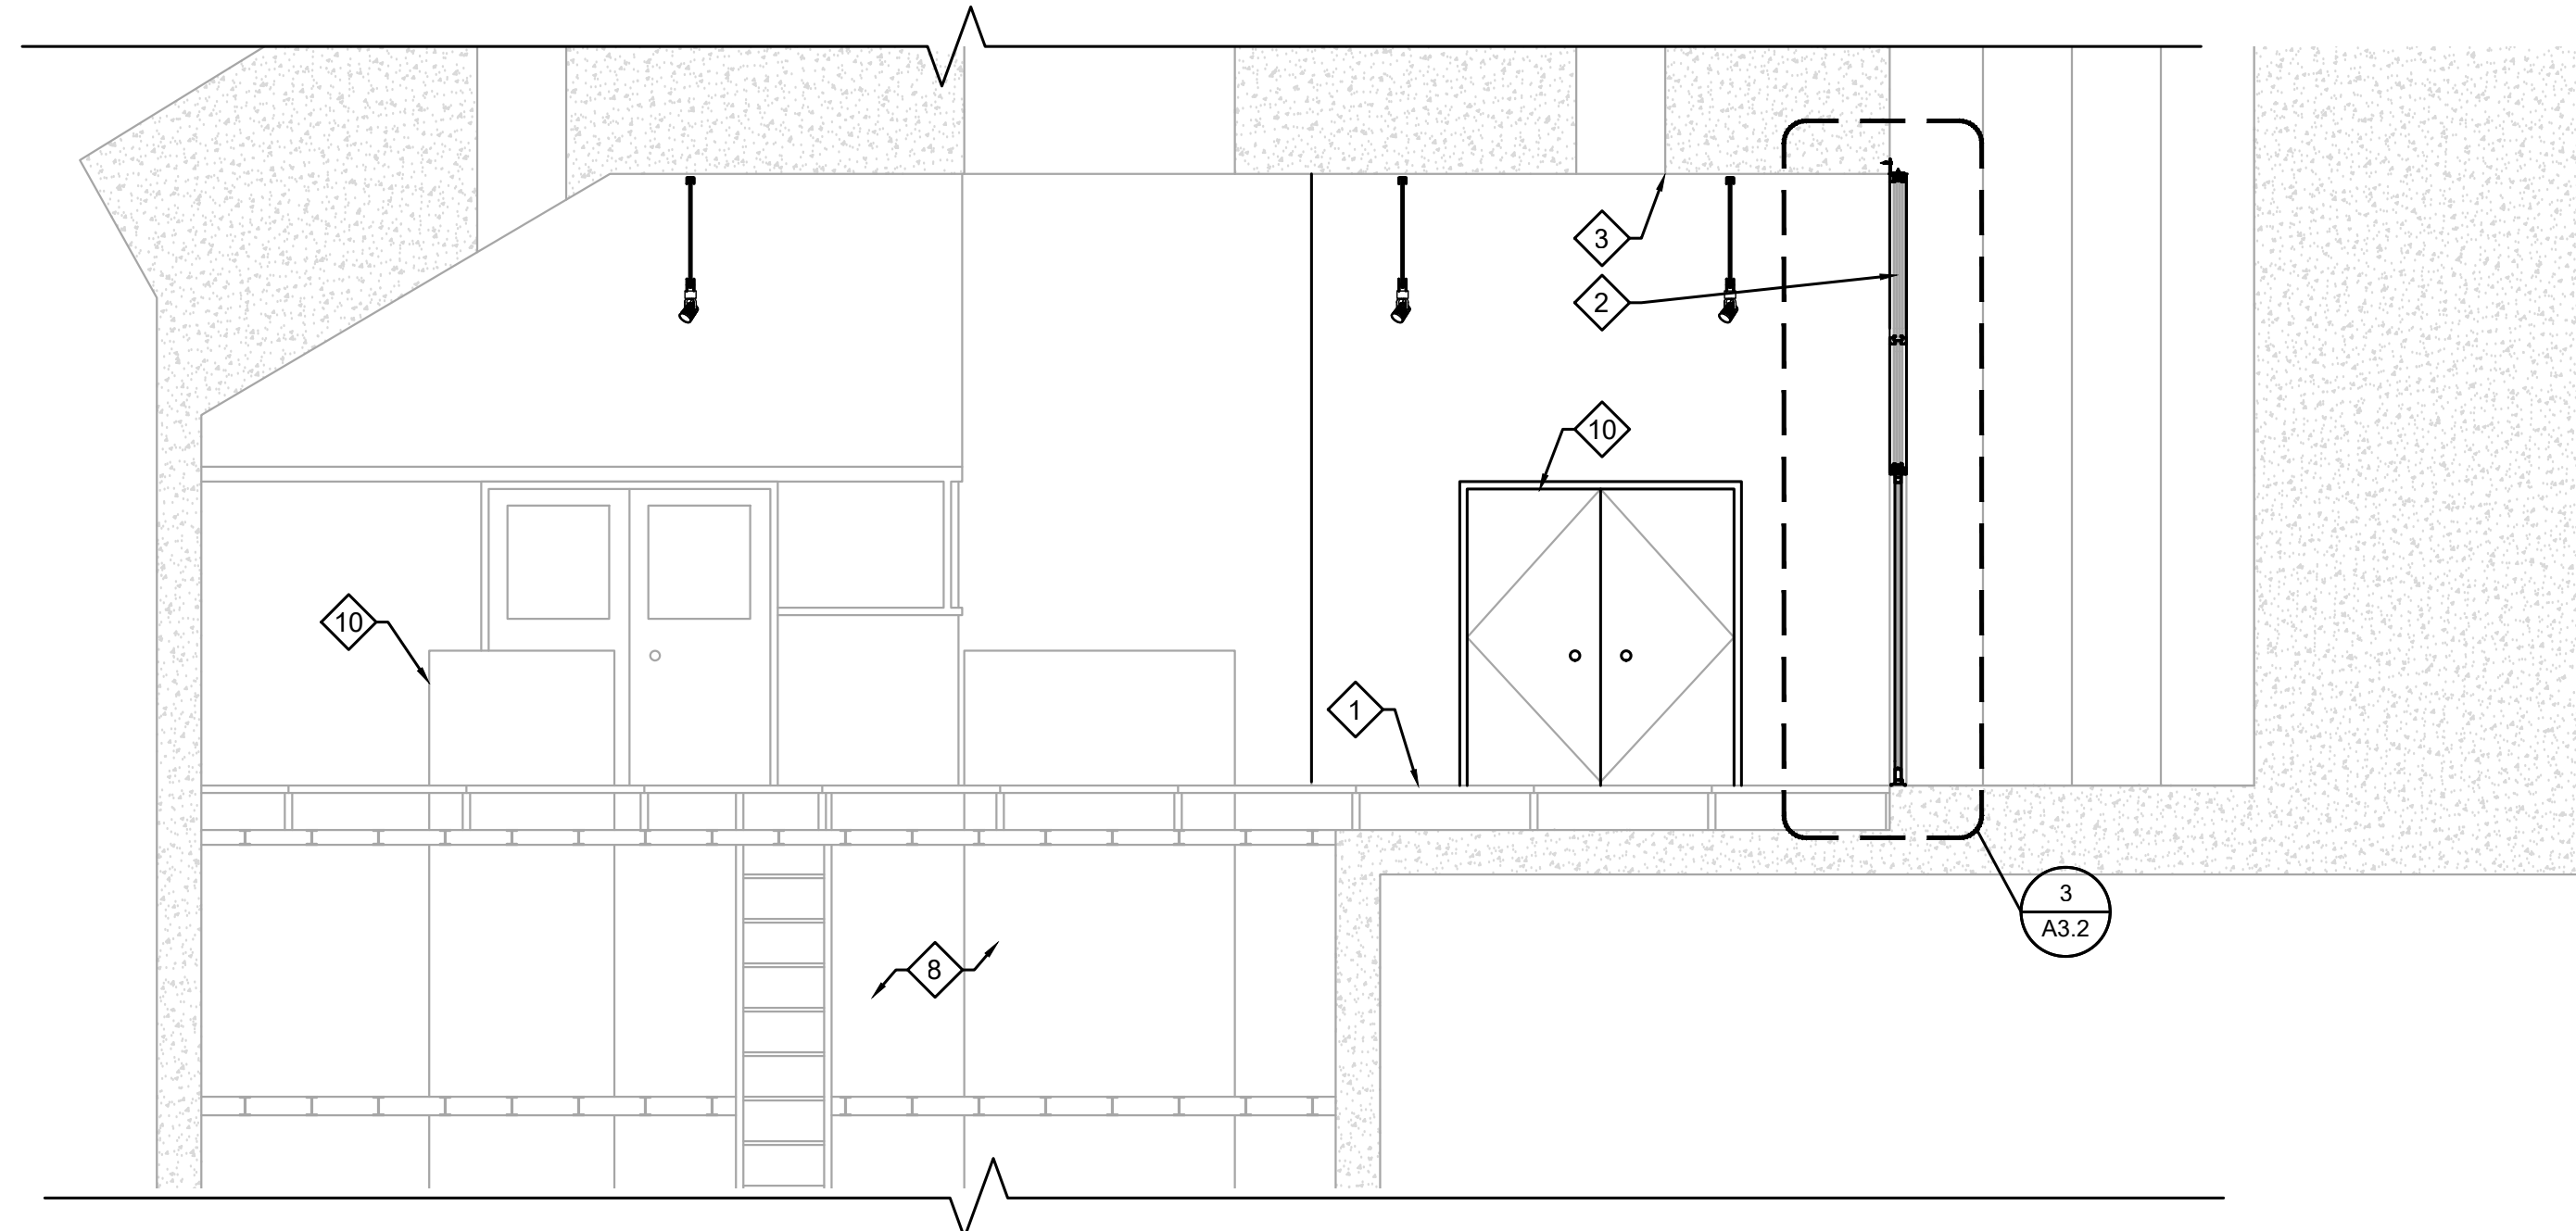
RENOVATION GENERAL NOTES:

- A. REFER TO THE ENTIRE SET FOR ADDITIONAL INFORMATION AND REQUIREMENTS.
- B. COORDINATE ALL WORK WITH STRUCTURAL, ELECTRICAL, MECHANICAL DRAWINGS & OTHER DISCIPLINES INVOLVED.
- C. VERIFY ALL FIELD CONDITIONS & DIMENSIONS, NOTIFY ARCHITECT OF ANY DISCREPANCIES PRIOR TO COMMENCEMENT OF WORK.
- D. UNLESS NOTED OTHERWISE, ALL WORK DESCRIBED SHALL BE PERFORMED BY CONTRACTOR. FOR ITEMS REQUIRING OWNER DIRECTION, CONTRACTOR SHALL COORDINATE DIRECTLY WITH OWNER. THIS INCLUDES BUT IS NOT LIMITED TO FURNITURE RELOCATION, EQUIPMENT RELOCATION, I.T. ITEMS, ETC.
- E. DO NOT SCALE DRAWINGS. IF DIMENSIONS ARE NOT PROVIDED, CONTACT ARCHITECT FOR CLARIFICATION.
- F. CONTRACTOR TO PROVIDE DETAILED PHASING, DEBRIS, DUST CONTROL METHODS, ISOLATION, AND ACCESS TO RESTROOMS TO OWNER FOR APPROVAL PRIOR TO INITIATION OF WORK.
- G. MAINTAIN A SAFE AND CLEAN WORK AREA - REMOVE ALL TRASH AND DEBRIS AT THE END OF EACH WORK SHIFT.
- H. PROVIDE PERSONNEL PROTECTION FROM DEBRIS & MATERIAL FALL PER OWNER STANDARDS. INCLUDING BUT NOT LIMITED TO SCAFFOLDING FOR OVERHEAD PROTECTION WITH TOE BOARDS, & VISQUEEN DUST BARRIER. CONTRACTOR TO AVOID MOVING MATERIALS OR TOOLS THROUGH OPERATING AREAS.
- I. CONTRACTOR TO VERIFY AND COORDINATE WITH OWNER BEFORE DISCONNECTING OR SHUTTING OFF ANY UTILITIES DURING CONSTRUCTION.
- K. COORDINATE ALL DISMANTLING, REMOVALS, STAGING, AND OTHER WORK WITH OWNER PRIOR TO INITIATION OF WORK.
- L. PROVIDE TEMPORARY INDEPENDENT SUPPORT FOR SYSTEMS AND EQUIPMENT SERVING OPERATIONAL AREAS, INCLUDING BUT NOT LIMITED TO: FIRE PROTECTION, LIGHTING, PIPING, CONDUITS, ETC.
- M. ALL INTERIOR AND EXTERIOR STRUCTURE IS EXISTING TO REMAIN UNLESS NOTED OTHERWISE.

KEYNOTES:


- 1. NEW FLOORING PER FINISH PLAN ON SHEET A4.1.
- 2. NEW WALL, SEE WALL TYPES ON SHEET A4.2.
- 3. NEW CEILING PER FINISH SCHEDULE ON A4.1.
- 4. NEW BEAM, SEE STRUCTURAL.
- 5. DISPLAY EQUIPMENT BY OWNERS, SHOWN FOR REFERENCE ONLY.
- 6. COORDINATE WITH OWNER AND STRUCTURAL FOR MOUNTING HOOKS AS REQUIRED.
- 7. NEW DUCTWORK, SEE MECHANICAL.
- 8. NO WORK IN THIS AREA.
- 9. NEW RAMP BEYOND, REFER TO RAMP DETAILS AND ELEVATIONS.
- 10. NEW DOOR, SEE DOOR SCHEDULE ON SHEET A4.1.
- 11. NEW LIGHTING, SEE ELECTRICAL.
- 12. NEW 6" STOREFRONT WALL SYSTEM, SEE DOOR FRAMES ON SHEET A4.1.
- 12.1. STORE FRONT HEADER CONDITION
- 12.2. ATTACHED L6X6X1/8" BENT PLATE TO EDGE OF EXISTING CONCRETE WALL.
- 12.3. GLAZING SYSTEM
- 12.4. DOOR HEADER
- 12.5. DOOR, SEE DOOR SCHEDULE
- 12.6. PROVIDE DOOR BOTTOM.
- 12.7. PROVIDE THRESHOLD
- 12.8. 3/8" SIMPSON TIE TITAN HD SCREW WITH 2.5" EMBEDMENT @ 24" O.C.
- 13. EXISTING EQUIPMENT TO BE PROTECTED IN PLACE AND TO REMAIN.
- 14. EXISTING BEAM TO BE PROTECTED IN PLACE.

NOTE:
ALL VIEW PORTS AND EXISTING
CEILING MOUNTED EQUIPMENT TO
BE PROTECTED IN PLACE, TYP.




1 ARCHITECTURAL BUILDING SECTION
1ST. LEVEL

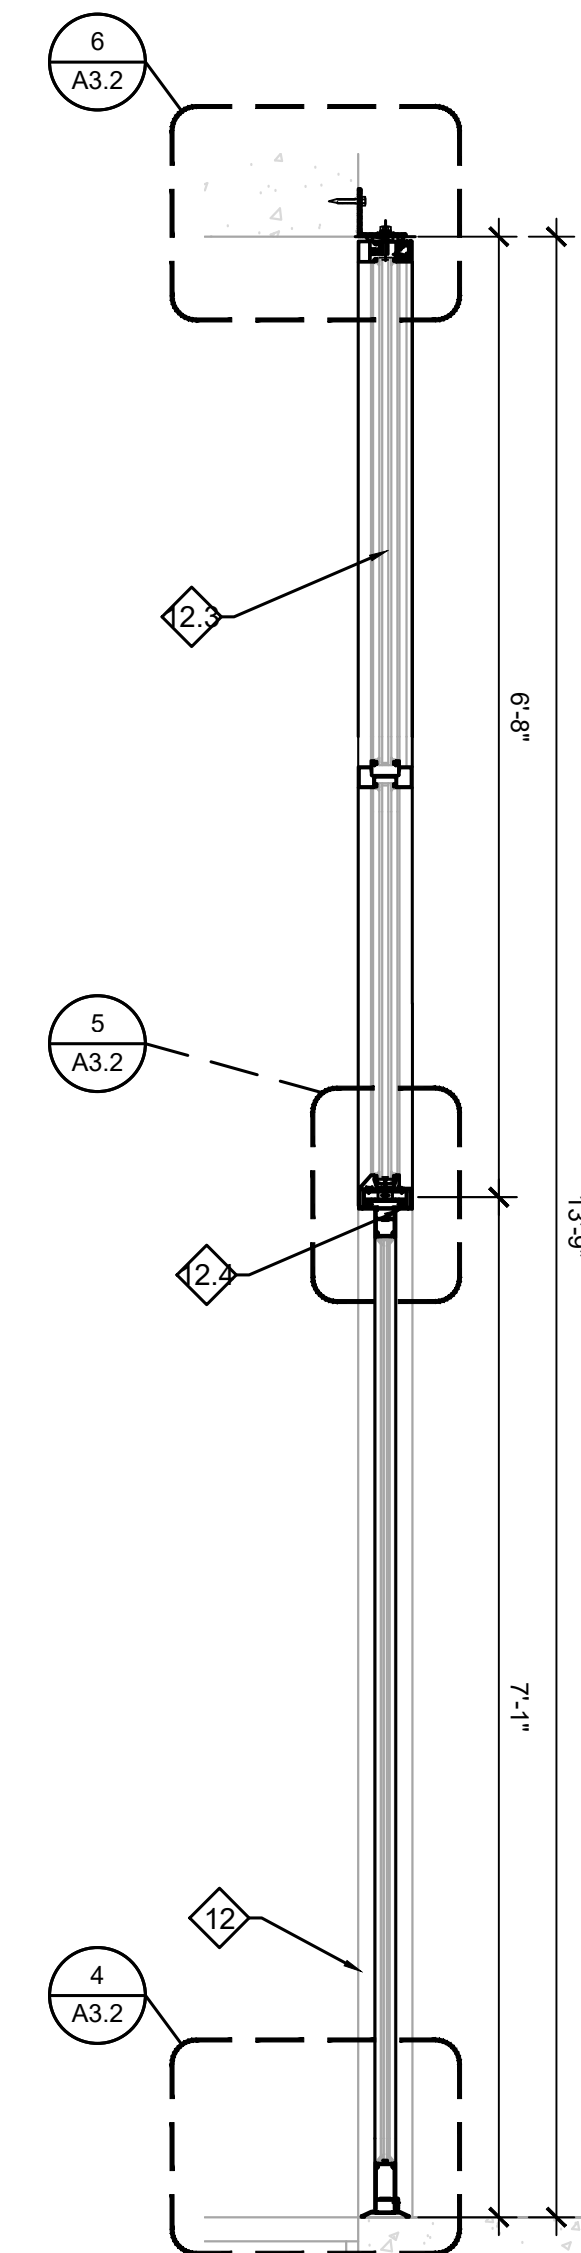SCALE: 1/4" = 1'-0"



3 WALL SECTION
1ST. LEVEL

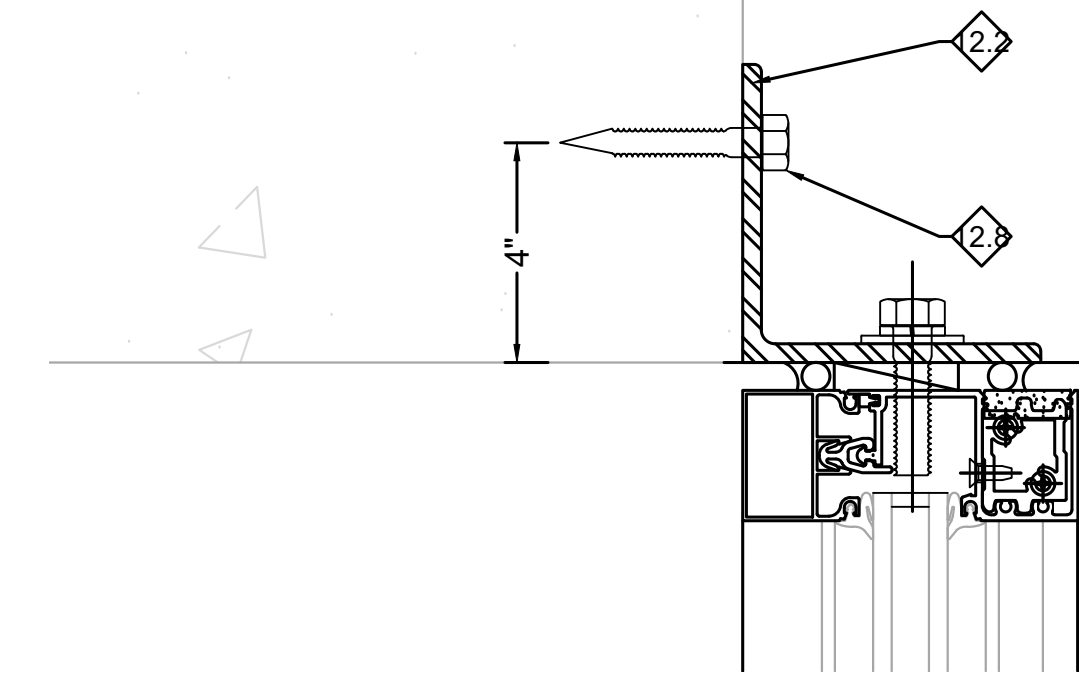SCALE: 3/4" = 1'-0"




6 HEAD DETAIL
1ST. LEVEL

SCALE: 3/4" = 1'-0"


5 DOOR HEAD DETAIL
1ST. LEVEL

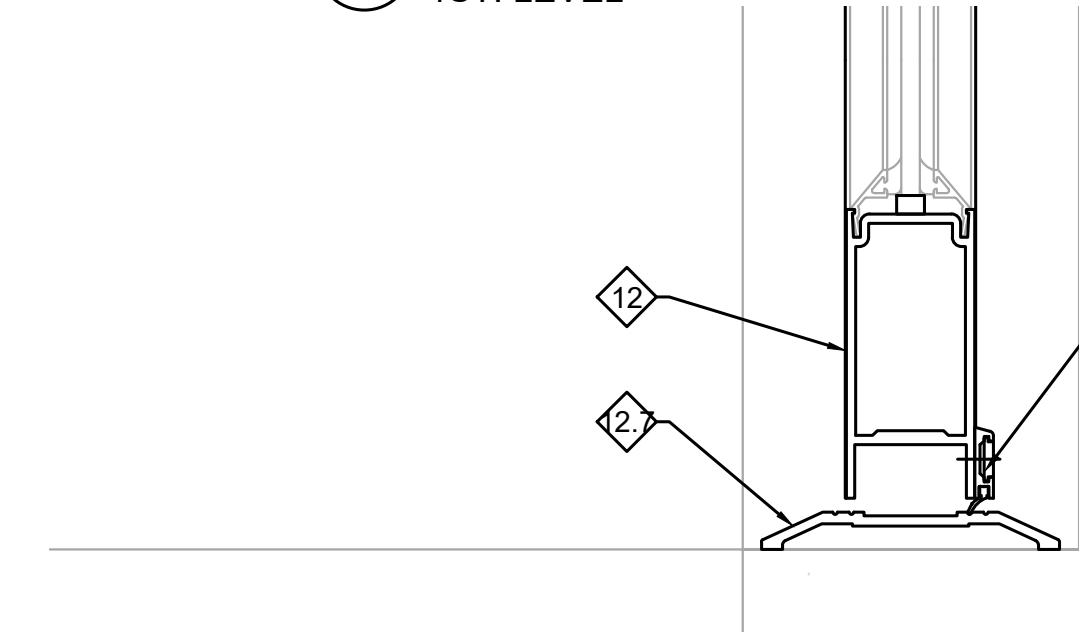SCALE: 3/4" = 1'-0"





4 SILL DETAIL
1ST. LEVEL

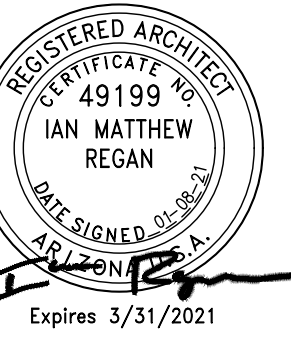SCALE: 3/4" = 1'-0"



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DATE	DESCRIPTION
0 01/08/21	I.F.C.
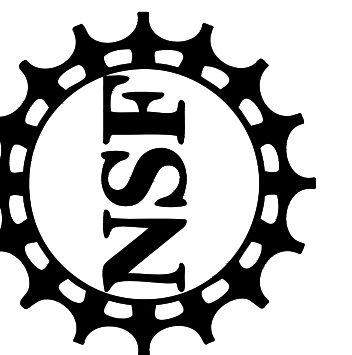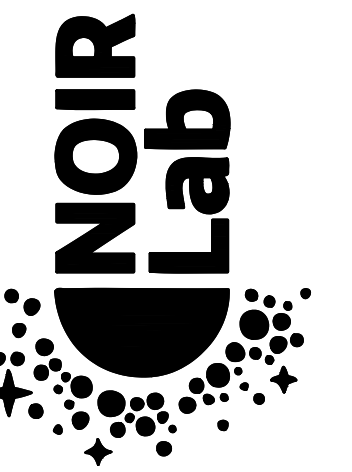
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DRAWN BY: FH
CHECKED BY: IR
CAD FILE: 11904.00-A3.2
SCALE: AS NOTED

BUILDING SECTION

A3.2

DOOR SCHEDULE

DOOR NUMBER	DOOR				FRAME						HWR SET NO.	NOTES
	ROOM	TYPE	SIZE	MAT'L FIN	MAT'L	TYPE	FIN	HEAD	JAMB	DETAILS		
100	FRONT LOBBY	D	(2) 3'-0" 7'-0"	HM PAINT	ALUM	2	DK BRZ ANO	5/A4.2	6/A4.2	---	2	1, 2, 3, 6
101	PLANETARIUM	B	(2) 3'-0" 7'-0"	SCWD STAIN	HM	1	PAIN	5/A4.2	6/A4.2	---	3	1, 3, 6
102	JAN. CLOSET (WEST)	B	3'-0" 7'-0"	SCWD STAIN	HM	1	PAIN	4/A4.2	5/A4.2	---	5	3
103	WOMEN RESTROOM (WEST)	B	3'-0" 7'-0"	SCWD STAIN	HM	1	PAIN	4/A4.2	5/A4.2	---	5	3
104	MEN RESTROOM (WEST)	B	3'-0" 7'-0"	SCWD STAIN	HM	1	PAIN	4/A4.2	5/A4.2	---	5	3
105	STORAGE CLOSET	-	-	-	-	-	-	-	-	-	-	3
107A	EXHIBIT SPACE CORR.	B	(2) 3'-0" 7'-0"	SCWD STAIN	HM	1	PAIN	4/A4.2	5/A4.2	---	3	3, 6
107B	CONTROL ROOM	A	(2) 3'-0" 7'-0"	SCWD STAIN	HM	1	PAIN	4/A4.2	5/A4.2	---	3	3, 6
109	ELEVATOR LIFT	E	3'-0" 7'-0"	ALUM	DK ANO	ALUM	2	DR BRZ ANO	2/A4.2	---	5	3, 4, 5
110	COMPUTER RM	-	-	-	-	-	-	-	-	-	-	3
111	CIRCUITRY RM	-	-	-	-	-	-	-	-	-	-	3, 7
112	UNISEX RESTROOM	C	3'-0" 7'-0"	SCWD STAIN	HM	1	PAIN	1/A4.2	2/A4.2	---	5	3, 7
113	JAN. CLOSET (EAST)	C	3'-0" 7'-0"	SCWD STAIN	HM	1	PAIN	5/A4.2	6/A4.2	---	5	3, 7
114	UNISEX RESTROOM	C	3'-0" 7'-0"	SCWD STAIN	HM	1	PAIN	1/A4.2	2/A4.2	---	5	3, 7
115	STORAGE CLOSET	-	-	-	-	-	-	-	-	-	-	3
116	UTILITY ROOM	-	-	-	-	-	-	-	-	-	-	3
117	ASTRONOMY CLASS RM	A	3'-0" 7'-0"	SCWD STAIN	HM	1	PAIN	1/A4.2	2/A4.2	---	1	1, 3
118	NSF ASTRONOMY EXHIBIT	A	(2) 3'-0" 7'-0"	SCWD STAIN	HM	1	PAIN	3/A4.2	2/A4.2	---	3	1, 3, 6
119A	SCI ON SPHERE	B	(2) 3'-0" 7'-0"	SCWD STAIN	HM	1	PAIN	1/A4.2	2/A4.2	---	3	1, 3, 6
119B	SCI ON SPHERE	D	(2) 3'-0" 7'-0"	HM PAINT	HM	1	PAIN	9/A4.2	9/A4.2 SIM	---	2	1, 2, 3, 6
120	STAFF OFFICE	-	-	-	-	-	-	-	-	-	-	3
121	CONCRETE TUNNEL	B	3'-0" 6'-8"	SCWD PAINT	HM	1	PAIN	4/A4.2	5/A4.2 SIM	---	5	3

DOOR HARDWARE

SET 1-CLASSROOMS
 1-1/2 PR HINGES
 1 SET OF SILENCERS
 1 SET DOOR SEALS
 WALL BUMPER
 FOOT HOLD OPEN
 1 HEAVY DUTY CLOSER
 1 CLASSROOM LOCKSET

SET 4-OFFICE
 1-1/2 PR HINGES
 1 SET OF SILENCERS
 1 SET DOOR SEALS
 WALL BUMPER
 1 OFFICE LOCKSET

SET 2-ENTRY:
 1-1/2 PR HINGES
 1 SET OF SILENCERS
 1 SET DOOR SEALS
 1 THRESHOLD - ADA COMPLIANT WHEN NEEDED
 1 HEAVY DUTY CLOSER
 1 HEAVY DUTY PANIC BAR
 1 ENTRANCE LOCKSET

SET 5-STORAGE
 1-1/2 PR HINGES
 1 SET OF SILENCERS
 1 SET DOOR SEALS
 WALL BUMPER
 1 STORAGE LOCKSET
 FOOT HOLD OPEN
 KICK PLATE

SET 3-MULTI PURPOSE
 1-1/2 PR HINGES PER DOOR
 2 SET OF SILENCERS
 2 SET DOOR SEALS
 2 WALL BUMBERS
 2 FOOT HOLD OPEN
 2 HEAVY DUTY PANIC BAR
 2 HEAVY DUTY CLOSER
 1 CLASSROOM LOCKSET
 VERTICAL ROD

ABBREVIATIONS:

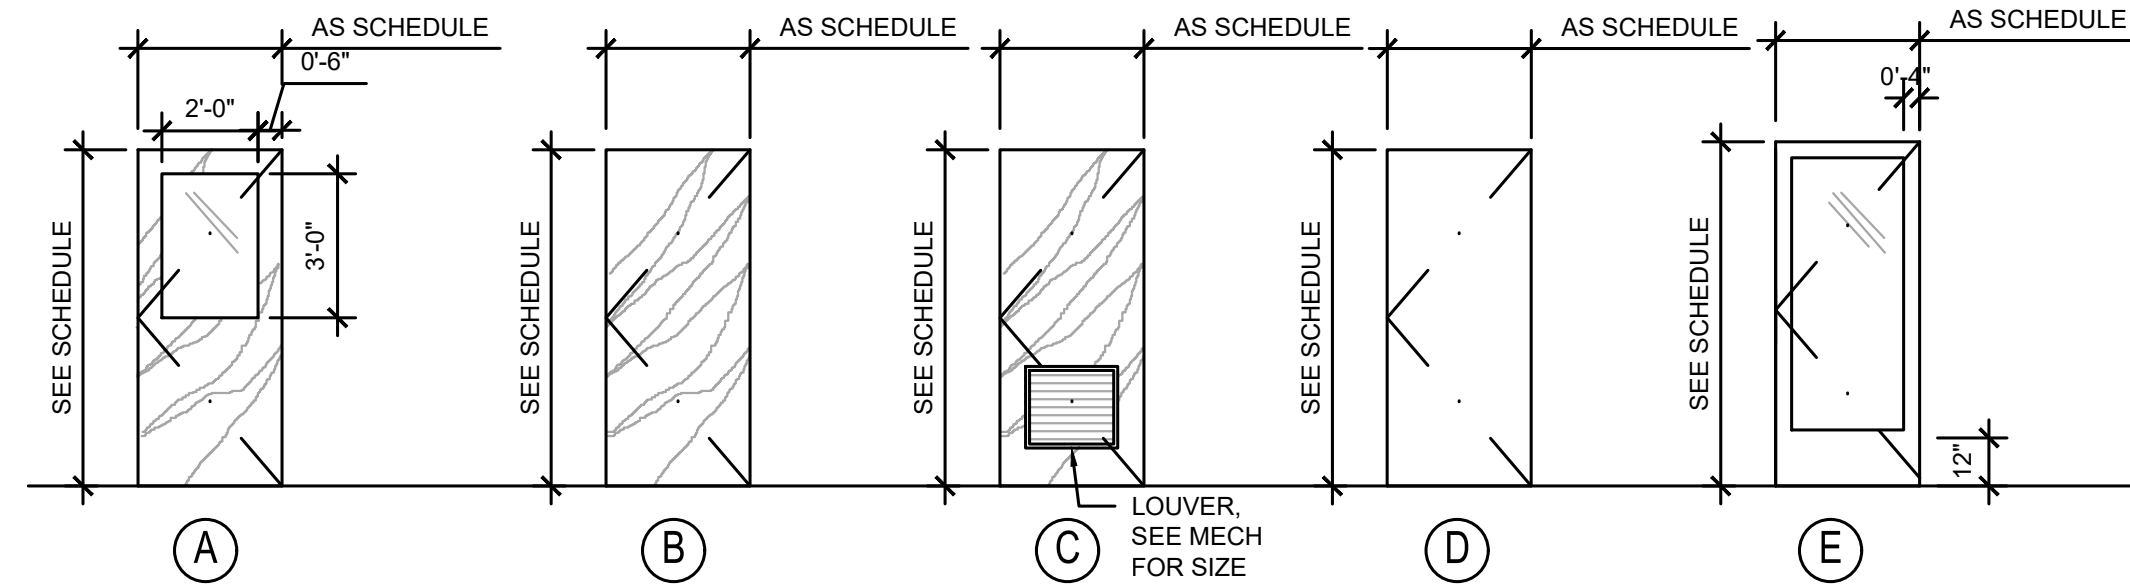
(E) EXISTING
 SCWD SOLID CORE WOOD
 MTL METAL
 HM HOLLOW METAL
 V VARNISH
 P PAINTED
 T TEMPERED GLASS

DOOR SCHEDULES GENERAL NOTES


- CONTRACTOR TO SURVEY AND FIELD VERIFY EXISTING OPENINGS, SIZES, CONDITIONS AND COORDINATE WITH NEW CONSTRUCTION EXISTING WOOD DOORS - CONTRACTOR TO PATCH/REPAIR, READJUST DOOR AND HARDWARE AND SAND/TOUCH-UP FINISH TO RENDER DOOR TO NEW CONDITION TO GREATEST EXTENT POSSIBLE
- REMOVE ALL HARDWARE, FASTENERS AND ACCESSORIES PRIOR TO PAINTING/REFINISHING. REINSTALL
- VERIFY EXISTING OPENING DIMENSIONS MODIFY FRAME/ DOOR DETAILS/ DIMENSIONS TO FIT EXISTING OPENING. SURVEY EXISTING DOOR/ FRAME AND STRIKE FOR NEW HDWR AS REQUIRED.
- REWORK EXISTING DOOR/ FRAME FOR INSTALLATION. PROVIDE BACKING AND SUPPORTS AS REQUIRED FOR NEW HDWR. PAINT EXISTING DOOR AND FRAME, TYPICAL.
- CONTRACTOR TO CLEAN AND ADJUST EXISTING DOOR/ HDWR
- CONTRACTOR TO COORDINATE NEW DOOR/ FRAME/ ANCHORS WITH (E) TRAILER WALL CONSTRUCTION. PROVIDE ADDITIONAL FRAMING/ SUPPORTS FOR FRAME AND AUTO OPERATOR. COORDINATE INSTALL WITH ELECTRICAL CONNECTION.

DOOR NOTES:

- OVER SIZED THROAT, 6" WALL
- DH FIRE RATED GLASS, FIRELIGHT NT FILM
- PROVIDE ELECTRIC STRIKE. COORDINATE W/ ELECTRICAL
- LOCKLABEL PER MANF. -CHANGABLE CORES IN DK BRONZE
- DESIGN BASED ON MILGARD, ALUM SERIES, CLEAR GLASS, SEE PALO VERDE GLASS-855-6010
- ATTENTION DEBBIE
- FRAME TO BE GROUTED SOLID
- ALL HARDWARE TO BE DARK BRONZE
- CARD READER BY OTHERS
- ASTRIGAL
- HEAVY DUTY PANIC BAR
- NO KICK PLATES
- UNDERCUT DOOR. SEE M1.3 (DOORS 111-14)



2 DOOR TYPES

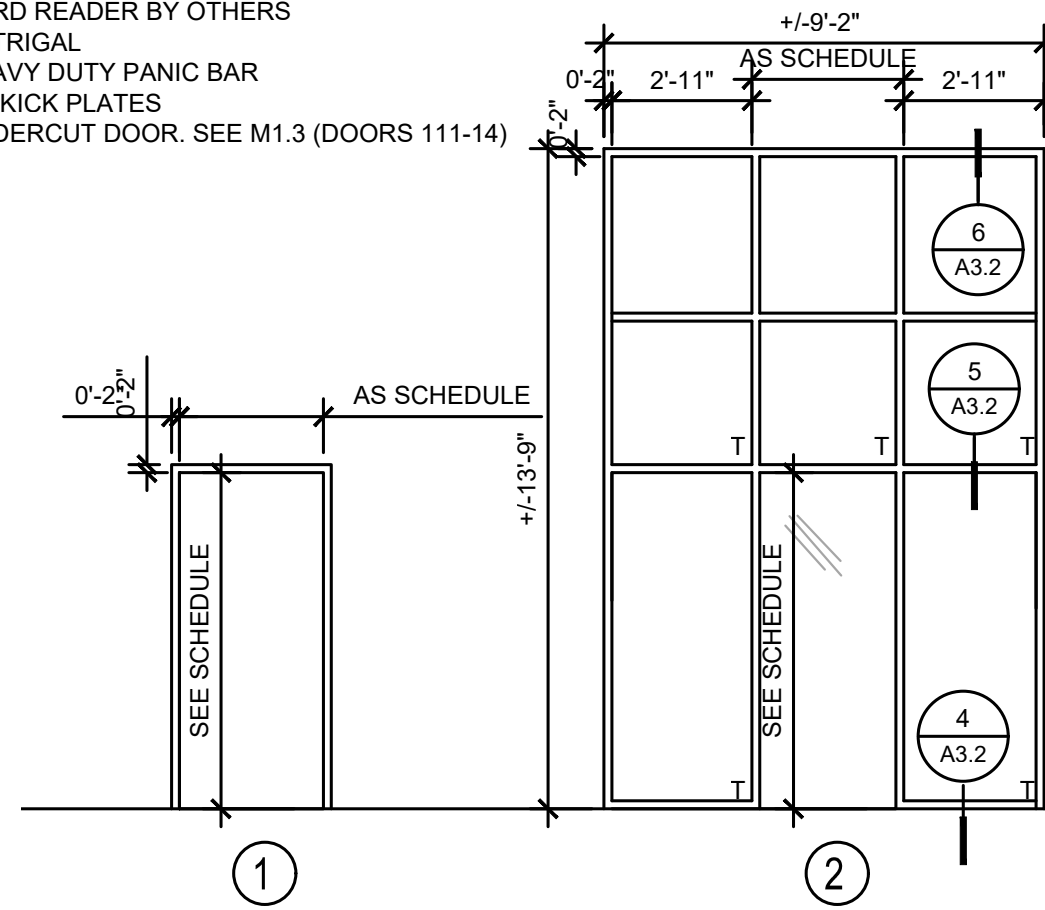

3 FRAME TYPES

ROOM FINISH GENERAL NOTES:


- REFER TO FINISH PLAN BELOW FOR ALL FLOOR AND WALL FINISHES.
- ALL CEILINGS IN PROJECT ARE TO BE EXPOSED. PREP AS REQUIRED FOR PAINT AS INDICATED BELOW.
- PROTECT ALL CEILING HUNG EQUIPMENT FROM OVER SPRAY.

CEILING FINISH SCHEDULE



ROOM NUMBER	ROOM	FINISH
100	FRONT LOBBY	PNT-3
101	PLANETARIUM	PNT-4
102	JANITOR'S CLOSET (WEST)	PNT-3
103	WOMEN'S RESTROOM (WEST)	PNT-3
104	MEN'S RESTROOM (WEST)	PNT-3
105	STORAGE CLOSET	PNT-3
106	RESTROOM HALLWAY	PNT-3
107	EXHIBIT SPACE CORRIDOR	PNT-4
108	CONTROL ROOM	PNT-3
109	ELEVATOR SHAFT	-
110	COMPUTER ROOM	PNT-3
111	CIRCUITRY ROOM	PNT-3
112	UNISEX RESTROOM	PNT-3
113	JANITOR'S CLOSET EAST	PNT-3
114	UNISEX RESTROOM	PNT-3
115	STORAGE CLOSET	PNT-3
116	UTILITY ROOM	PNT-3
117	ASTRONOMY CLASSROOM	PNT-4
118	NSF ASTRONOMY SHOWCASE EXHIBIT	PNT-4
119	S.O.S. THEATER	PNT-4
120	STAFF OFFICE	PNT-3
121	CONCRETE TUNNEL	-

FINISH SCHEDULE LEGEND


FLOOR	WALL	CEILING
CPT-1 CARPET TILE: TBD	CWT-1 CERAMIC WALL TILE: TBD	PNT-1 PAINT: TBD (ALL WALLS NOT DETERMINED BY OTHER FINISHES ARE TO BE PAINTED TO MATCH CEILING COLOR)
CPT-2 CARPET TILE: TBD	TILE FROM F.F.E. UP TO 5' A.F.F. PAINT THE REST	PNT-2 PAINT: TBD
CT-1 CERAMIC TILE: TBD		PNT-3 WHITE DRYFALL PAINT MANUFACTURE TBD
SC SEALED CONCRETE		PNT-4 BLACK DRYFALL PAINT MANUFACTURE TBD
ETR EXISTING TO REMAIN: EXISTING FLOORING TO BE PROTECTED IN PLACE AND CLEANED		ACOUSITCORD. COLOR AND STYLE TBD BY OWNER.
RBR-1 RUBBER BASE: TBD		
CTB-1 CERAMIC TILE BASE: TBD		

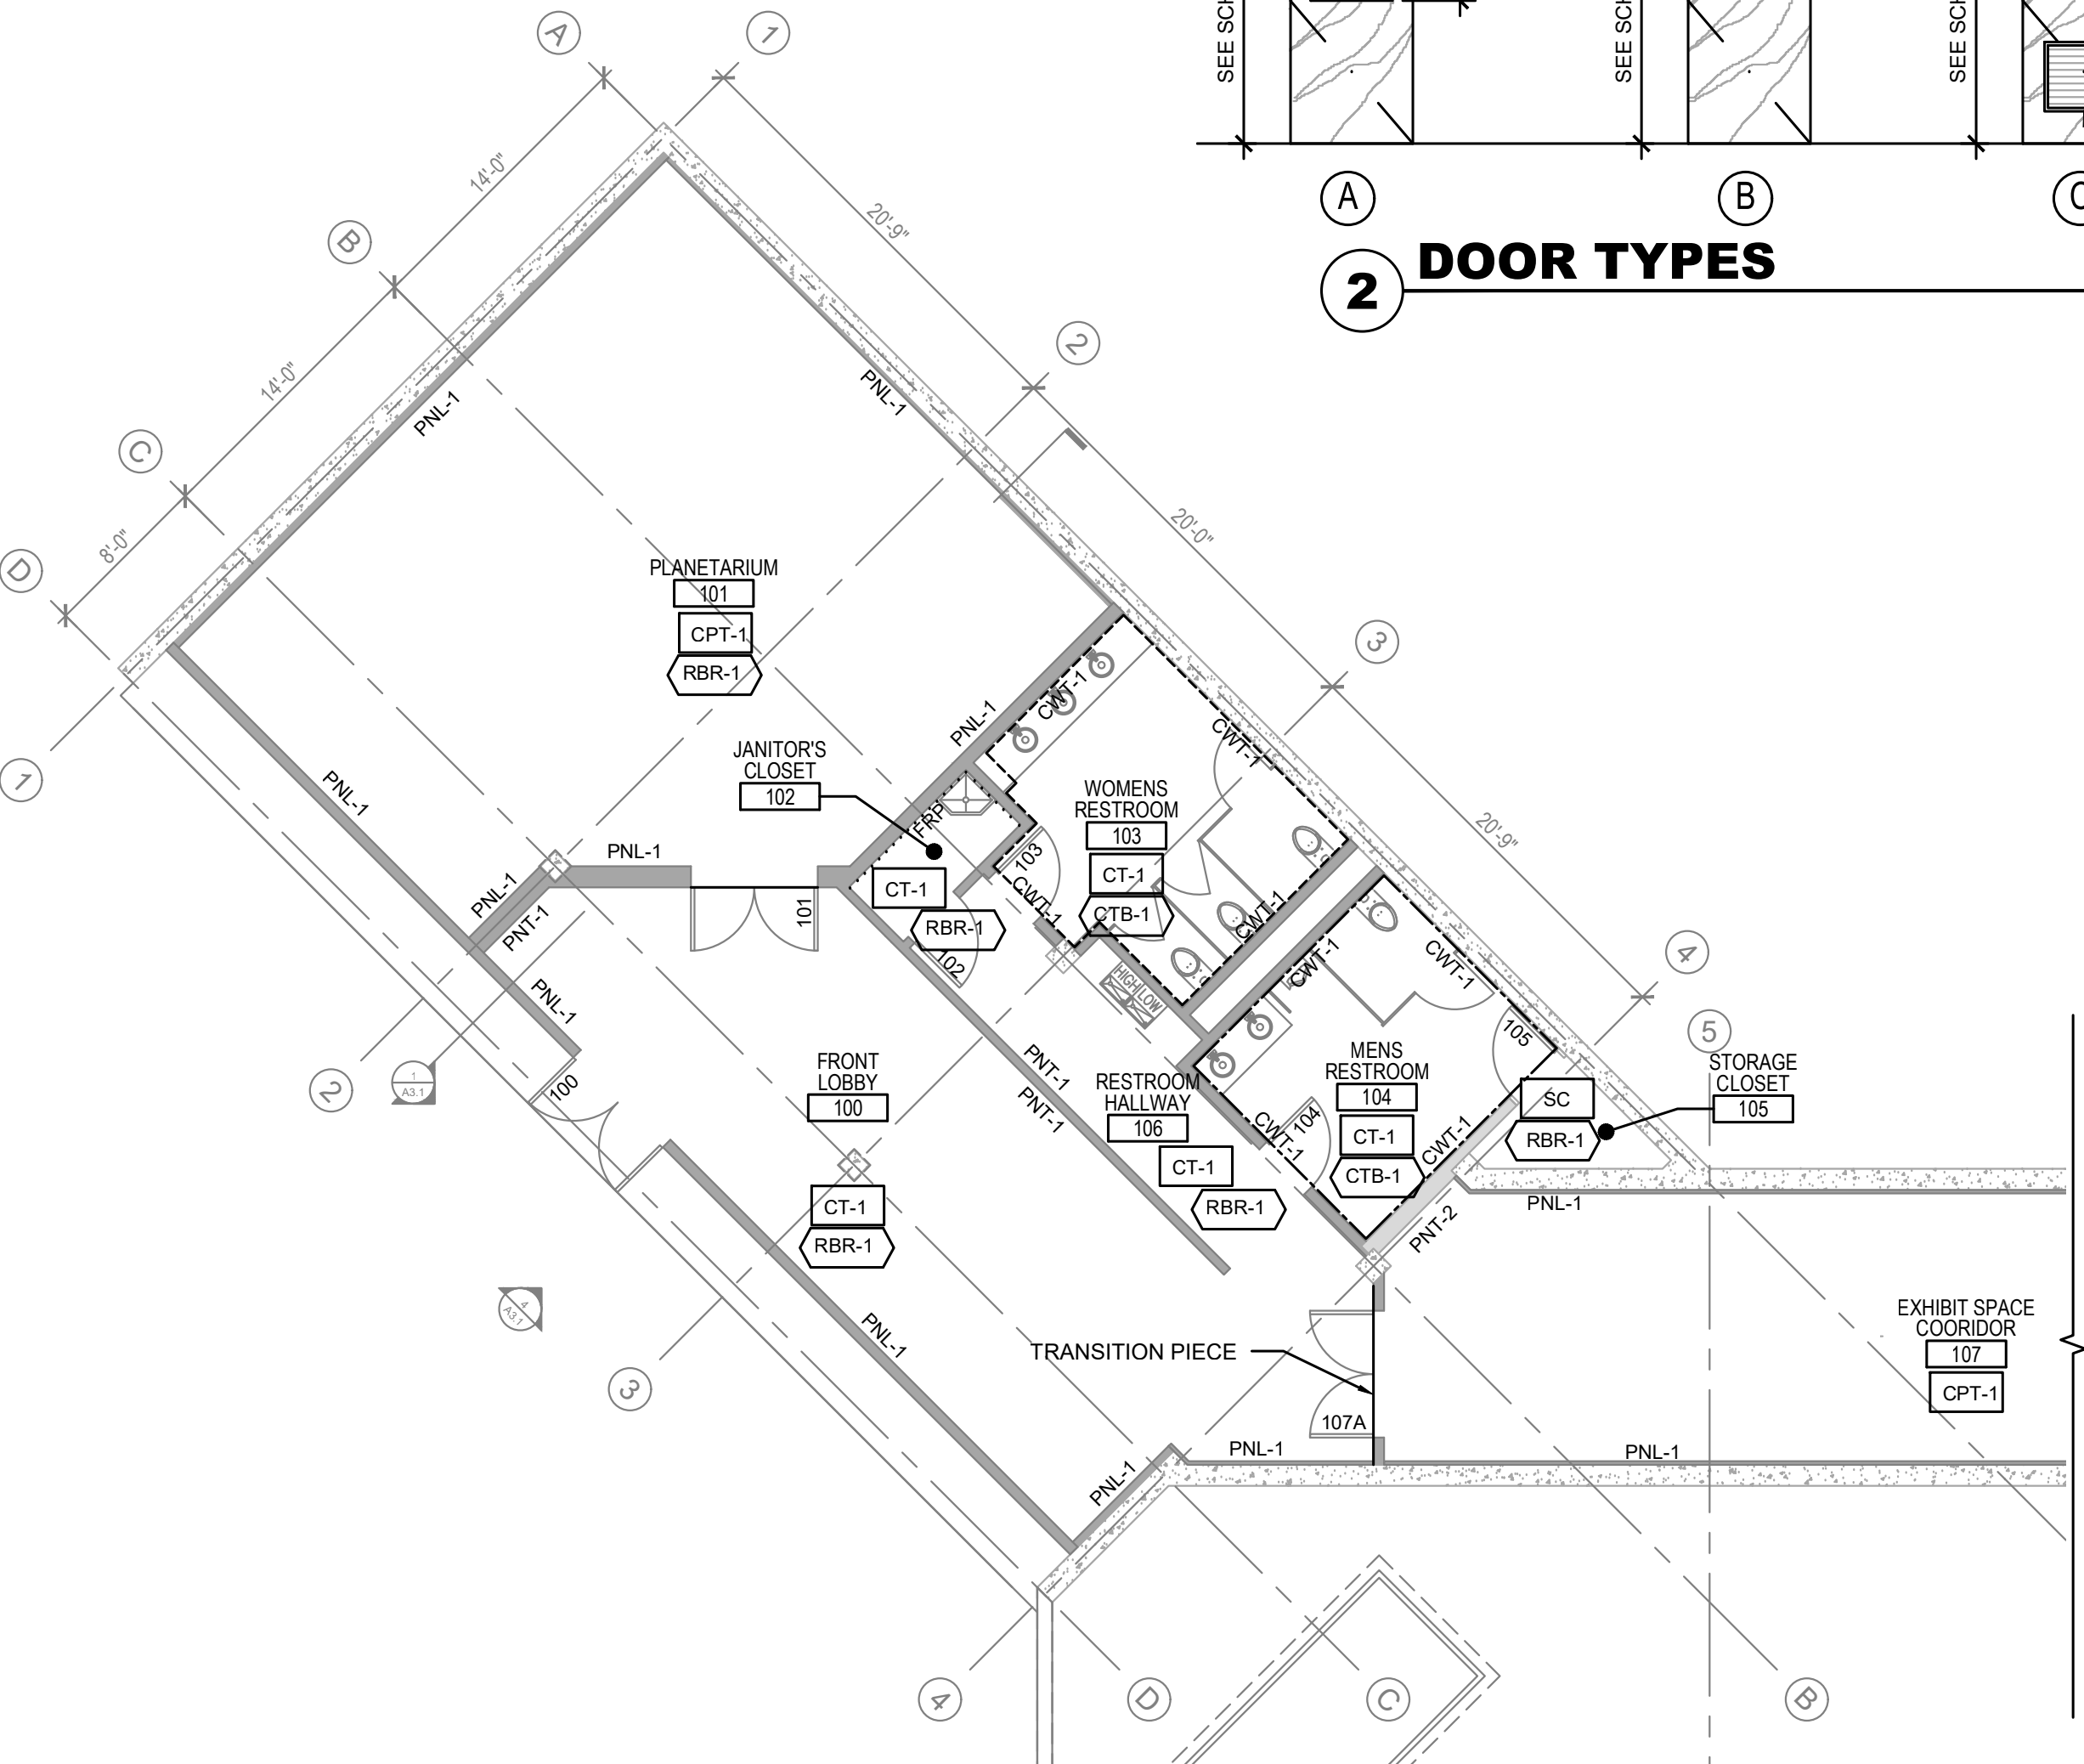

1 FINISH FLOOR PLAN

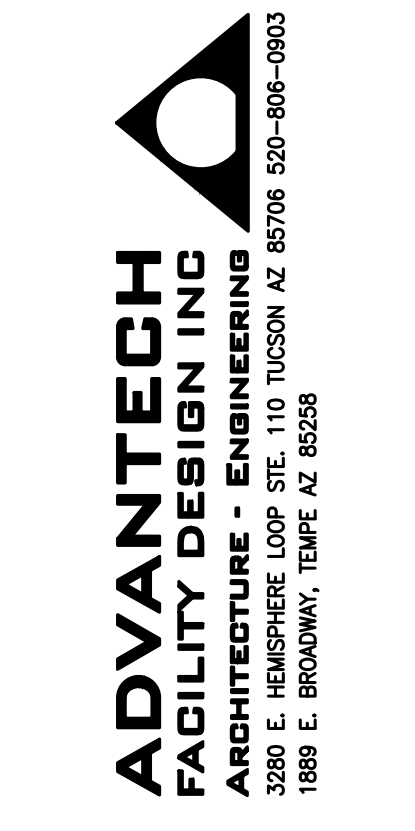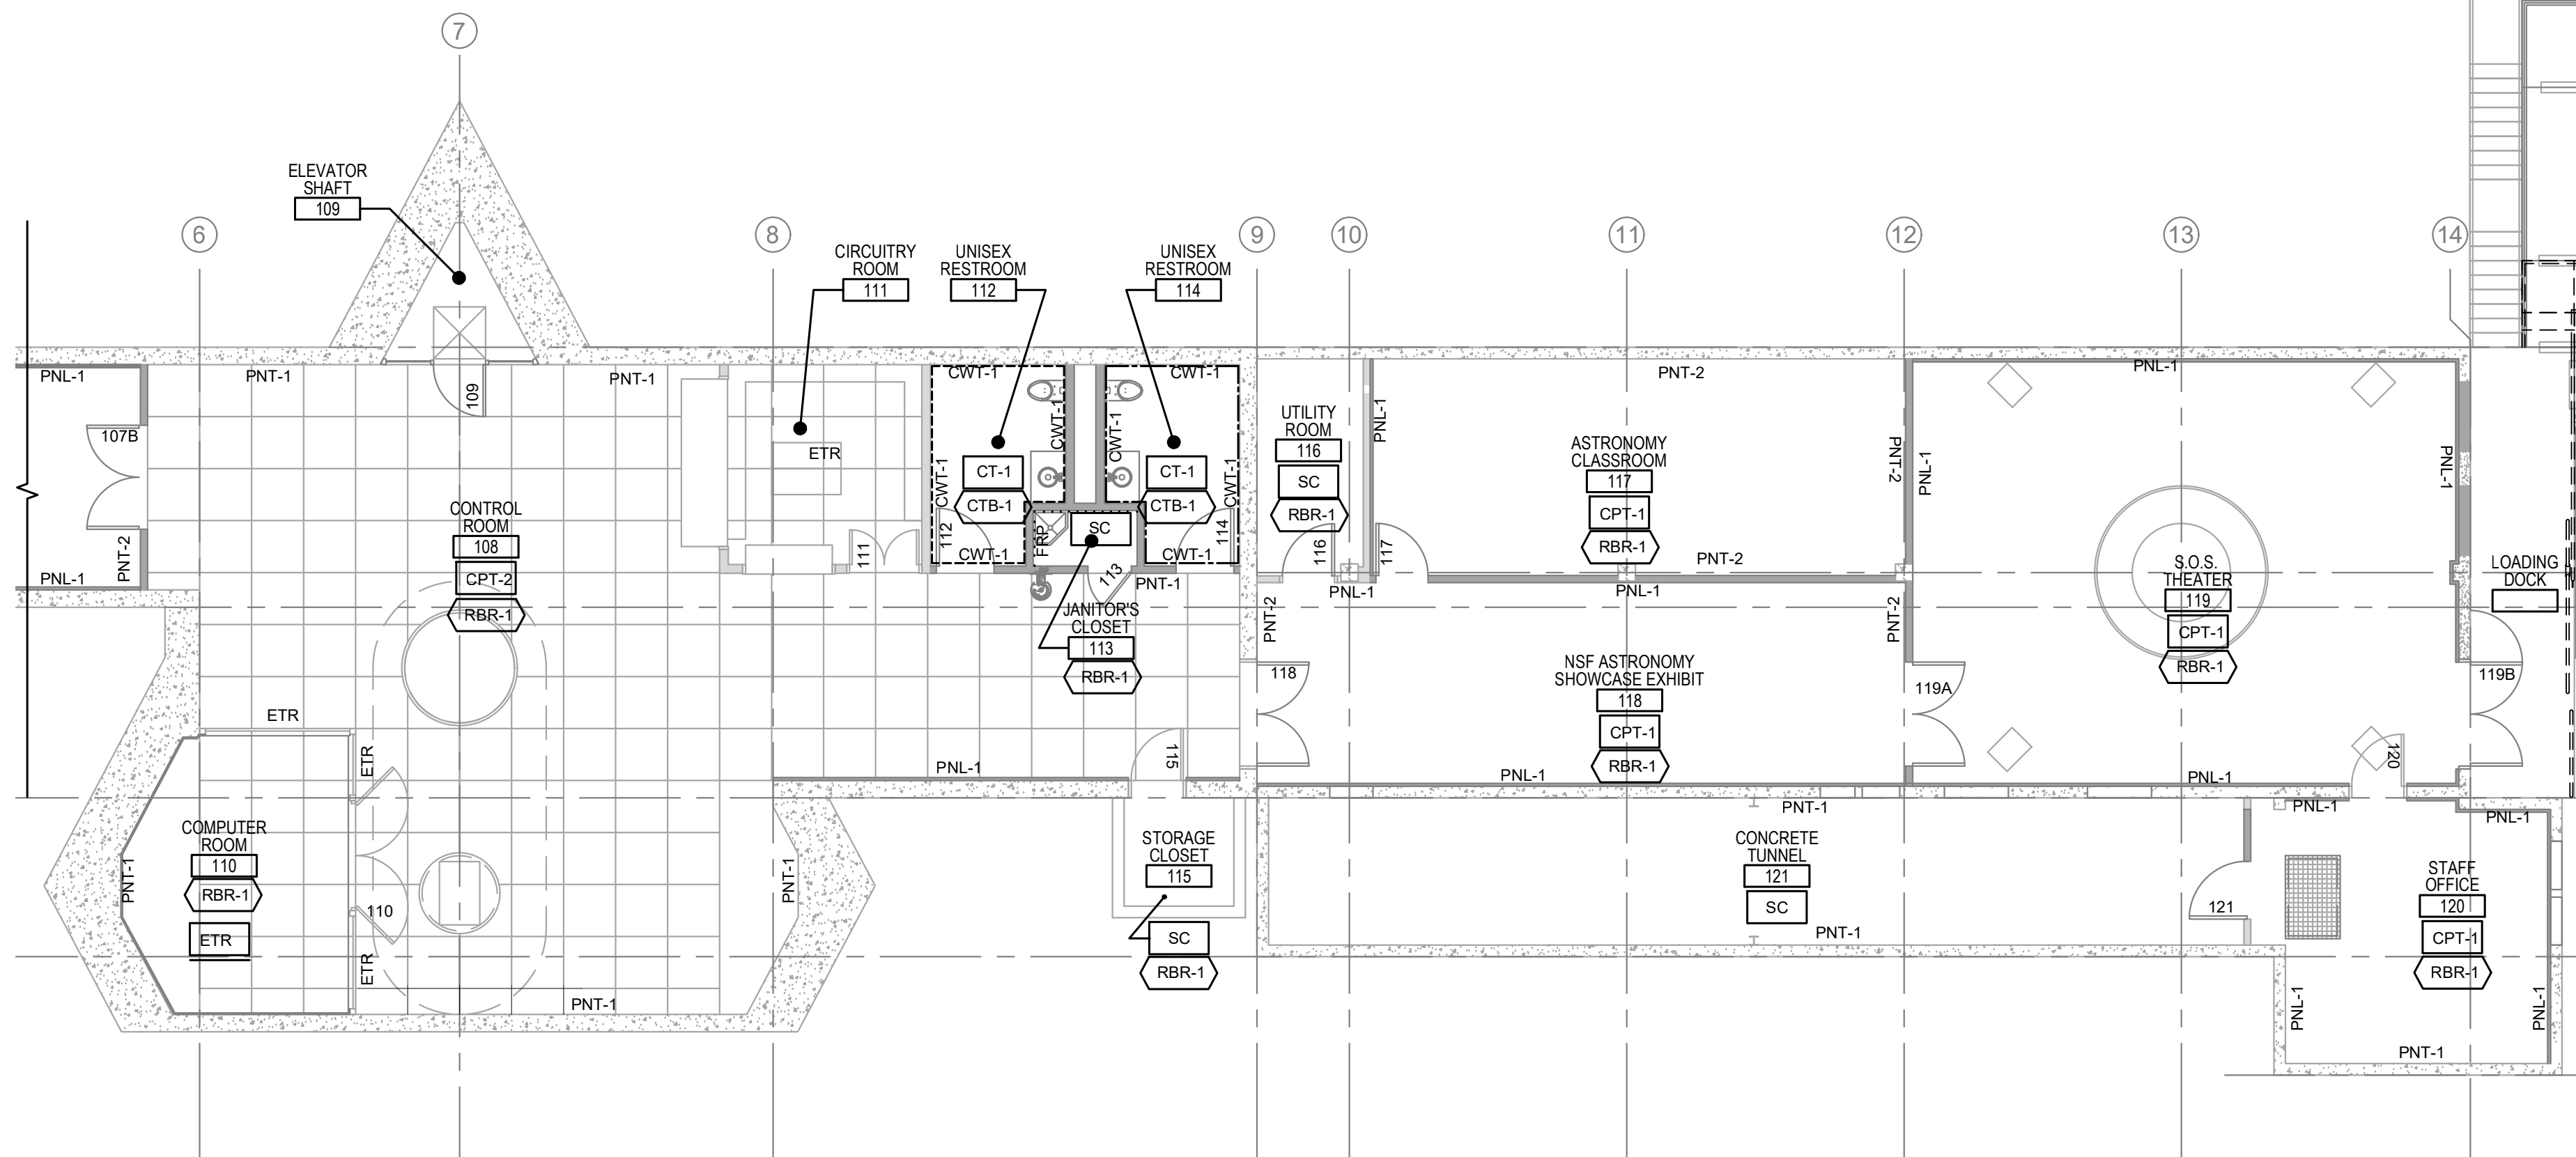
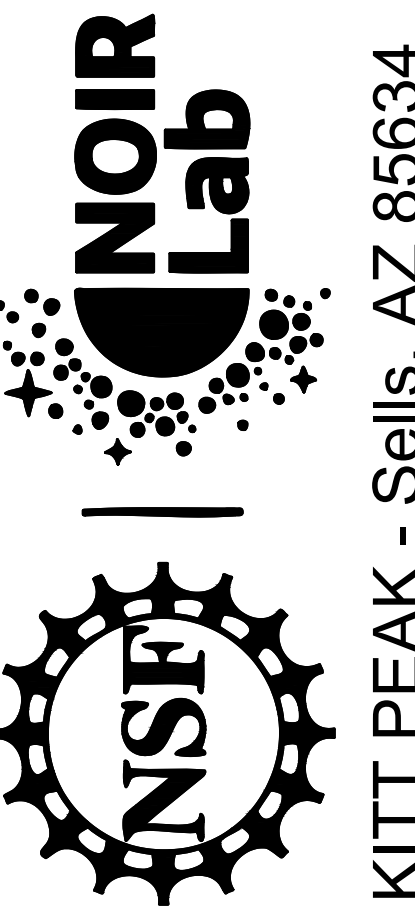
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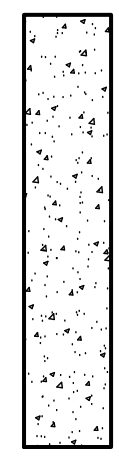
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0 01/08/21	I.F.C.

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ARCHITECTURAL
 SCHEDULES & DETAILS

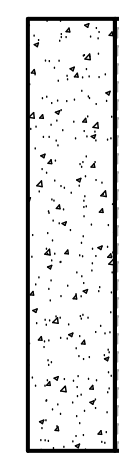
A4.1

KITT PEAK - Sells, AZ 85634




A

EXISTING CONCRETE WALL CLEANED AND PAINTED. FINAL COLOR PER OWNER.




A SIM

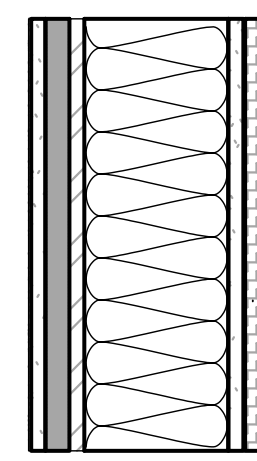EXISTING CONCRETE WALL CLEANED AND PREPARED FOR ACOUSTICAL PANELING. COLOR AND FINISH PER OWNER.




B

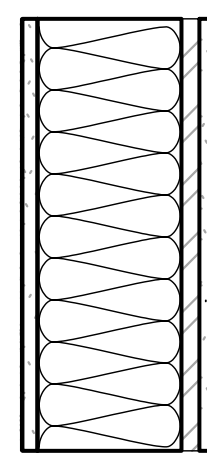NON-RATED STUD WALL: 6" X 20 GAUGE METAL STUDS 16" ON CENTER W/ BATT, EXTERIOR WITH ONE LAYER OF 5/8" DENSELEMENT, 1" THICK EXTRUDED POLYISO INSULATION BOARD BARRIER SYSTEM, 1/2" THICK STUCCO SYSTEM INCLUDING REINFORCING MESH EMBEDDED IN BASE COAT AND FINISHED COAT. INTERIOR 5/8" TYPE 'X' GWB, 1 LAYER ACOUSTICAL PANELING. WALL UP TO CEILING HEIGHT, COLOR AND FINISH PER OWNER.




C

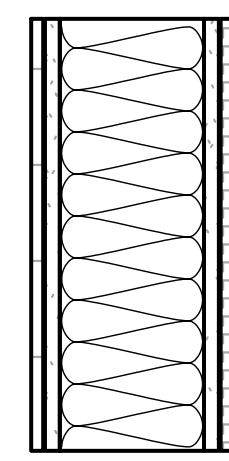NON-RATED STUD WALL: 6" X 20 GAUGE METAL STUDS 16" ON CENTER W/ BATT, WITH ONE LAYER OF 5/8" TYPE 'X' GWB ON ONE SIDE AND OTHER SIDE W/ 5/8" TYPE 'X' GWB, 1 LAYER ACOUSTICAL PANELING. WALL UP TO CEILING HEIGHT, COLOR AND FINISH PER OWNER.




C SIM

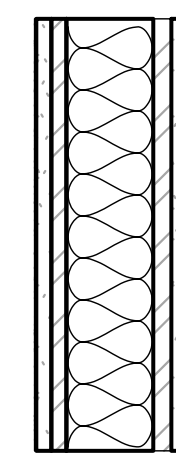NON-RATED STUD WALL: 6" X 20 GAUGE METAL STUDS 16" ON CENTER W/ BATT, WITH TILE OVER ONE LAYER OF 5/8" TYPE 'X' GWB ON ONE SIDE AND OTHER SIDE W/ 5/8" TYPE 'X' GWB, 1 LAYER ACOUSTICAL PANELING. WALL UP TO CEILING HEIGHT, COLOR AND FINISH PER OWNER.




D

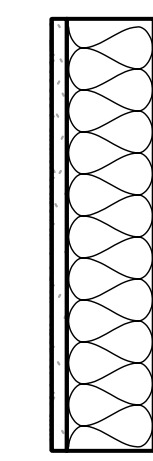NON-RATED STUD WALL: 3-5/8" X 20 GAUGE METAL STUDS 16" ON CENTER W/ BATT, ONE LAYER OF 5/8" TYPE 'X' GWB OVER ONE LAYER 3/4" PLY ON BOTH SIDES. WALL UP TO CEILING HEIGHT, COLOR AND FINISH PER OWNER.




E

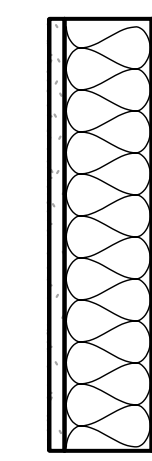NON-RATED STUD WALL: 3-5/8" X 20 GAUGE METAL STUDS 16" ON CENTER W/ BATT, ONE LAYER OF 5/8" TYPE 'X' GWB ON BOTH SIDES. WALL UP TO CEILING HEIGHT, COLOR AND FINISH PER OWNER.




E SIM

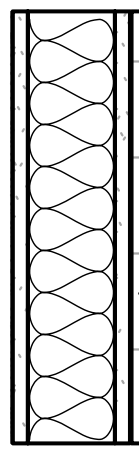NON-RATED STUD WALL: 6" METAL STUDS 16" ON CENTER W/ BATT, ONE LAYER OF 5/8" TYPE 'X' GWB ON ONE SIDE AND OTHER SIDE W/ 5/8" TYPE 'X' GWB, 1 LAYER ACOUSTICAL PANELING. WALL UP TO CEILING HEIGHT, COLOR AND FINISH PER OWNER.




E SIM 2

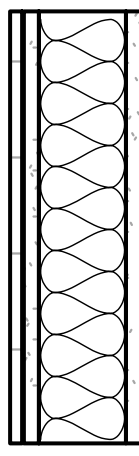NON-RATED STUD WALL: 3-5/8" X 20 GAUGE METAL STUDS 16" ON CENTER W/ BATT, ONE LAYER OF 5/8" TYPE 'X' GWB ON ONE SIDE AND OTHER SIDE W/ 5/8" TYPE 'X' GWB, 1 LAYER TILE. WALL UP TO CEILING HEIGHT, COLOR AND FINISH PER OWNER.




E SIM 3

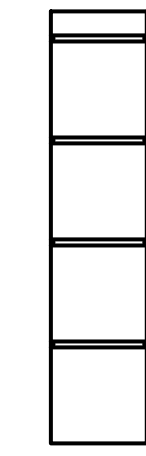NON-RATED STUD WALL: 3-5/8" X 20 GAUGE METAL STUDS 16" ON CENTER W/ BATT, WITH TILE ON TOP OF ONE LAYER OF 5/8" TYPE 'X' GWB ON BOTH SIDES. WALL UP TO CEILING HEIGHT, COLOR AND FINISH PER OWNER.




F

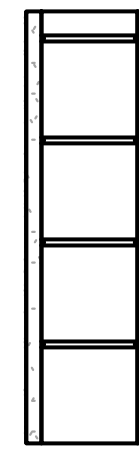EXISTING CMU WALL CLEANED AND PREPARED FOR TILE. FINAL COLOR AND FINISH PER OWNER.



F SIM

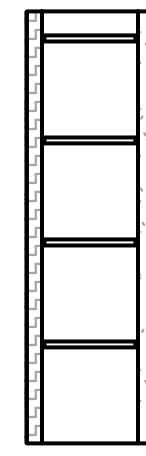
EXISTING CMU WALL CLEANED AND PREPARED FOR TILE ON ONE SIDE, ONE LAYER 5/8" W.R. TYPE 'X' GWB ON THE OTHER SIDE. FINAL COLOR AND FINISH PER OWNER.



F SIM 2



EXISTING CMU WALL CLEANED AND PREPARED FOR ACOUSTICAL PANELING ON ONE SIDE, AND TWO LAYERS 5/8" W.R. TYPE 'X' GWB ON THE OTHER SIDE. FINAL COLOR AND FINISH PER OWNER.

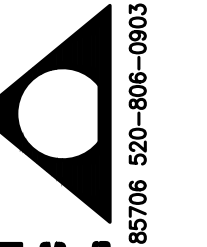WALL TYPES




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WINDOWS ON
THE UNIVERSE
CENTER FOR
ASTRONOMY
OUTREACH

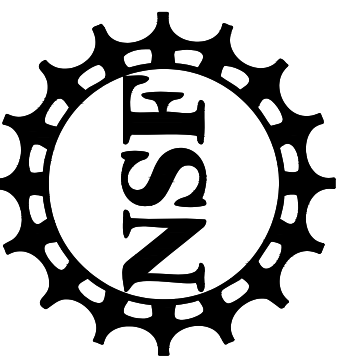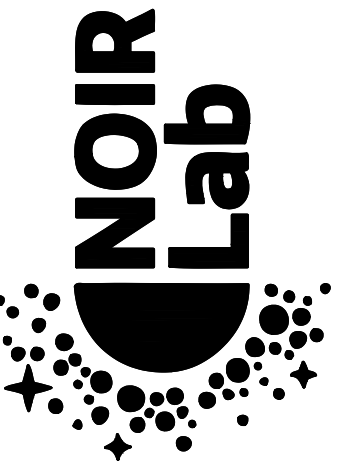


KITT PEAK - Sells, AZ 85634

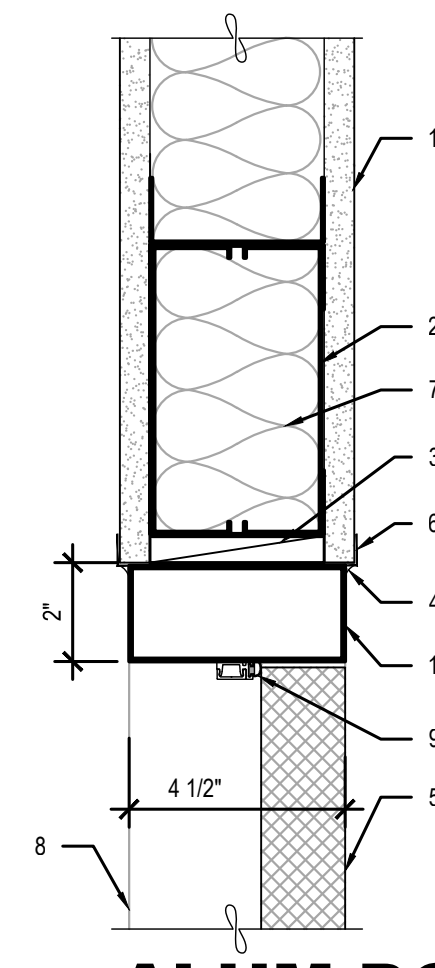

1 ALUM DOOR HEAD 3-5/8" STUD WALL SCALE: 3"=1'-0"

NOTES:

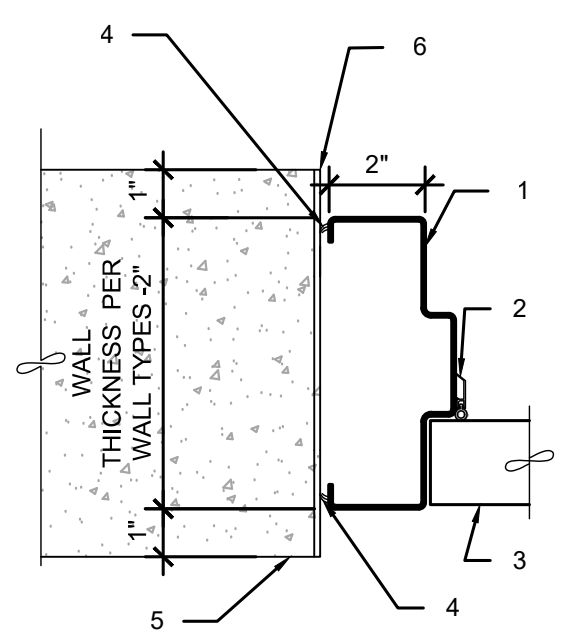
1. WALL PARTITION PER WALL TYPES.
2. 6" METAL STUD BOX BEAM AT HEAD.
3. SHIM AS NEEDED.
4. CAULK BOTH SIDES OF WALL, TYP.
5. DOOR PER SCHEDULE
6. METAL CORNER BEAD AT HEAD & JAMB, TYP.
7. ENCAPSULATE SOUND BATT IN BOX HEADER.
8. DOOR FRAME BEYOND.
9. PEMKO 29310CV DOOR SEAL
10. ALUMINUM DOOR FRAME PER SCHEDULE.



2 DR JAMB @ (E) CONG. SCALE: 3"=1'-0"

1. HOLLOW METAL FRAME PER SCHEDULE ANCHOR TO (E) CONCRETE WALL AT TOP MIDDLE & BOTTOM (TYP.)
2. DOOR SEAL PER DOOR SCHEDULE (TYP.)
3. DOOR PER SCHEDULE (TYP.)
4. CAULK BOTH SIDES OF DOOR (TYP.)
5. (E) CONCRETE WALL PER WALL TYPES
6. 1/4" STEEL PLATE, SECURE TO (E) CONCRETE WALL.

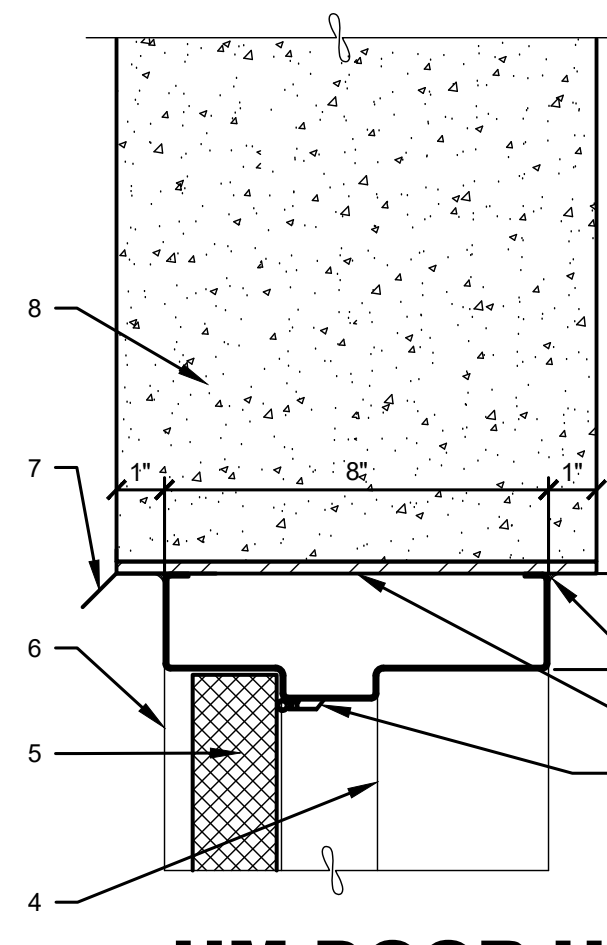
NOTE: VERIFY WALL THICKNESS PRIOR TO ORDERING FRAMES



3 HM DOOR HEAD @ (E) CONCRETE SCALE: 3"=1'-0"

1. CAULK BOTH SIDES OF DOOR (TYP.)
2. DOOR SEAL PER SCHEDULE (TYP.)
3. 1/4" STEEL PLATE, SECURE TO (E) CONCRETE
4. DOOR FRAME (BEYOND)
5. DOOR PER SCHEDULE (TYP.)
6. HOLLOW METAL FRAME PER SCHEDULE (TYP.)
7. 24 GA. METAL DRIP FLASHING (TYP.)
8. (E) CONCRETE PER WALL TYPES.

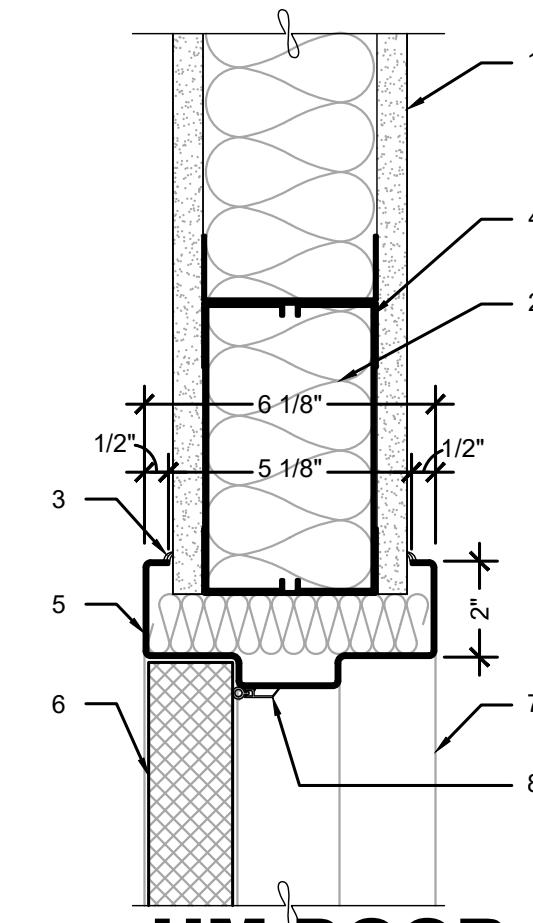
NOTE: VERIFY WALL THICKNESS PRIOR TO ORDERING FRAMES



4 HM DOOR HEAD 3-5/8" STUD WALL SCALE: 3"=1'-0"

1. WALL PARTITION PER WALL TYPES.
2. ENCAPSULATE SOUND BATT IN BOX HEADER.
3. CAULK BOTH SIDES OF WALL, TYP.
4. 6" METAL STUD BOX BEAM AT HEAD.
5. HOLLOW METAL FRAME, FILL VOID WITH SOUND BATT INSULATION.
6. DOOR PER SCHEDULE.
7. DOOR FRAME BEYOND.
8. PEMKO DOOR SEAL 316AV, TYP.

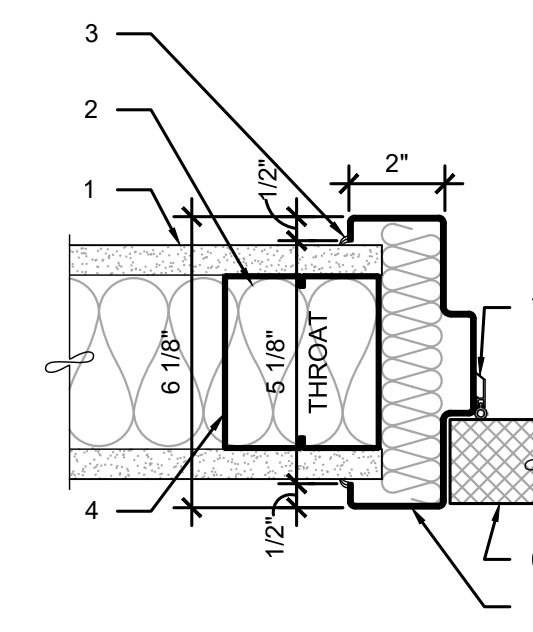NOTE: VERIFY WALL THICKNESS PRIOR TO ORDERING FRAMES



5 HM DOOR JAMB 3-5/8" STUD WALL SCALE: 3"=1'-0"

1. WALL PARTITION PER WALL TYPES.
2. ENCAPSULATE SOUND BATT IN JAMB.
3. CAULK BOTH SIDES OF WALL, TYP.
4. DOUBLE STUD JAMB TYP. EACH SIDE.
5. HOLLOW METAL FRAME, FILL VOID WITH SOUND BATT INSULATION.
6. DOOR PER SCHEDULE.
7. PEMKO DOOR SEAL 316AV, TYP.


NOTE: VERIFY WALL THICKNESS PRIOR TO ORDERING FRAMES

DATE	DESCRIPTION
01/08/21	I.F.C.

PROJECT NUMBER: 11904.00
 DRAWN BY: FH
 CHECKED BY: IR
 CAD FILE: 11904.00-A4.2
 SCALE: AS NOTED


ARCHITECTURAL
WALL TYPES & DETAILS

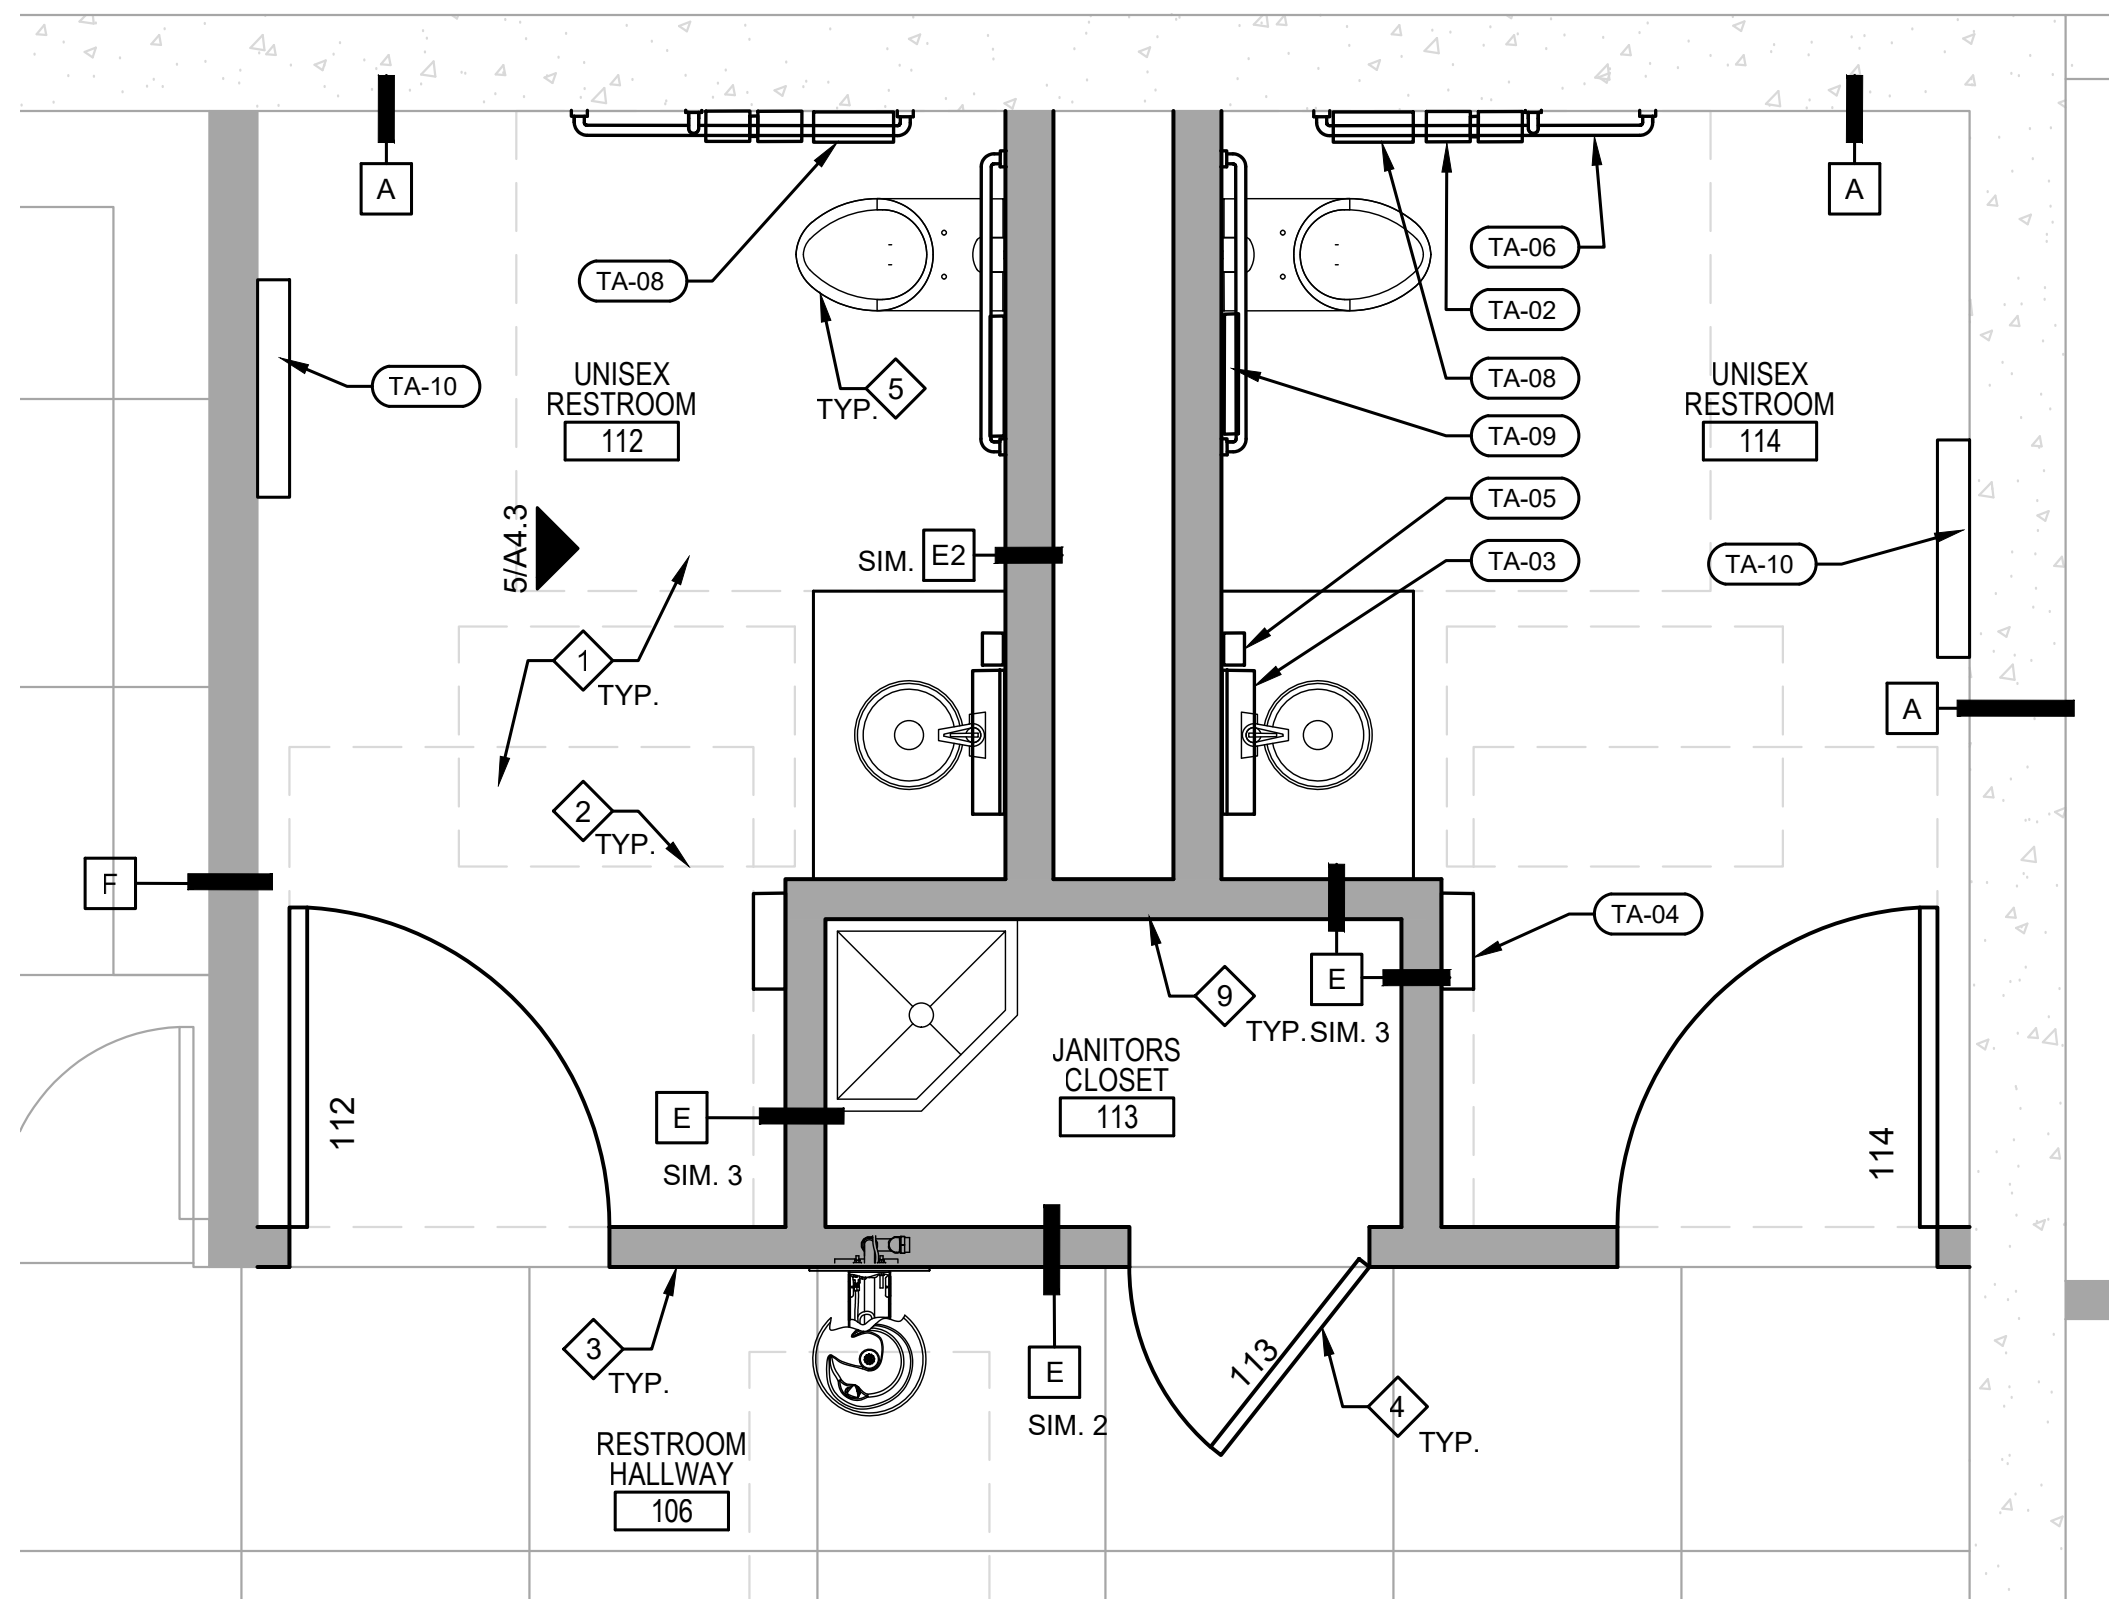A4.2



2 RESTROOM FLOOR PLAN
1ST. LEVEL

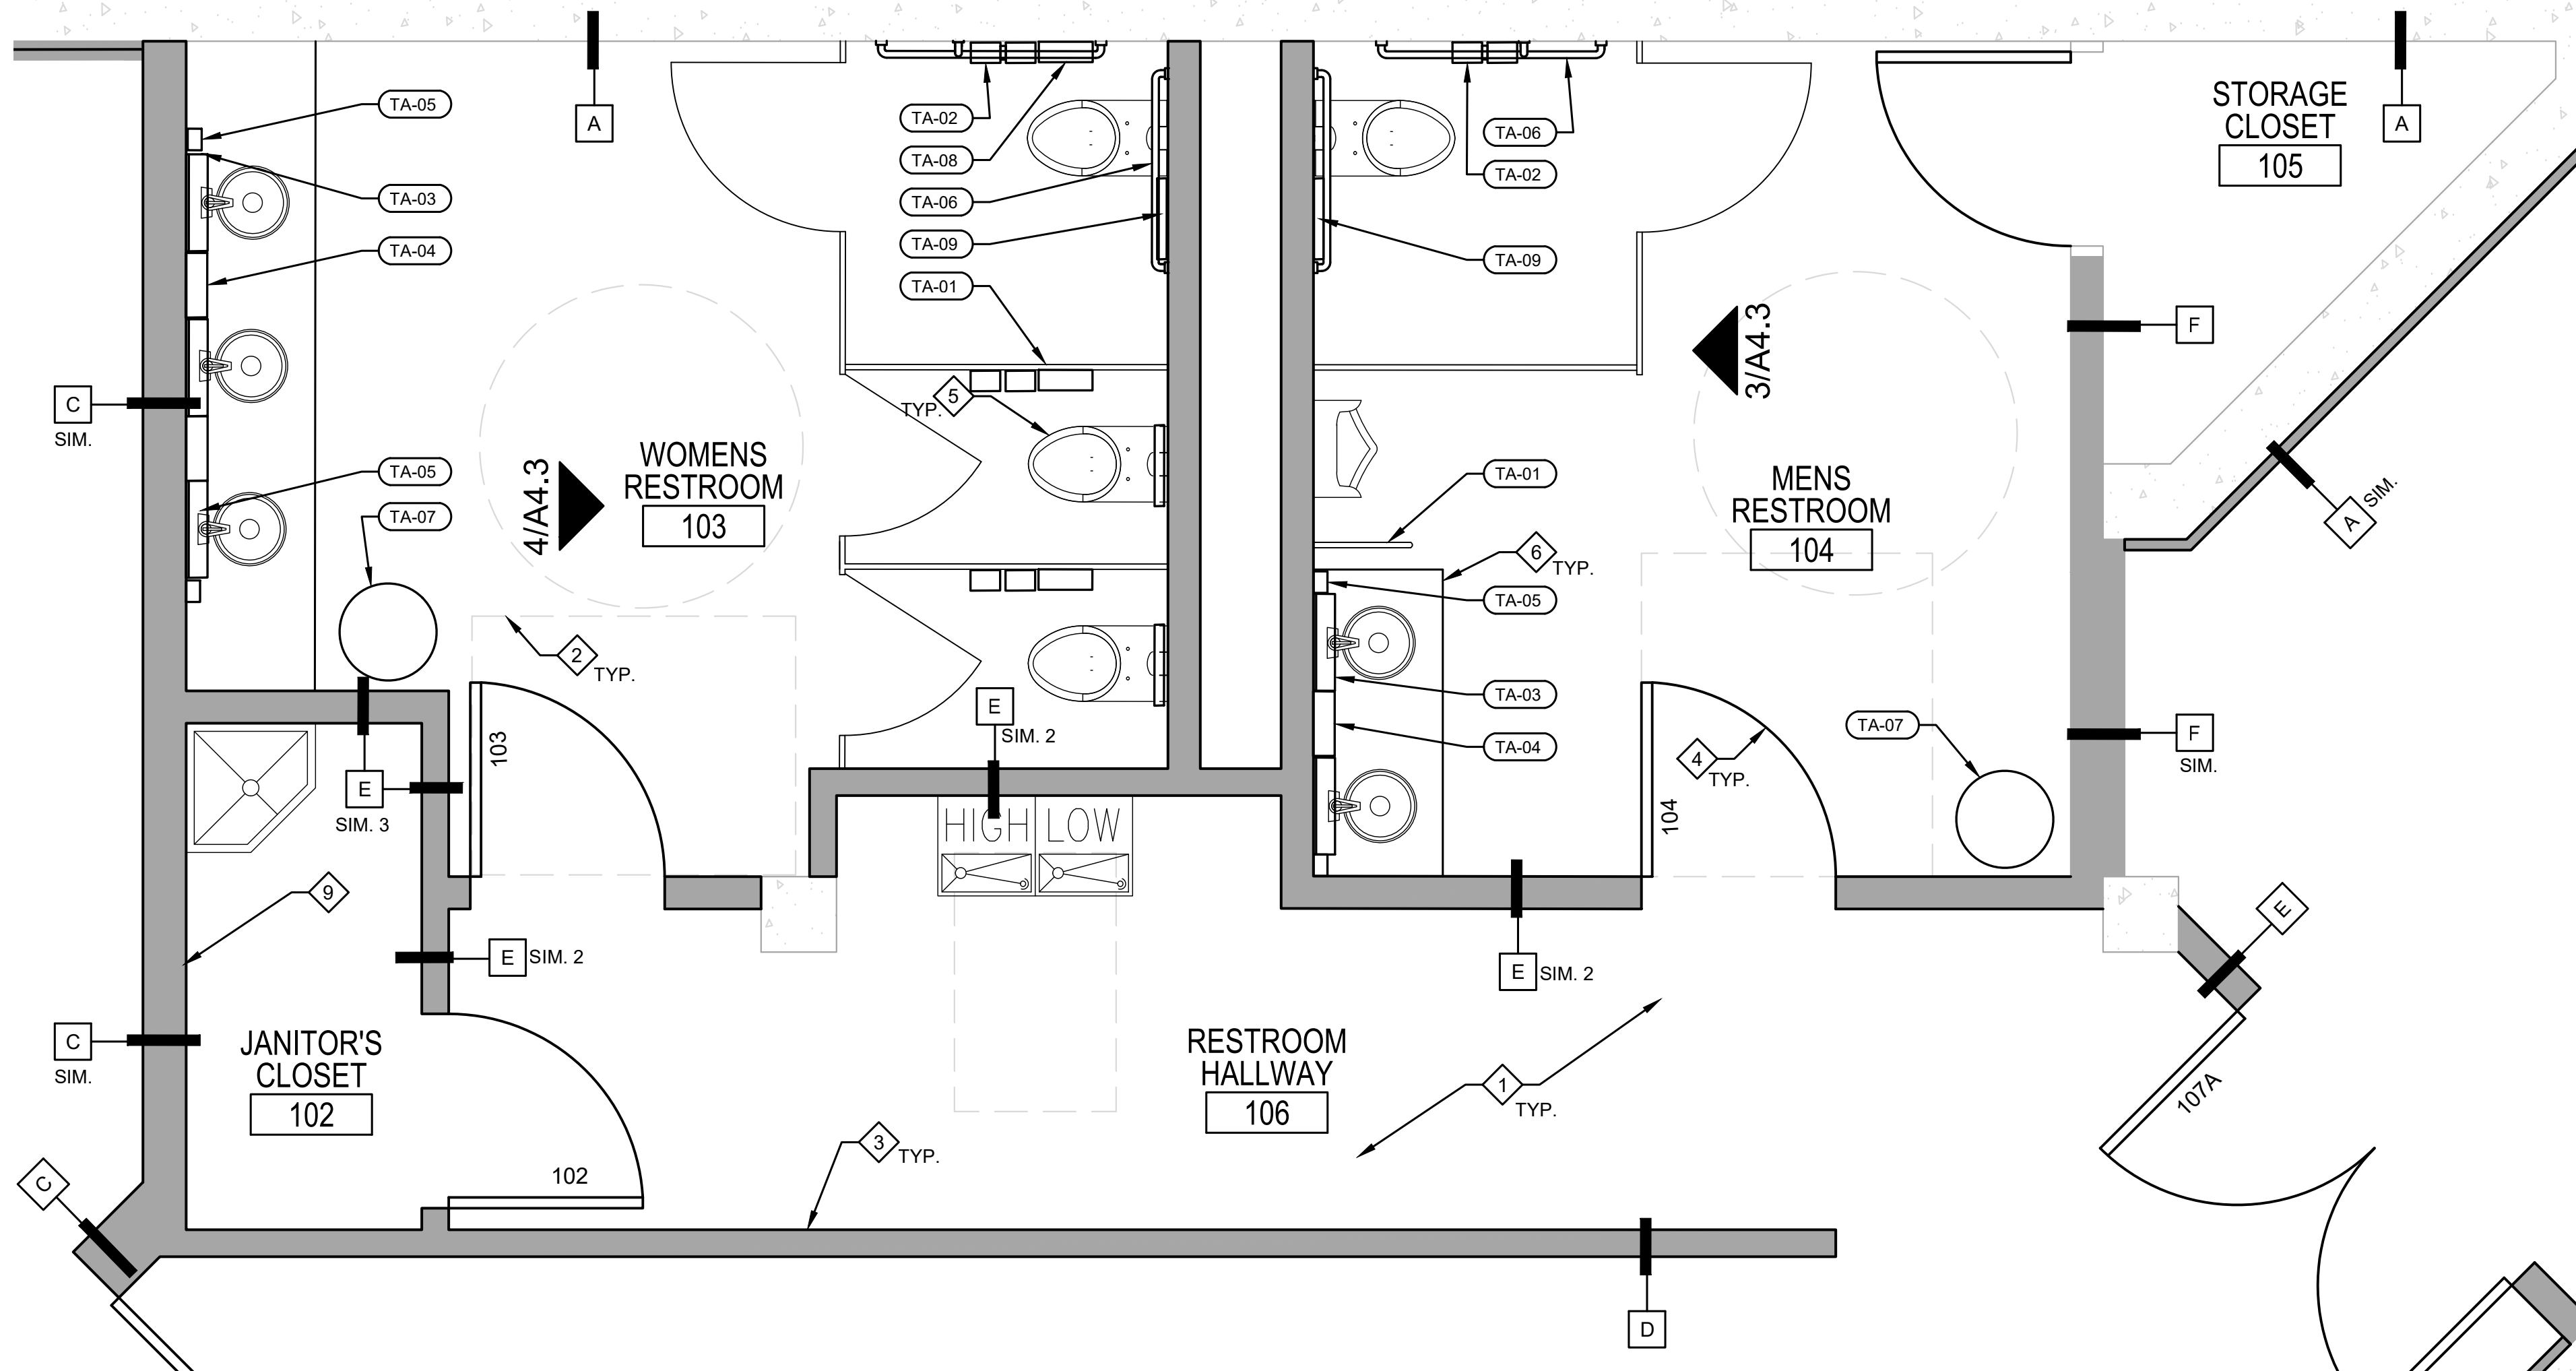SCALE: 1/2" = 1'-0"



1 RESTROOM FLOOR PLAN
1ST. LEVEL

SCALE: 1/2" = 1'-0"

TOILET ACCESSORIES:

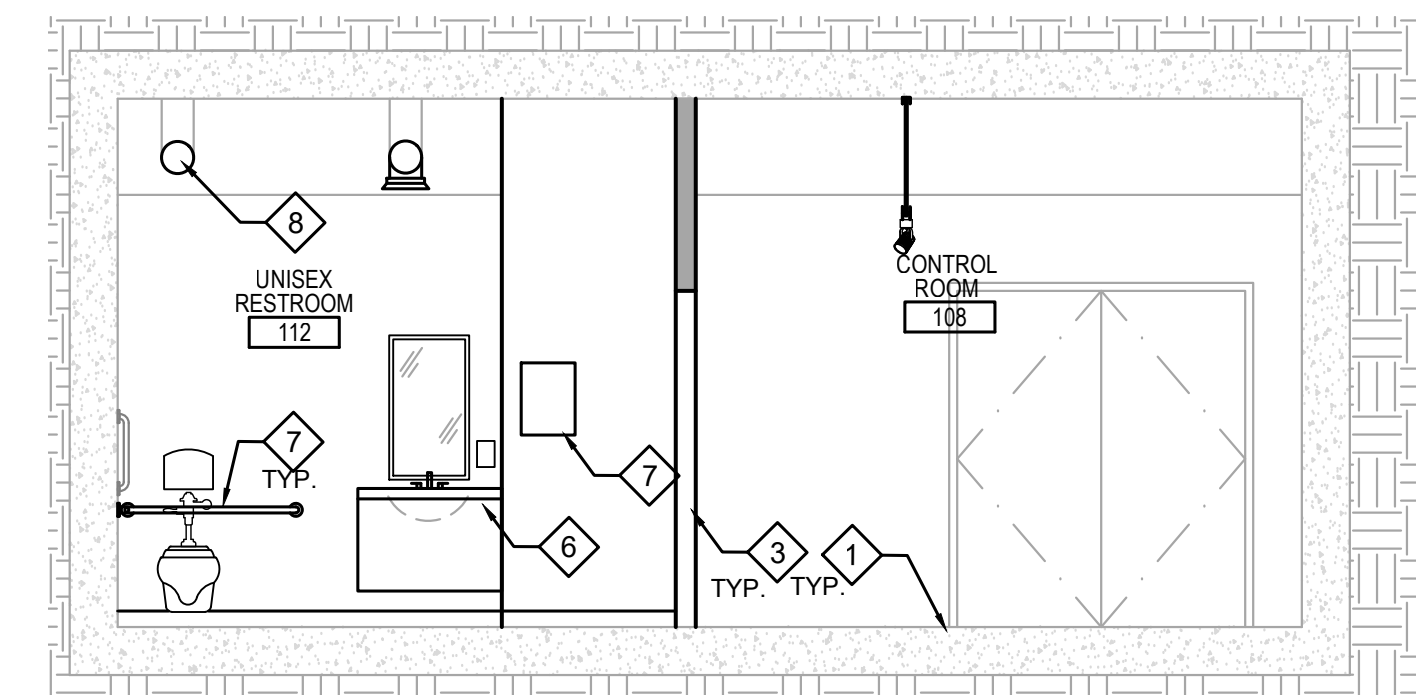
- TA-01. METAL TOILET PARTITION TYP.
- TA-02. BOBRICK SURFACE MT. TISSUE B-7687, IN BRUSHED FINISH, TYPICAL IN ALL RESTROOMS
- TA-03. BOBRICK MIRROR (18 X 36") WITH CELL PHONE SHELF, B-2921836, IN BRUSHED FINISH, TYPICAL IN ALL RESTROOMS
- TA-04. BOBRICK SURFACE MT. PAPER TOWEL DISPENSER, B-262 IN BRUSHED FINISH, TYPICAL IN ALL RESTROOMS
- TA-05. BOBRICK SURFACE MT. SOAP DISPENSER, B-211 IN BRUSHED FINISH, TYPICAL IN ALL RESTROOMS
- TA-06. ADA COMPLIANT GRAB BARS IN BRUSHED FINISH, TYPICAL IN ALL RESTROOMS.
- TA-07. TRASH BIN
- TA-08. BOBRICK SANITARY TRASH B-254, IN BRUSHED FINISH
- TA-09. BOBRICK SEAT COVER DISPENSER B-221, IN BRUSHED FINISH, TYPICAL IN ALL RESTROOMS
- TA-10. BOBRICK BABY CHANGING STATION

KEYNOTES:

- 1. NEW FLOORING PER FINISH SCHEDULE.
- 2. ADA DASHED LINES SHOWN FOR REFERENCE ONLY.
- 3. NEW/REFURBISHED WALL PER WALL TYPES, SEE A4.2 FOR MORE INFO.
- 4. NEW DOOR. SEE DOOR SCHEDULES ON A4.1
- 5. PLUMBING FIXTURE. SEE MECHANICAL.
- 6. NEW MILLWORK. SEE SCHEDULES.
- 7. TOILET ACCESSORY. SEE ENLARGED PLANS
- 8. NEW DUCTS, SEE MECHANICAL FOR MORE INFO.
- 9. PROVIDE FRP PANELING 4" ABOVE FINISH FLOOR AT ALL WET WALL LOCATIONS OF JANITOR CLOSETS


RENOVATION GENERAL NOTES:

- A. REFER TO THE ENTIRE SET FOR ADDITIONAL INFORMATION AND REQUIREMENTS.
- B. COORDINATE ALL WORK WITH STRUCTURAL, ELECTRICAL, MECHANICAL DRAWINGS & OTHER DISCIPLINES INVOLVED.
- C. VERIFY ALL FIELD CONDITIONS & DIMENSIONS, NOTIFY ARCHITECT OF ANY DISCREPANCIES PRIOR TO COMMENCEMENT OF WORK.
- D. UNLESS NOTED OTHERWISE, ALL WORK DESCRIBED SHALL BE PERFORMED BY CONTRACTOR. FOR ITEMS REQUIRING OWNER DIRECTION, CONTRACTOR SHALL COORDINATE DIRECTLY WITH OWNER. THIS INCLUDES BUT IS NOT LIMITED TO FURNITURE RELOCATION, EQUIPMENT RELOCATION, I.T. ITEMS, ETC.
- E. DO NOT SCALE DRAWINGS. IF DIMENSIONS ARE NOT PROVIDED, CONTACT ARCHITECT FOR CLARIFICATION.
- F. CONTRACTOR TO PROVIDE DETAILED PHASING, DEBRIS, DUST CONTROL METHODS, ISOLATION, AND ACCESS TO RESTROOMS TO OWNER FOR APPROVAL PRIOR TO INITIATION OF WORK.
- G. MAINTAIN A SAFE AND CLEAN WORK AREA - REMOVE ALL TRASH AND DEBRIS AT THE END OF EACH WORK SHIFT.
- H. PROVIDE PERSONNEL PROTECTION FROM DEBRIS & MATERIAL FALL PER OWNER STANDARDS, INCLUDING BUT NOT LIMITED TO SCAFFOLDING FOR OVERHEAD PROTECTION WITH TOE BOARDS, & VISQUEEN DUST BARRIER.
- I. CONTRACTOR TO AVOID MOVING MATERIALS OR TOOLS THROUGH OPERATING AREAS.
- J. CONTRACTOR TO VERIFY AND COORDINATE WITH OWNER BEFORE DISCONNECTING OR SHUTTING OFF ANY UTILITIES DURING CONSTRUCTION.
- K. COORDINATE ALL DISMANTLING, REMOVALS, STAGING, AND OTHER WORK WITH OWNER PRIOR TO INITIATION OF WORK.
- L. PROVIDE TEMPORARY INDEPENDENT SUPPORT FOR SYSTEMS AND EQUIPMENT SERVING OPERATIONAL AREAS, INCLUDING BUT NOT LIMITED TO: FIRE PROTECTION, LIGHTING, PIPING, CONDUITS, ETC.
- M. ALL INTERIOR AND EXTERIOR STRUCTURE IS EXISTING TO REMAIN UNLESS NOTED OTHERWISE.




5 RESTROOM 112/ 114 ELEVATION
1ST. LEVEL

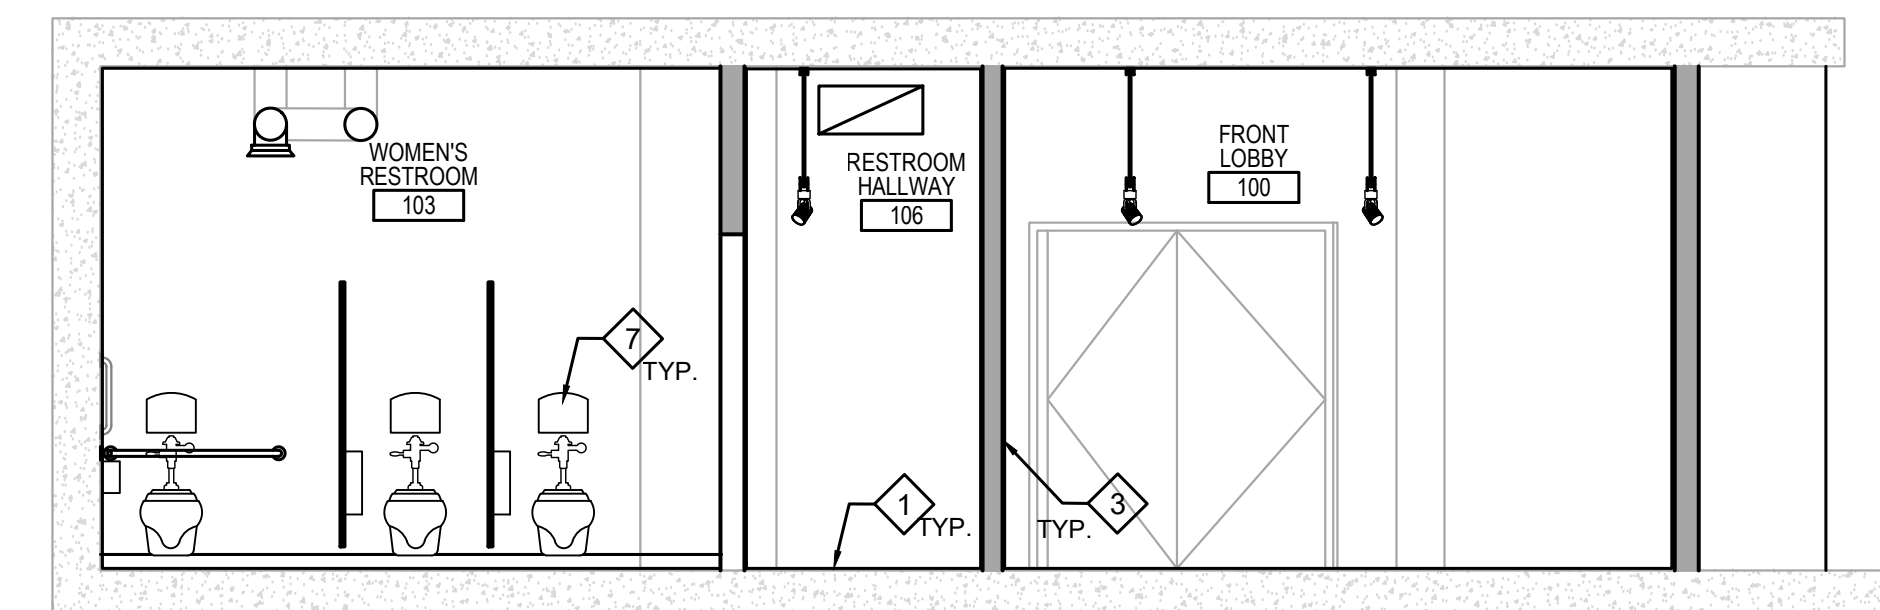SCALE: 1/4" = 1'-0"



4 RESTROOM 103 ELEVATION
1ST. LEVEL

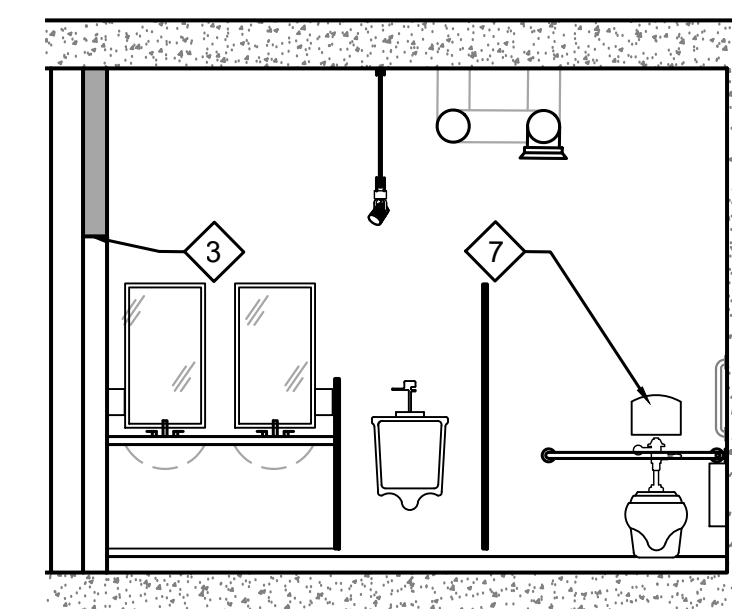SCALE: 1/4" = 1'-0"




3 RESTROOM 104 ELEVATION
1ST. LEVEL

SCALE: 1/4" = 1'-0"



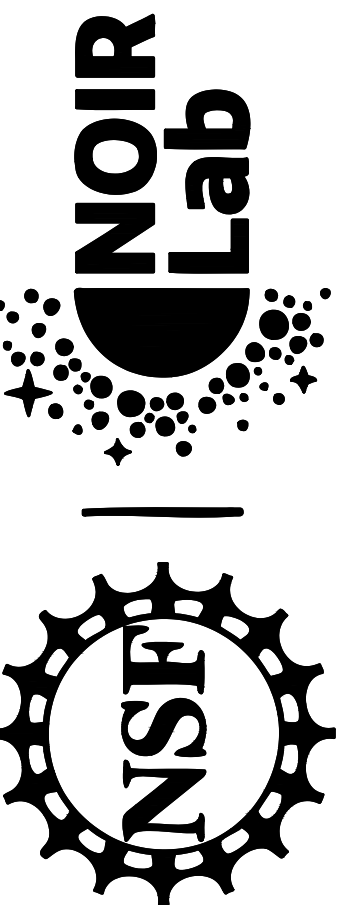WINDOWS ON
THE UNIVERSE
CENTER FOR
ASTRONOMY
OUTREACH




KITT PEAK - Sells, AZ 85634

DATE	DESCRIPTION
0 01/08/21	I.F.C.

PROJECT NUMBER:	11904.00
DRAWN BY:	FH
CHECKED BY:	IR
CAD FILE:	11904.00-A4.3
SCALE:	AS NOTED



ARCHITECTURAL
RESTROOM PLANS
AND ELEVATIONS

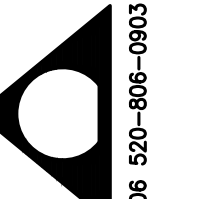A4.3



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WINDOWS ON
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 OUTREACH

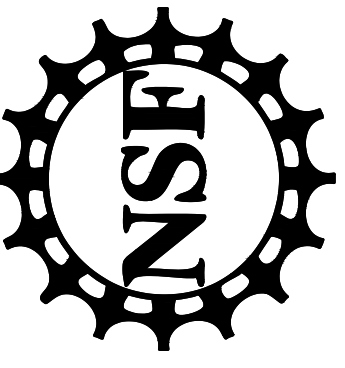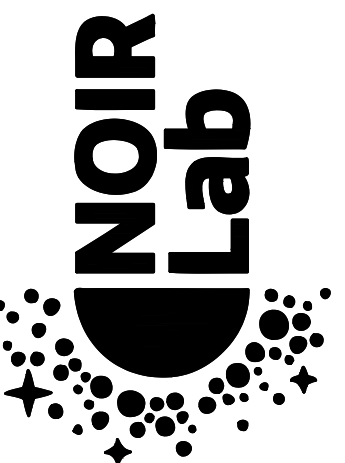


KITT PEAK - Sells, AZ 85634

△	DATE	DESCRIPTION
0	01/08/21	I.F.C.

PROJECT NUMBER: 11904.00
 DRAWN BY: FH
 CHECKED BY: IR
 CAD FILE: 11904.00-A4.4
 SCALE: AS NOTED

ARCHITECTURAL
 RAMP & STAIR
 DETAILS

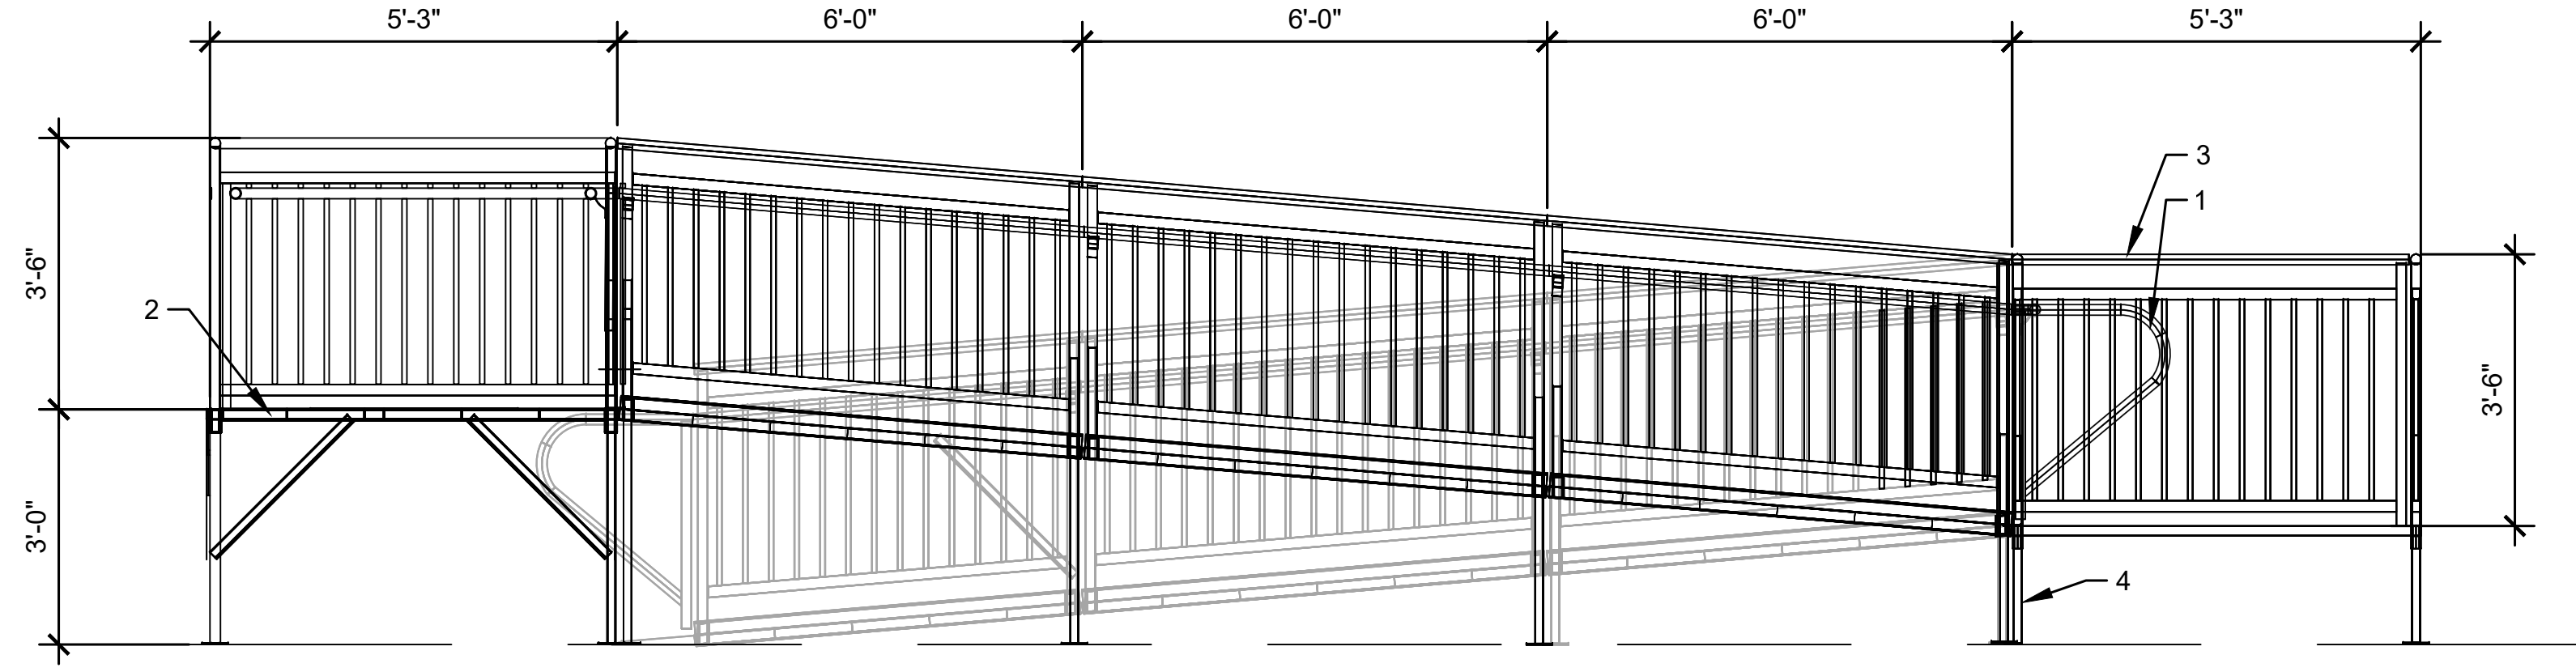A4.4




1. UNIVERSAL HANDRAIL, PRIME & PAINT, TYP.
2. PLATFORM TREAD.
3. TOP GUARDRAIL.
4. TYP. LEG POST.

2 RAMP PLAN AND ELEVATION


SCALE: 1/2" = 1'-0"

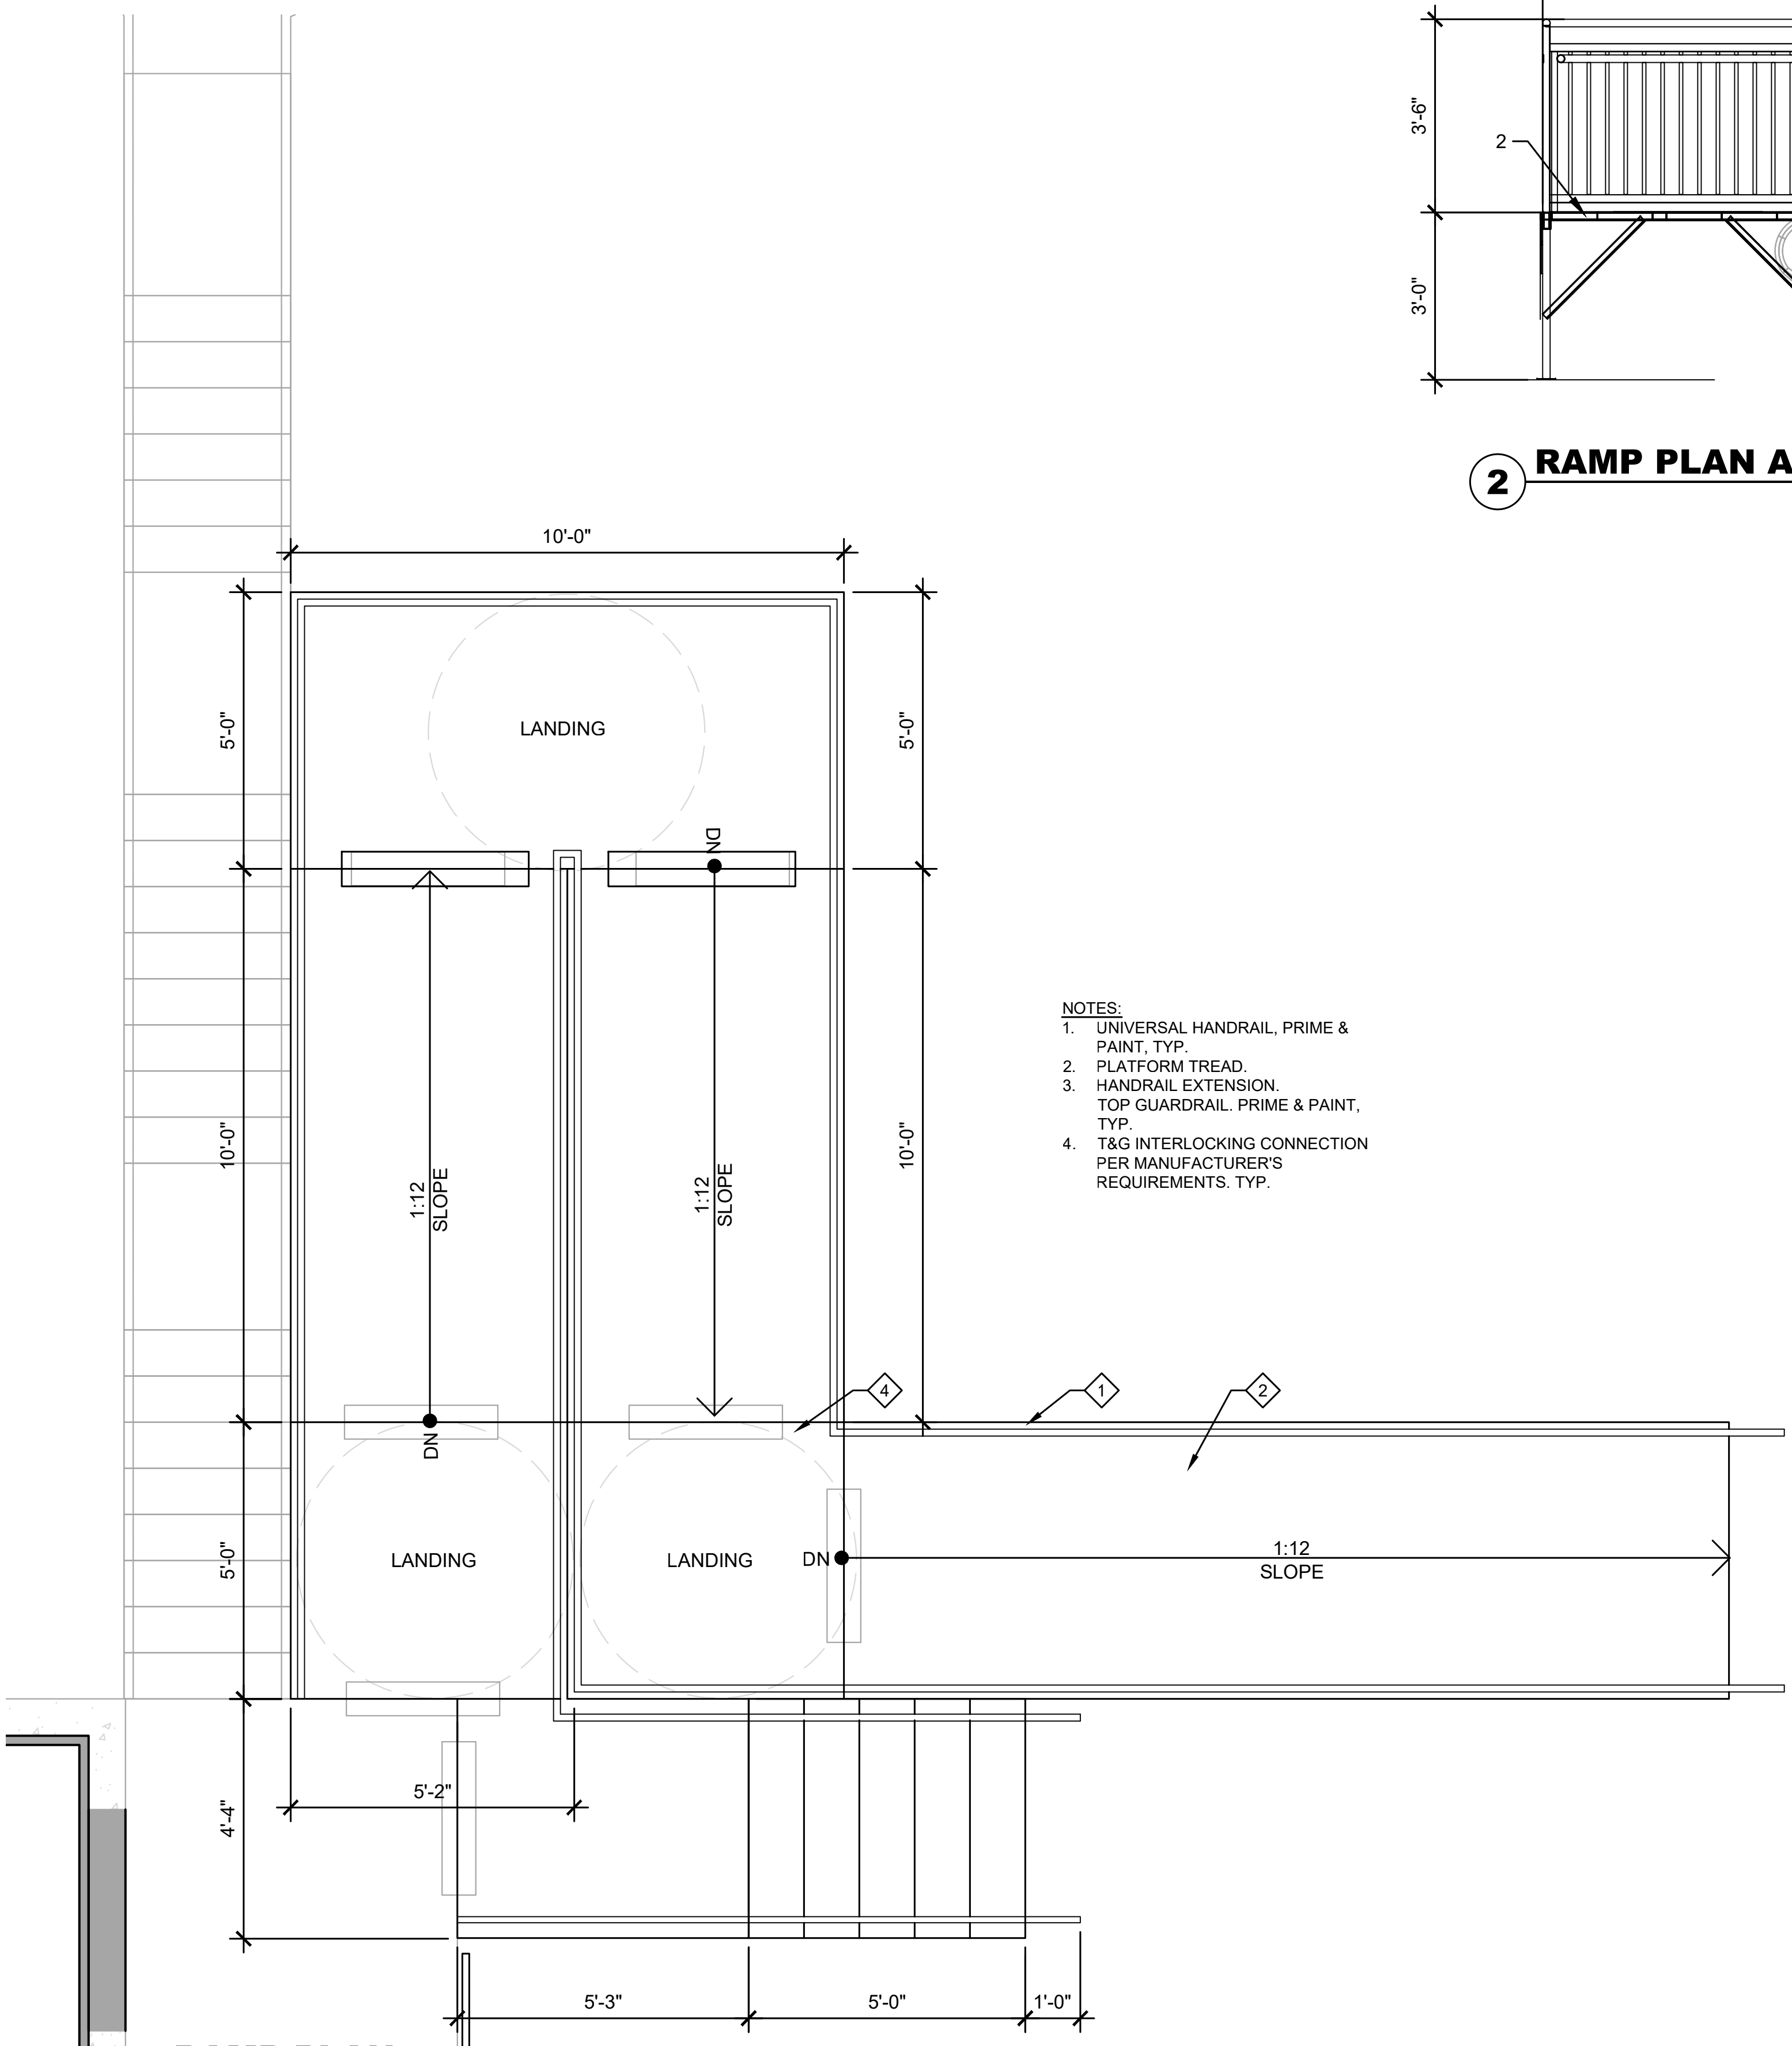NOTE: STAIR AND RAMP TO BE PREFAB EQUAL TO AMERICAN ACCESS.



- NOTES:
1. UNIVERSAL HANDRAIL, PRIME & PAINT, TYP.
 2. PLATFORM TREAD.
 3. HANDRAIL EXTENSION. TOP GUARDRAIL. PRIME & PAINT, TYP.
 4. T&G INTERLOCKING CONNECTION PER MANUFACTURER'S REQUIREMENTS. TYP.

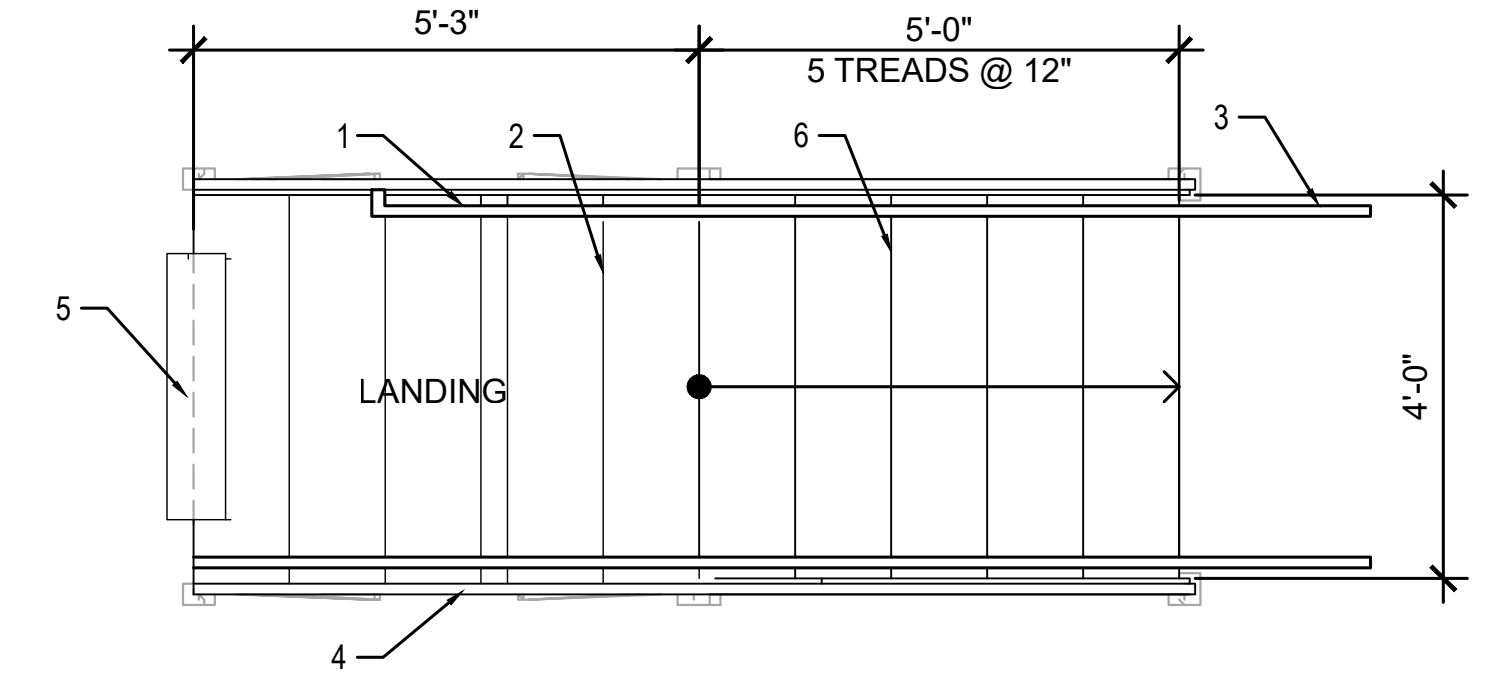
1 RAMP PLAN



1. UNIVERSAL HANDRAIL, PRIME & PAINT, TYP.
2. PLATFORM TREAD, TYP.
3. HANDRAIL EXTENSION. TOP GUARDRAIL. PRIME & PAINT, TYP.
4. T&G INTERLOCKING CONNECTION PER MANUFACTURER'S REQUIREMENTS.
5. TREAD TYP.
6. TYP. LEG POST.

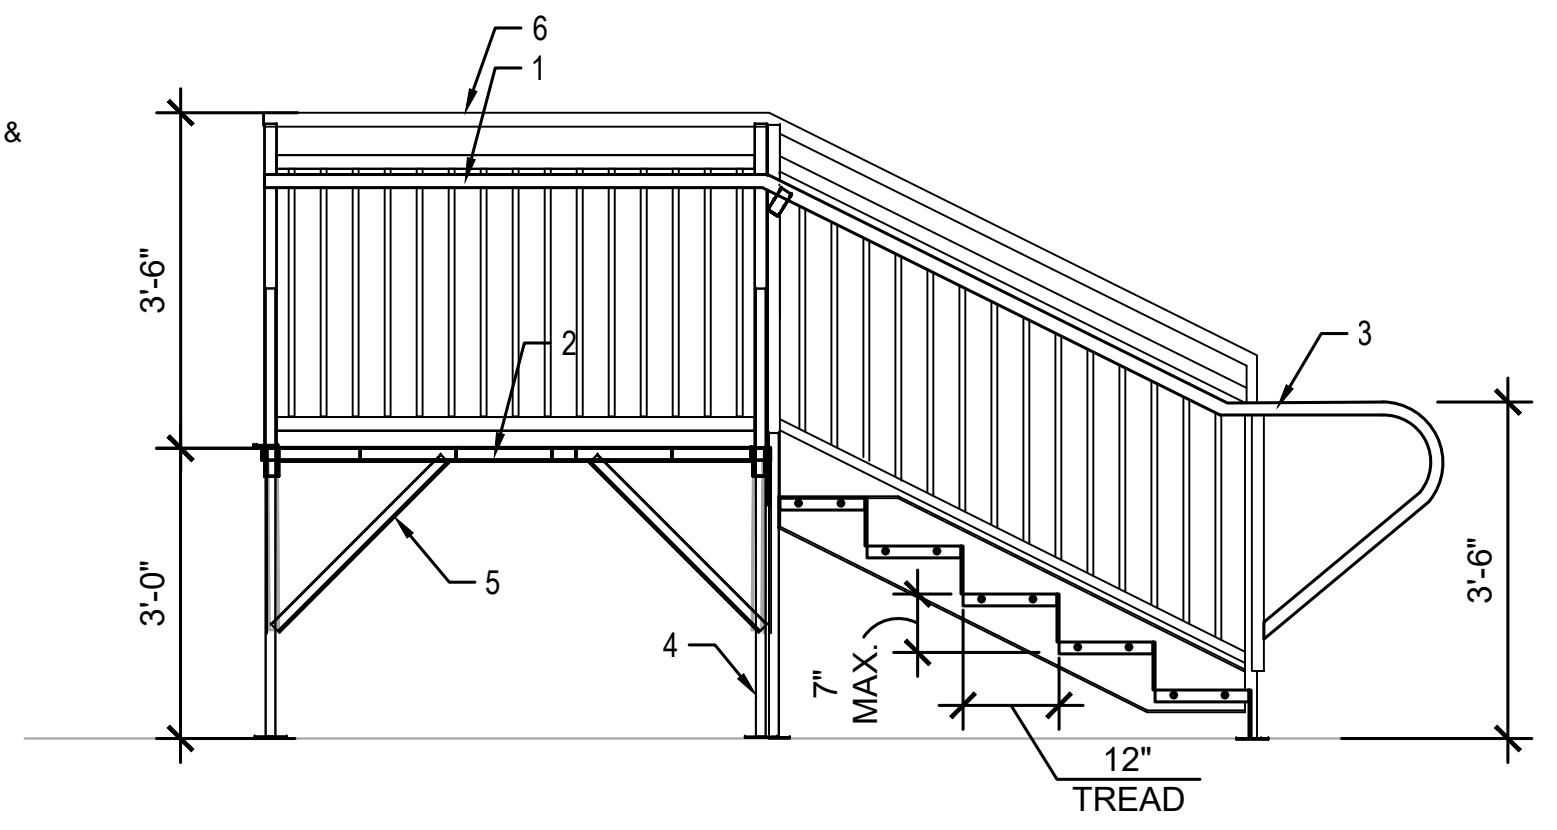4 STAIR PLAN

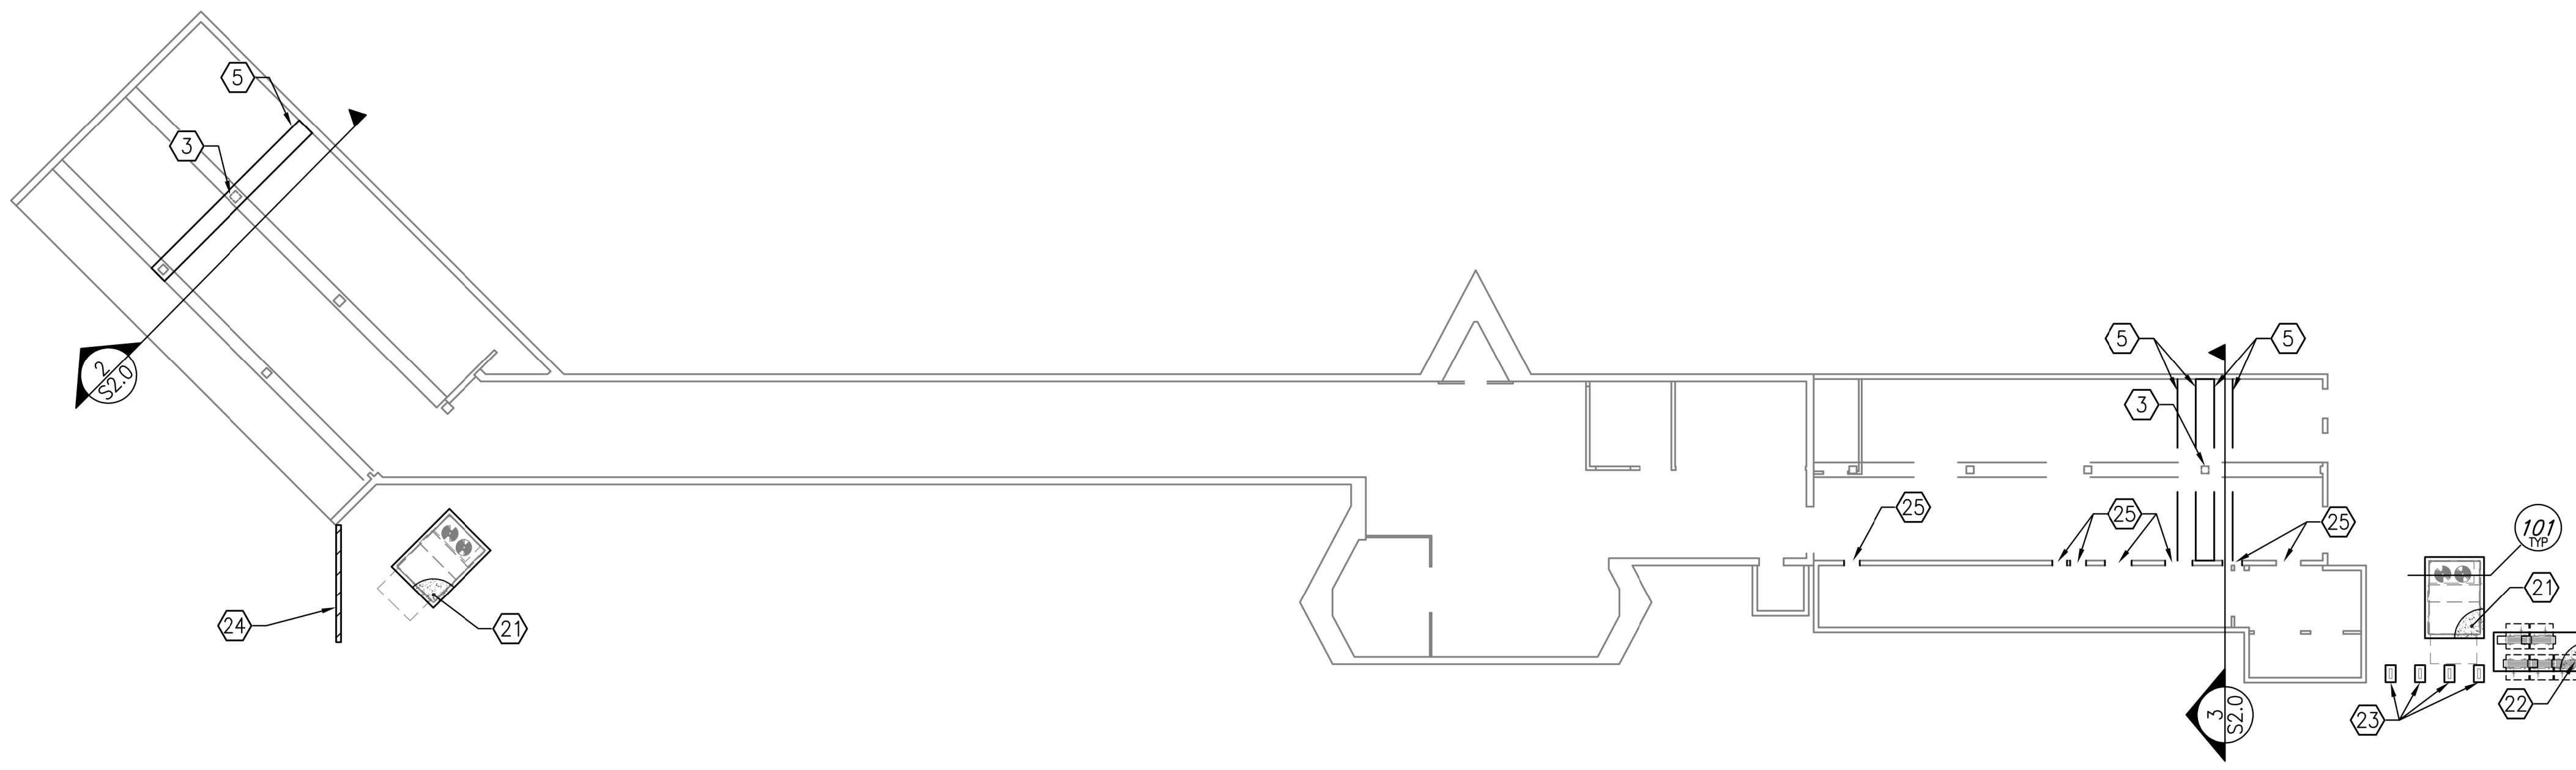
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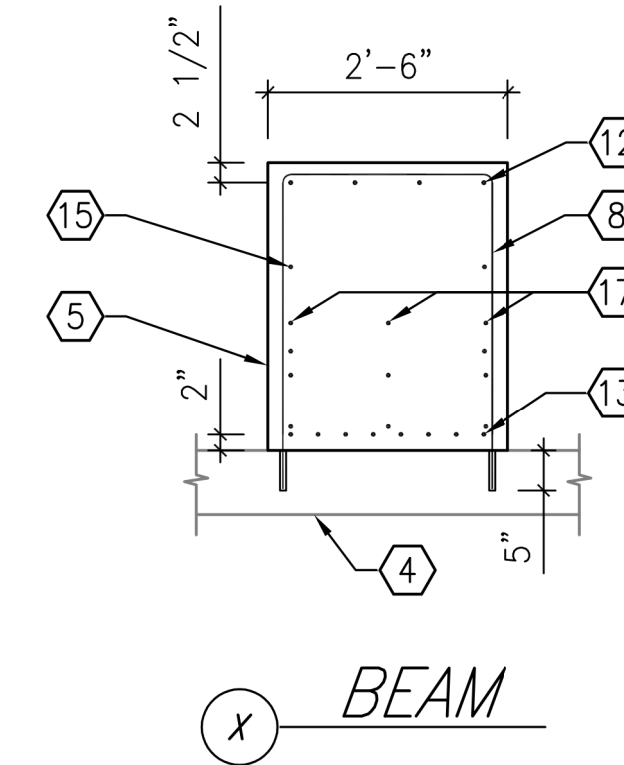
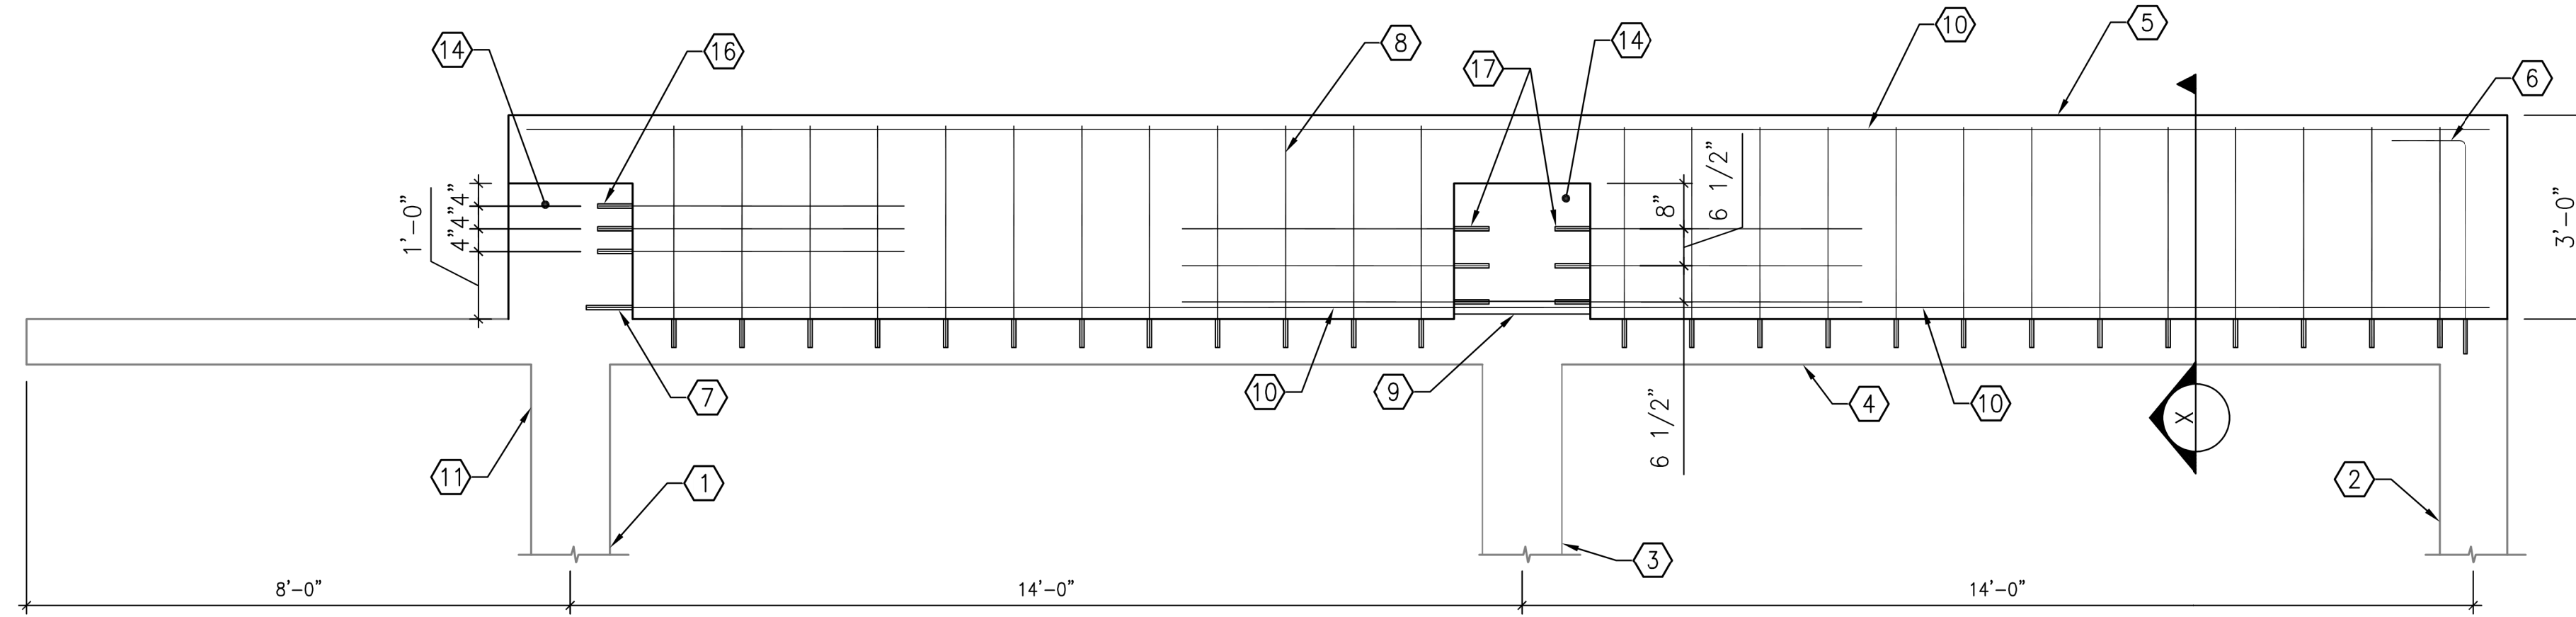
1. UNIVERSAL HANDRAIL, PRIME & PAINT, TYP.
2. PLATFORM TREAD.
3. HANDRAIL EXTENSION.
4. TYP. LEG POST.
5. TYP. ANGLE BRACING.
6. TOP GUARDRAIL.

3 STAIR SECTION

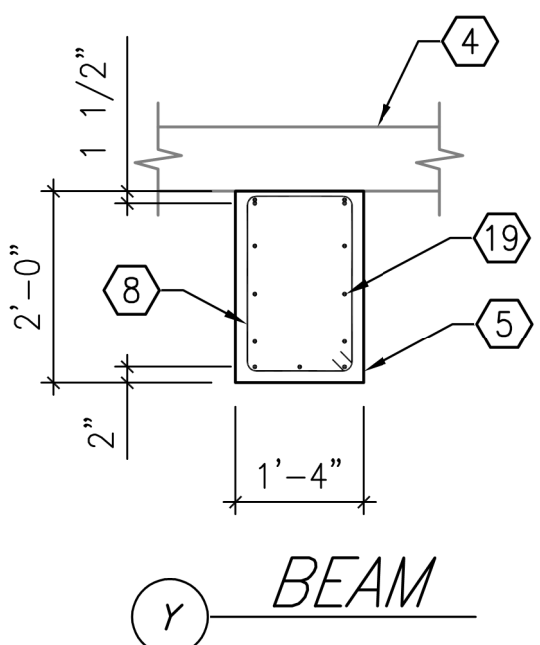
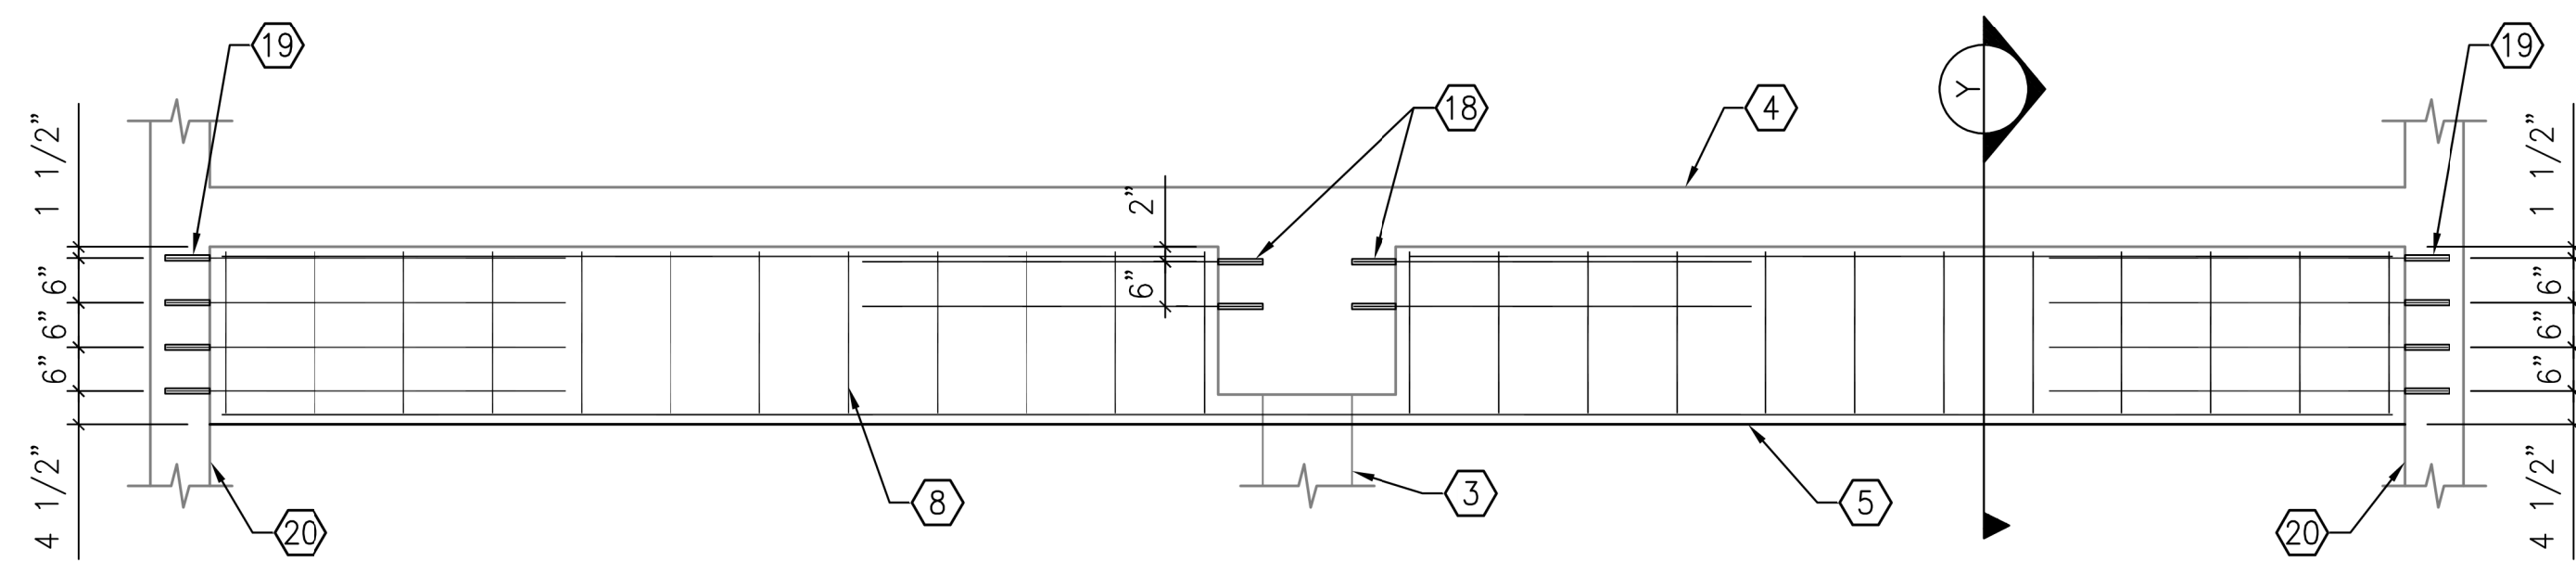
SCALE: 1/4" = 1'-0"



1 ROOF PLAN
SCALE: 1/16"=1'-0"



2 BEAM SECTION
SCALE: 1/2"=1'-0"




3 BEAM SECTION
SCALE: 1/2"=1'-0"

KEYNOTES:

- EXISTING 14" SQUARE COLUMN.
- EXISTING 12" THICK WALL.
- COLUMN TO BE REMOVED AFTER NEW BEAM IS IN PLACE AND HAS REACHED DESIGN STRENGTH.
- EXISTING 8" CONCRETE SLAB.
- NEW CONCRETE BEAM.
- (4) #5 DRILLED AND EPOXIED INTO SLAB WITH 6" EMBED.
- DRILL AND EPOXY BOTTOM BARS INTO BEAM WITH 8" EMBED.
- #4 TIES AT 12" O.C. DRILLED AND EPOXIED INTO EXISTING SLAB.
- 2 1/4" DIA. FILLED WITH NON-SHRINK GROUT AFTER BAR IS INSTALLED.
- DO NOT SPLICE BARS.
- REINFORCE COLUMN WITH FRP TO SUPPORT 84 KIP DL, 23 KIP LL, 105 KIP SOIL LOAD.
- (4) #9 x CONTINUOUS TOP REINFORCING BARS.
- (7) #11 x CONTINUOUS BOTTOM REINFORCING BARS.
- EXISTING CONCRETE BEAM.
- #5 MID HEIGHT BARS TYPICAL AS SHOWN.
- 2 ROWS OF (3) #6 x4'-0" LONG DRILLED AND EPOXIED INTO EXISTING BEAM WIT 6" EMBEDMENT.
- 3 ROWS OF (3) #6 x4'-0" LONG DRILLED AND EPOXIED INTO EXISTING BEAM WIT 6" EMBEDMENT.
- 2 ROWS OF (2) #6 x4'-0" LONG DRILLED AND EPOXIED INTO EXISTING BEAM WIT 6" EMBEDMENT.
- 2 ROWS OF (4) #6 x4'-0" LONG DRILLED AND EPOXIED INTO EXISTING BEAM WIT 6" EMBEDMENT.
- EXISTING 8" THICK CONCRETE WALL.
- 11'-0"x8'-0"x12" THICK CONCRETE PAD.
- 13'-0"x5'-4"x12" THICK CONCRETE PAD.
- 1'-5"x2'-4"x12" THICK CONCRETE PAD.
- 16'-0" LONG CMU WALL - SEE TYPICAL DETAIL 03.
- NEW SAWCUT WALL OPENING. DO NOT OVERCUT OPENING. NO LINTEL IS REQUIRE IF AT LEAST 2 FEET OF SOLID CONCRETE IS ABOVE TOP OF OPENING

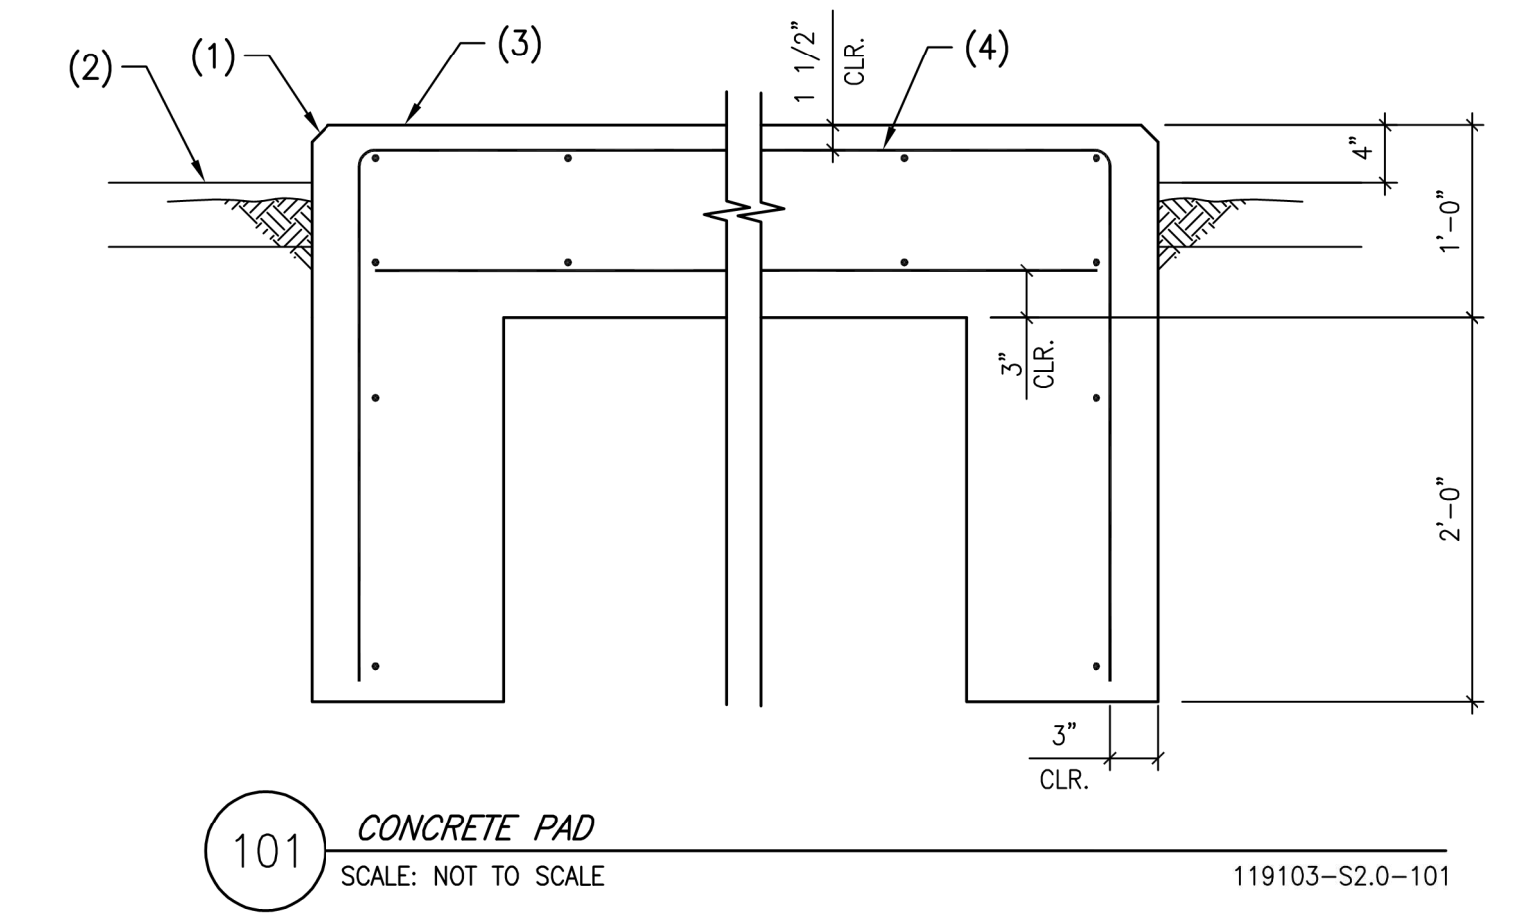
- NOTES:**
- CHAMFER EDGES.
 - CONCRETE SLAB OR FINISHED GRADE WHERE OCCURS.
 - CONCRETE EQUIPMENT SLAB.
 - #4 AT 12" O.C. EACH WAY TOP AND BOTTOM.





101 CONCRETE PAD
SCALE: NOT TO SCALE



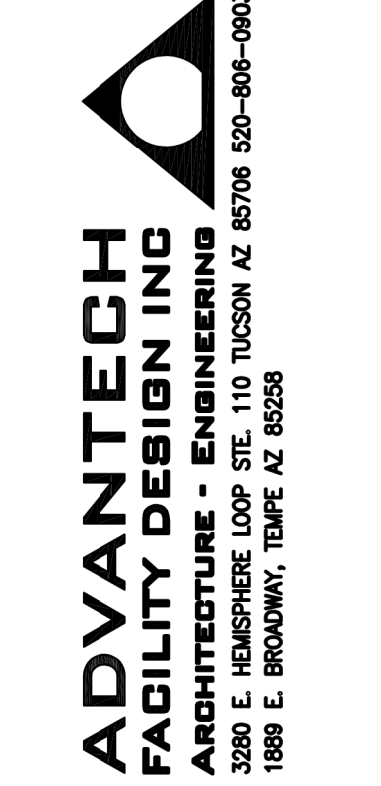This Electronic Signature Has Been Authorized By Me
This 01/08/21



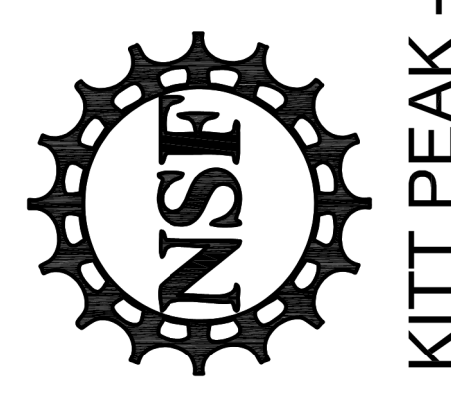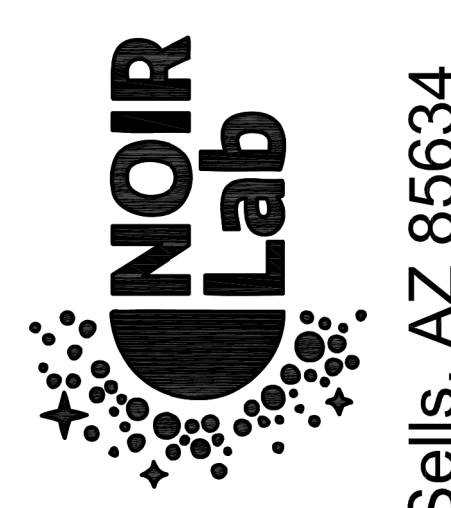WINDOWS ON THE UNIVERSE
CENTER FOR ASTRONOMY OUTREACH



KITT PEAK - Sells, AZ 85634

DATE	DESCRIPTION
0 01/08/21	I.F.C.

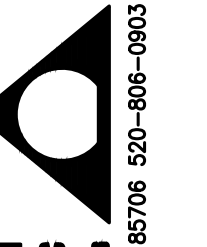
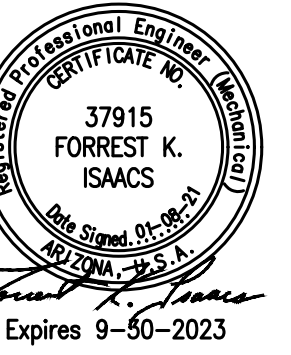
PROJECT NUMBER: 11904.00
DRAWN BY: SAM
CHECKED BY: RHS
CAD FILE:
SCALE: NTS



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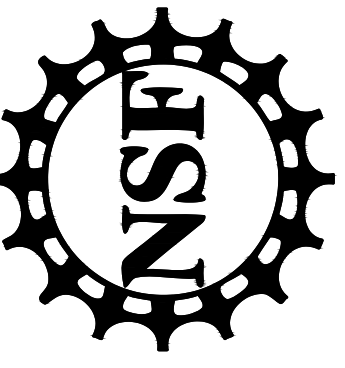
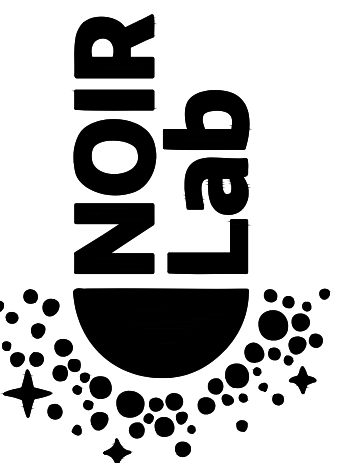
S2.0
PLAN, SECTION AND DETAIL

UNLESS THIS DRAWING IS SIGNED AND SEALED BY A LICENSED STRUCTURAL ENGINEER, IT IS A PRELIMINARY DESIGN AND SHALL NOT BE USED FOR CONSTRUCTION.



ADVANTECH
FACILITY DESIGN INC
ARCHITECTURE - ENGINEERING
3280 E. HEMISPHERE LOOP STE. 110 TUCSON AZ 85706 520-806-0903
1889 E. BROADWAY, TEMPE, AZ 85288


WINDOWS ON
THE UNIVERSE
CENTER FOR
ASTRONOMY
OUTREACH



KITT PEAK - Sells, AZ 85634

△	DATE	DESCRIPTION
0	01/08/21	I.F.C.

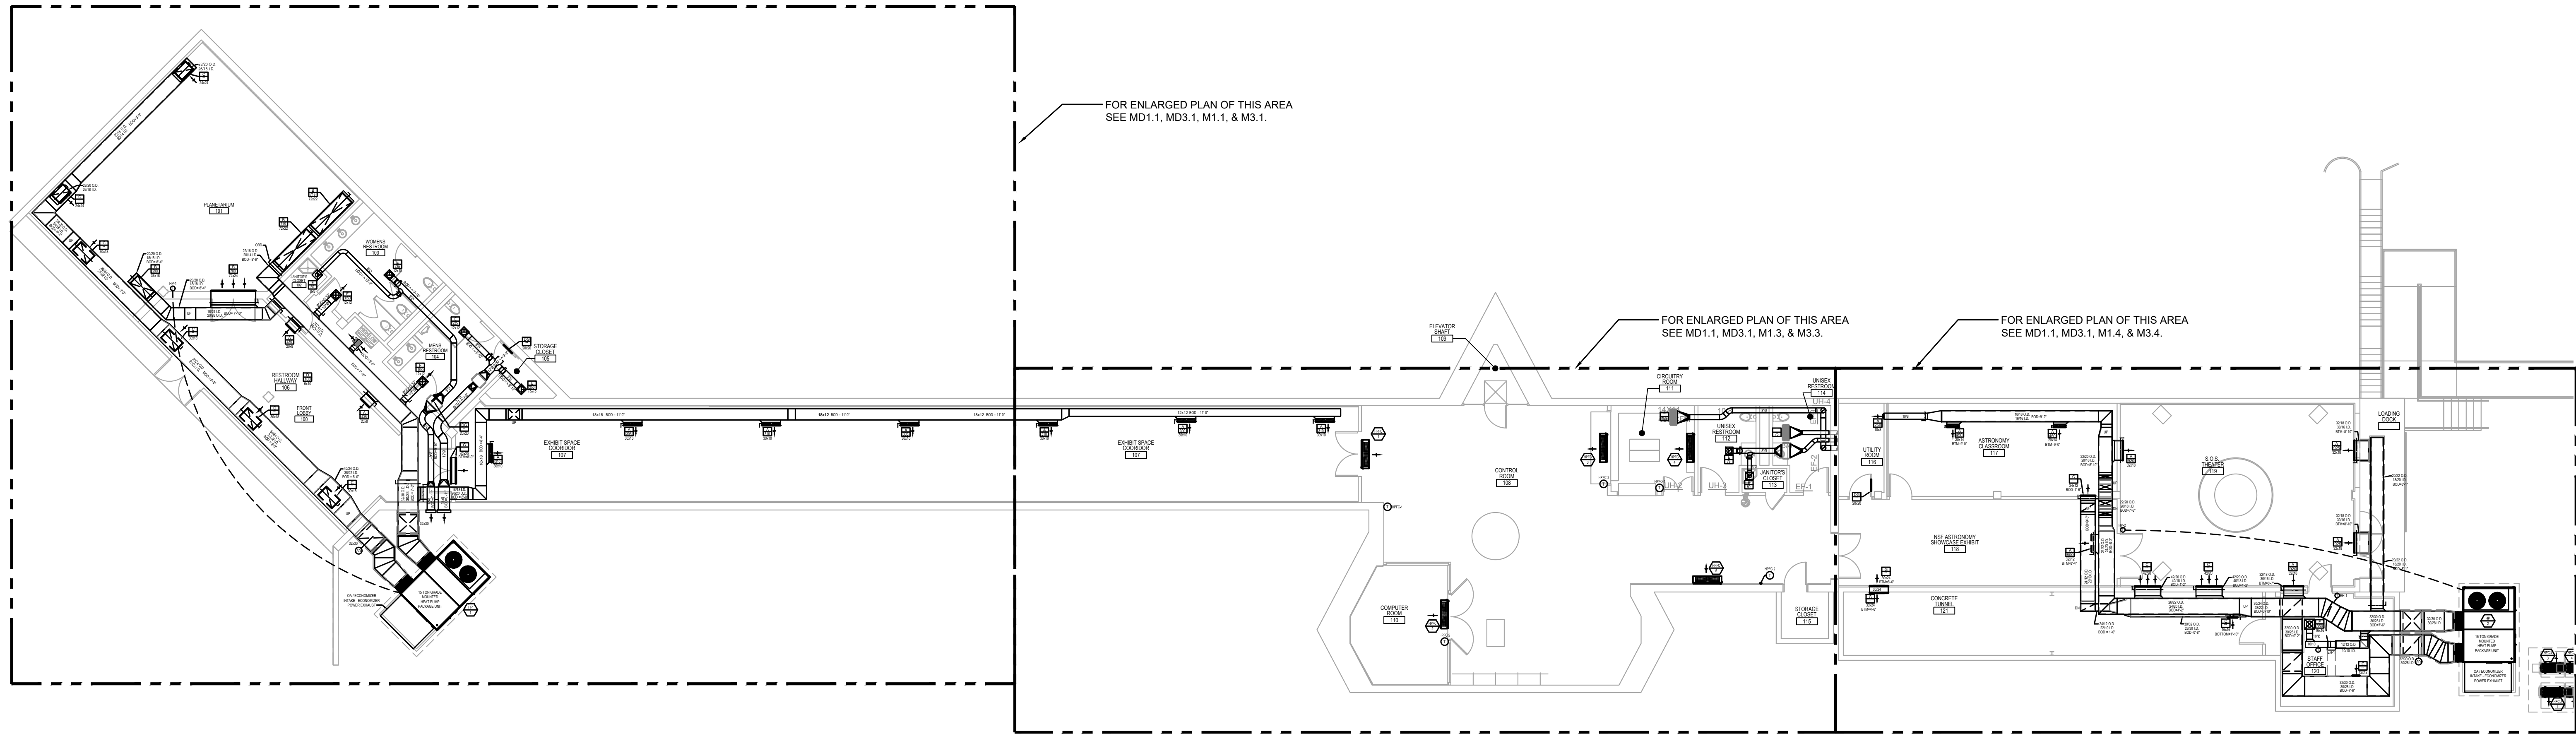PROJECT NUMBER: 11904.00
 DRAWN BY: FI
 CHECKED BY: FI
 CAD FILE: 11904.00-M0.1
 SCALE: AS SHOWN




1 MECHANICAL OVERALL PLAN
1ST LEVEL


SCALE: 3/32"=1'-0"

MECHANICAL
OVERALL PLAN

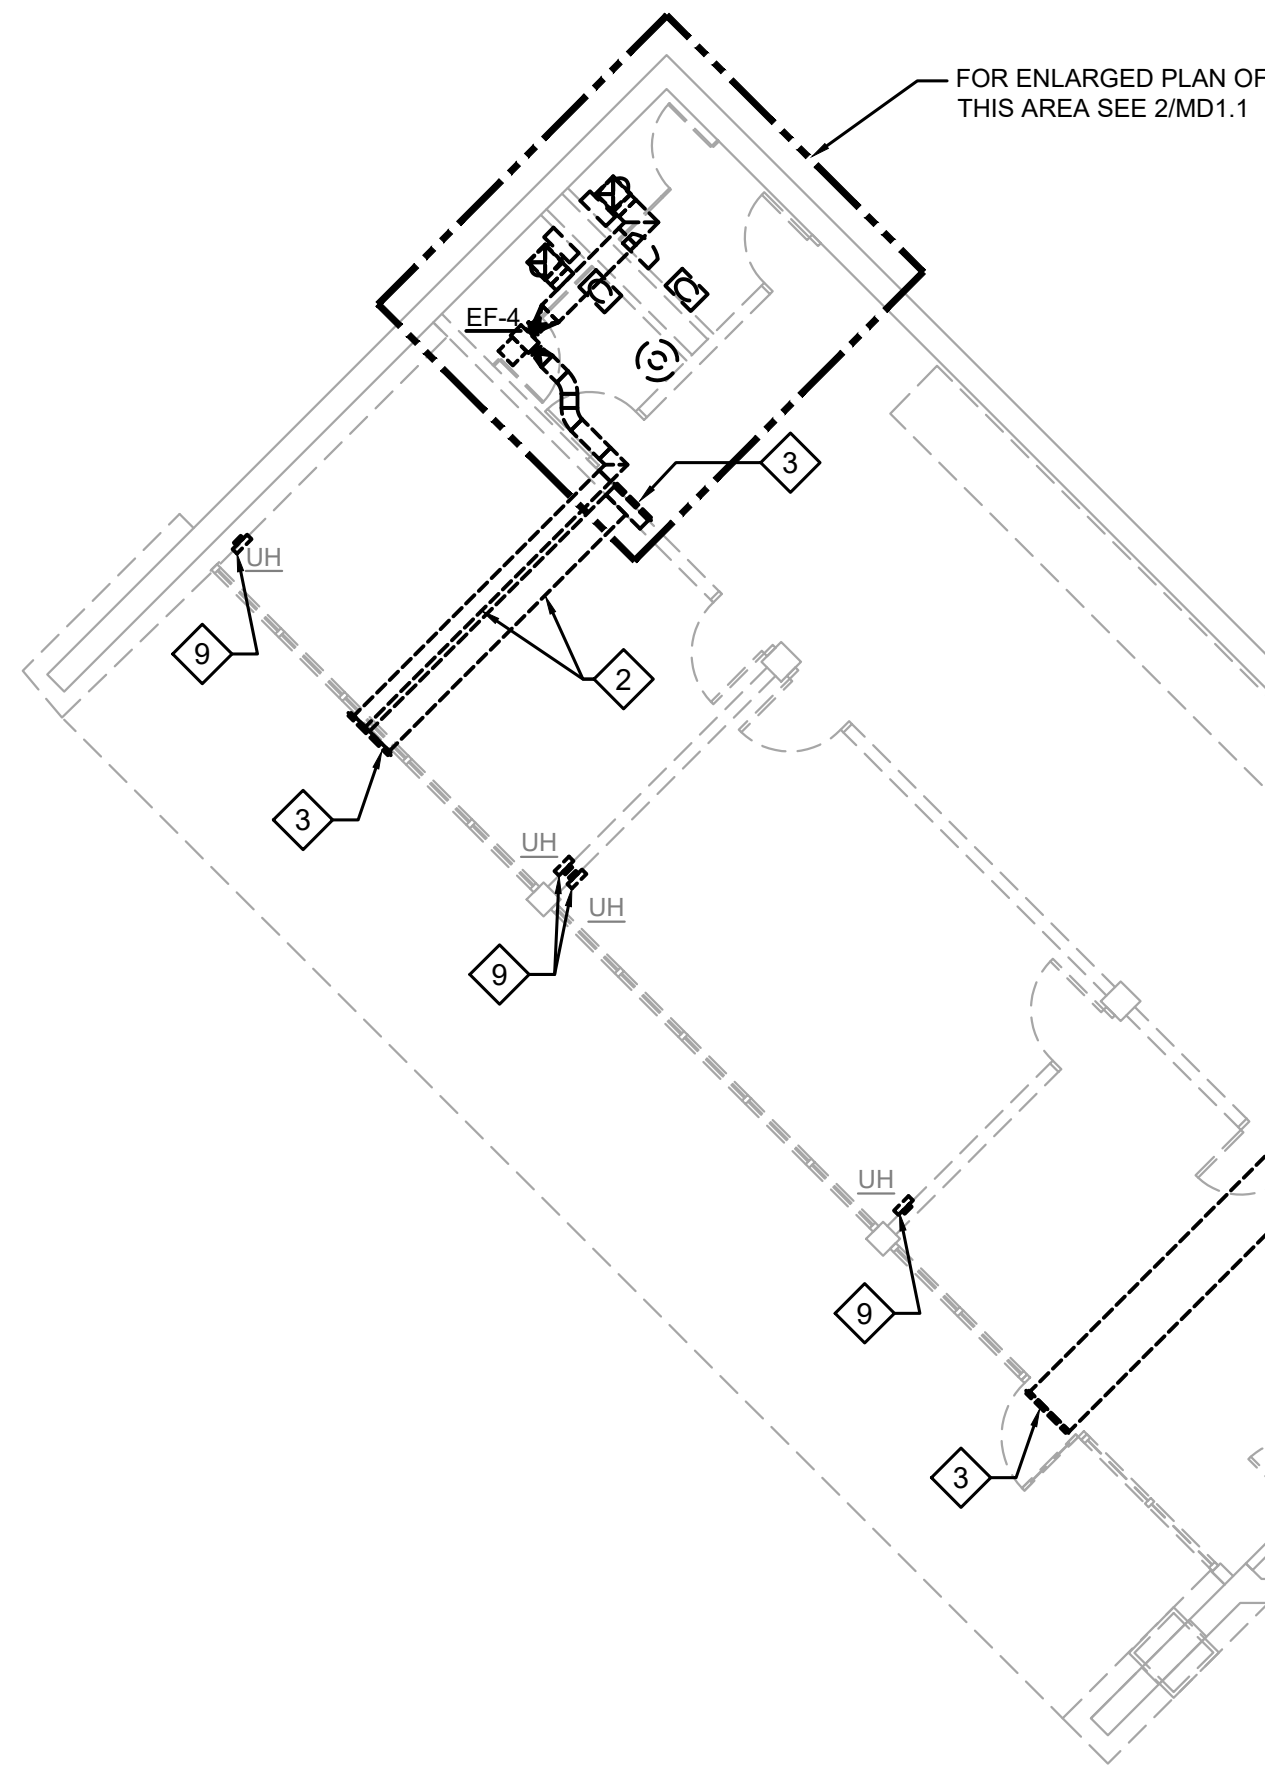
M0.1



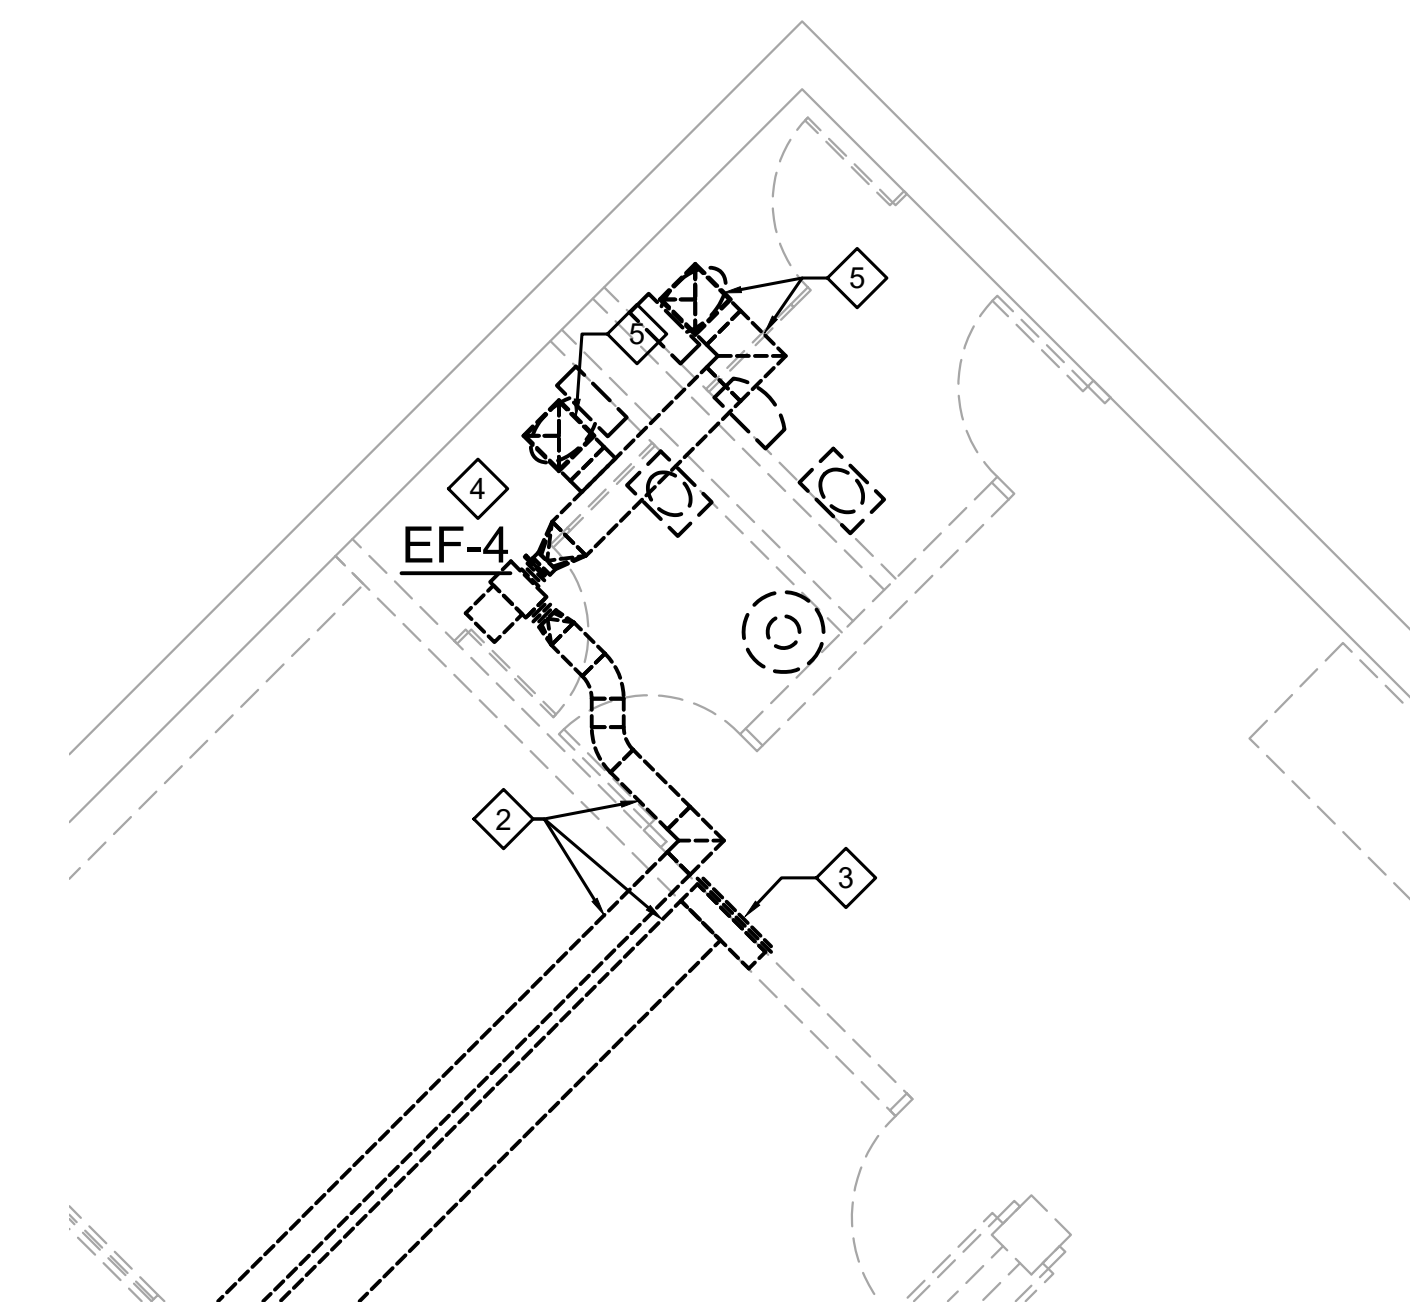1 MECHANICAL HVAC DEMOLITION PLAN
1ST LEVEL



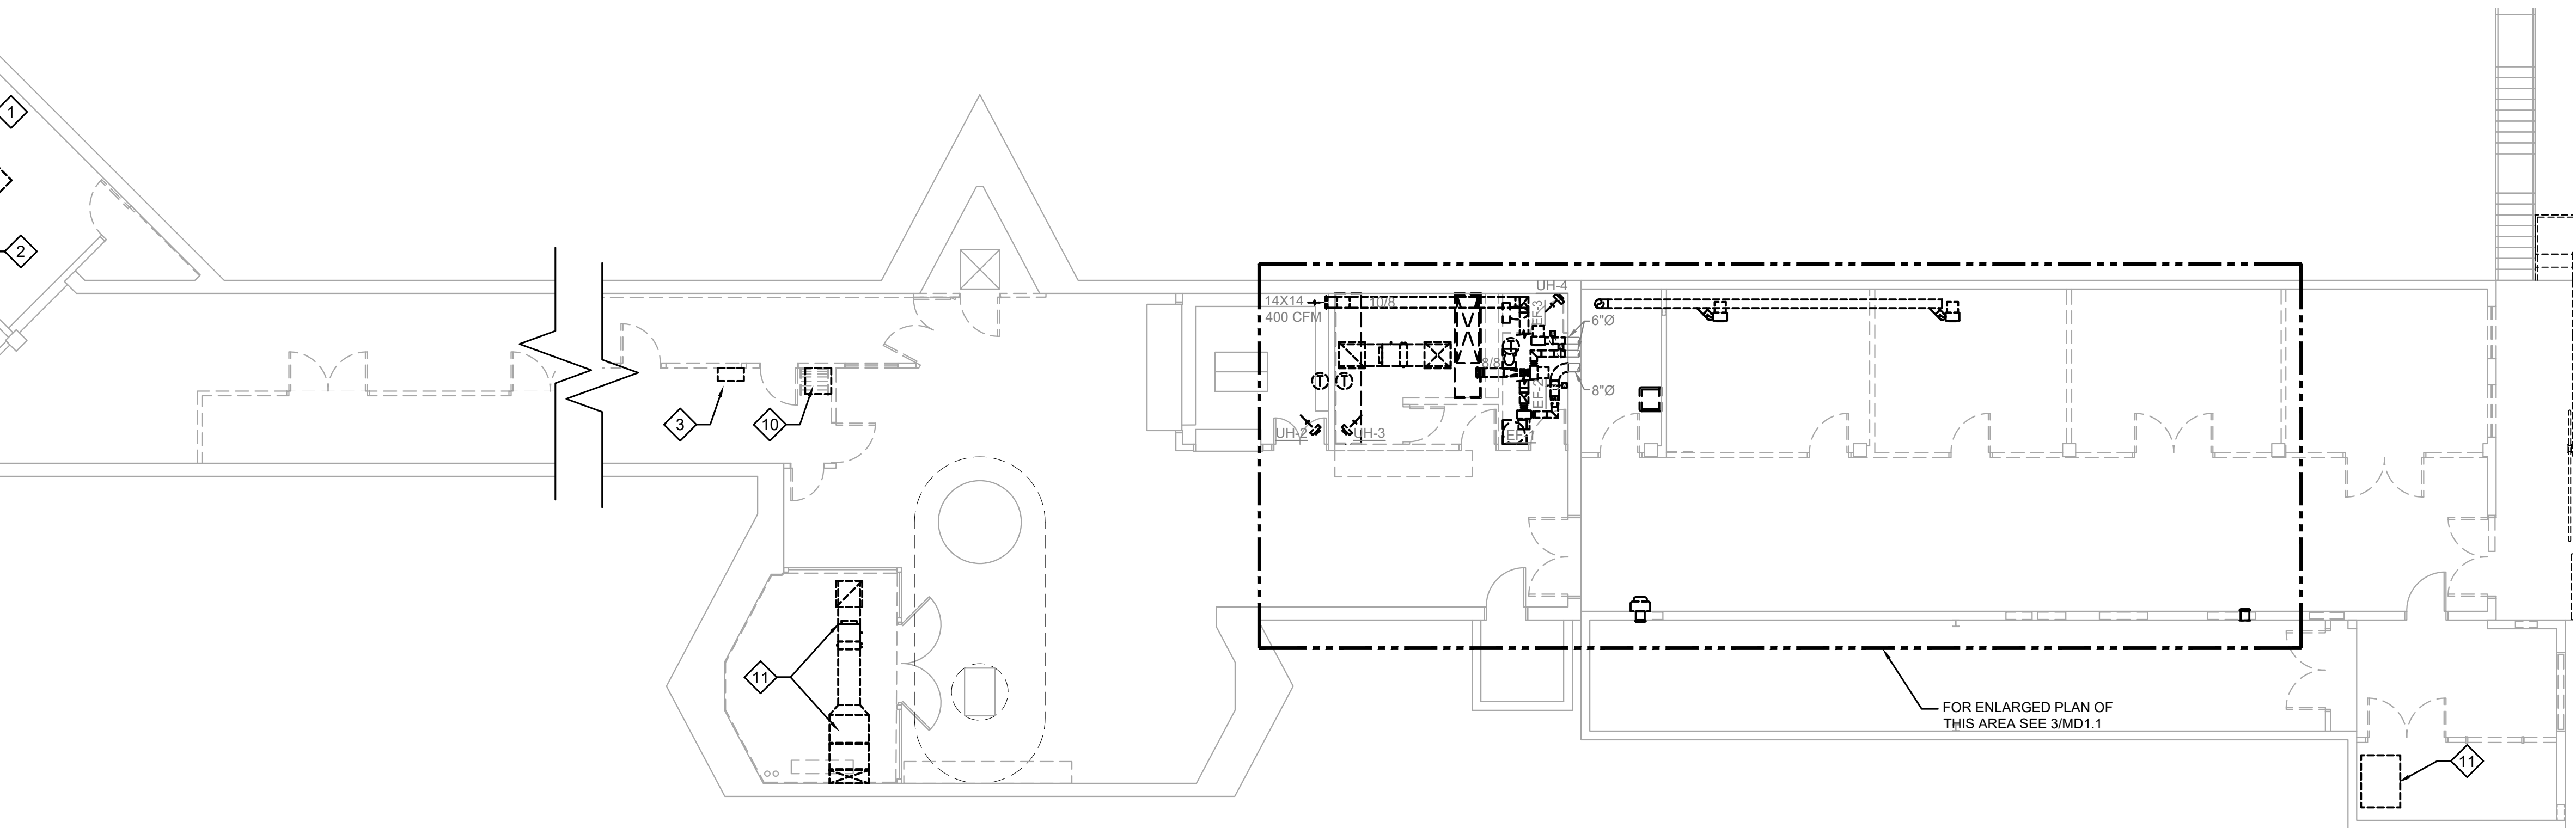2 MECHANICAL HVAC DEMOLITION PLAN
1ST LEVEL





3 MECHANICAL HVAC DEMOLITION PLAN
1ST LEVEL

KEYNOTES:

1. REMOVE EXISTING CEILING MOUNTED AIR CONDITIONER & SUPPORTS.
2. REMOVE EXISTING DUCTWORK, DAMPERS AND SUPPORTS.
3. REMOVE EXISTING LOUVER/ GRILLE.
4. REMOVE EXISTING CEILING MOUNTED EXHAUST FAN & SUPPORTS.
5. REMOVE EXISTING EXHAUST DUCTWORK, GRILLES AND SUPPORTS.
6. EXISTING CEILING EXHAUST FAN AND DISCHARGE DUCT TO BE REMOVED. REMOVE HANGERS, SUPPORTS, AND DUCTWORK COMPLETELY. PATCH AND REPAIR WALL/CEILING PENETRATIONS TO MATCH EXISTING.
7. REMOVE EXISTING THERMOSTAT FOR UNIT.
8. REMOVE EXISTING EXHAUST AIR DUCTWORK AS SHOWN. SEE RENOVATION PLANS FOR NEW ROUTING OF EXHAUST AIR DUCTWORK.
9. EXISTING WALL MOUNTED ELECTRIC UNIT HEATER TO BE REMOVED.
10. EXISTING FLOOR MOUNTED FAN COIL UNIT TO BE REMOVED. REMOVE ALL ASSOCIATED PIPING AND COMPONENTS FROM LOWER LEVEL UP TO ABOVE THE UPPER LEVEL AREA COMPLETELY. ALL ITEMS TO BE REMOVED, ALL PIPING TO BE REMOVED BACK TO MAIN SOURCE.
11. ABOVE CEILING GLYCOL FAN COIL UNIT TO BE REMOVED. REMOVE ALL ASSOCIATED DUCTWORK AND ALL PIPING. REMOVE ALL ITEMS COMPLETELY AND DO NOT ABANDON ANY DUCTWORK OR PIPING.
12. EXISTING SUSPENDED ELECTRIC UNIT HEATER TO BE REMOVED. REMOVE EQUIPMENT, HANGERS AND SUPPORTS, WIRING AND CONDUIT.
13. EXISTING EXHAUST FAN, SLEEVE THROUGH WALL AND GRILLE TO BE REMOVE. OPENING IN WALL TO REMAIN AND BE ENLARGED, SEE RENOVATION DOCUMENTS.
14. REMOVE EXISTING GRILLE AND SLEEVE THROUGH WALL. EXISTING WALL OPENING TO BE CLOSED. SEE ARCHITECTURAL AND STRUCTURAL RENOVATION DOCUMENTS FOR INFORMATION. COORDINATE WORK WITH ARCHITECTURAL AND STRUCTURAL.



GENERAL NOTES:

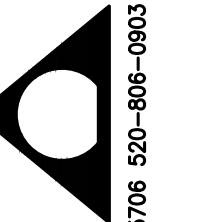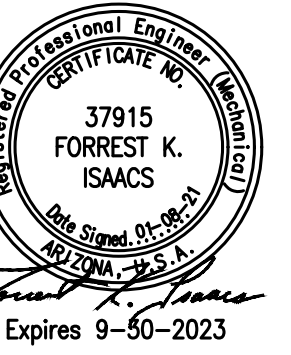REFER TO SHEET M0.0 AND THE ENTIRE SET FOR ADDITIONAL INFORMATION AND REQUIREMENTS. COORDINATE ALL WORK WITH ARCHITECTURAL & ELECTRICAL DRAWINGS.
CONTRACTOR SHALL PROTECT ALL EXISTING EQUIPMENT AND VIEWING PORTALS IN PLACE.



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WINDOWS ON
THE UNIVERSE
CENTER FOR
ASTRONOMY
OUTREACH

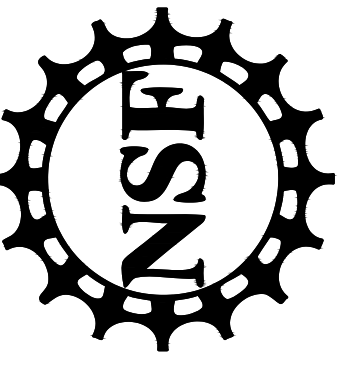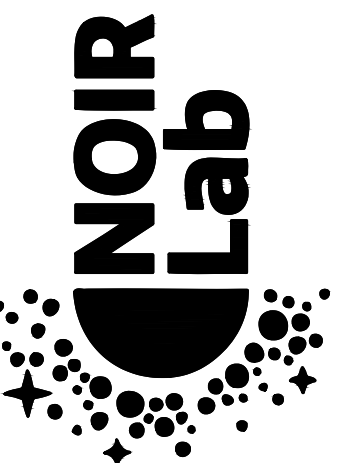


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△	DATE	DESCRIPTION
0	01/08/21	I.F.C.

PROJECT NUMBER: 11904.00
DRAWN BY: FI
CHECKED BY: FI
CAD FILE: 11904.00-MD1.1
SCALE: AS SHOWN

MECHANICAL
HVAC
DEMOLITION PLANS

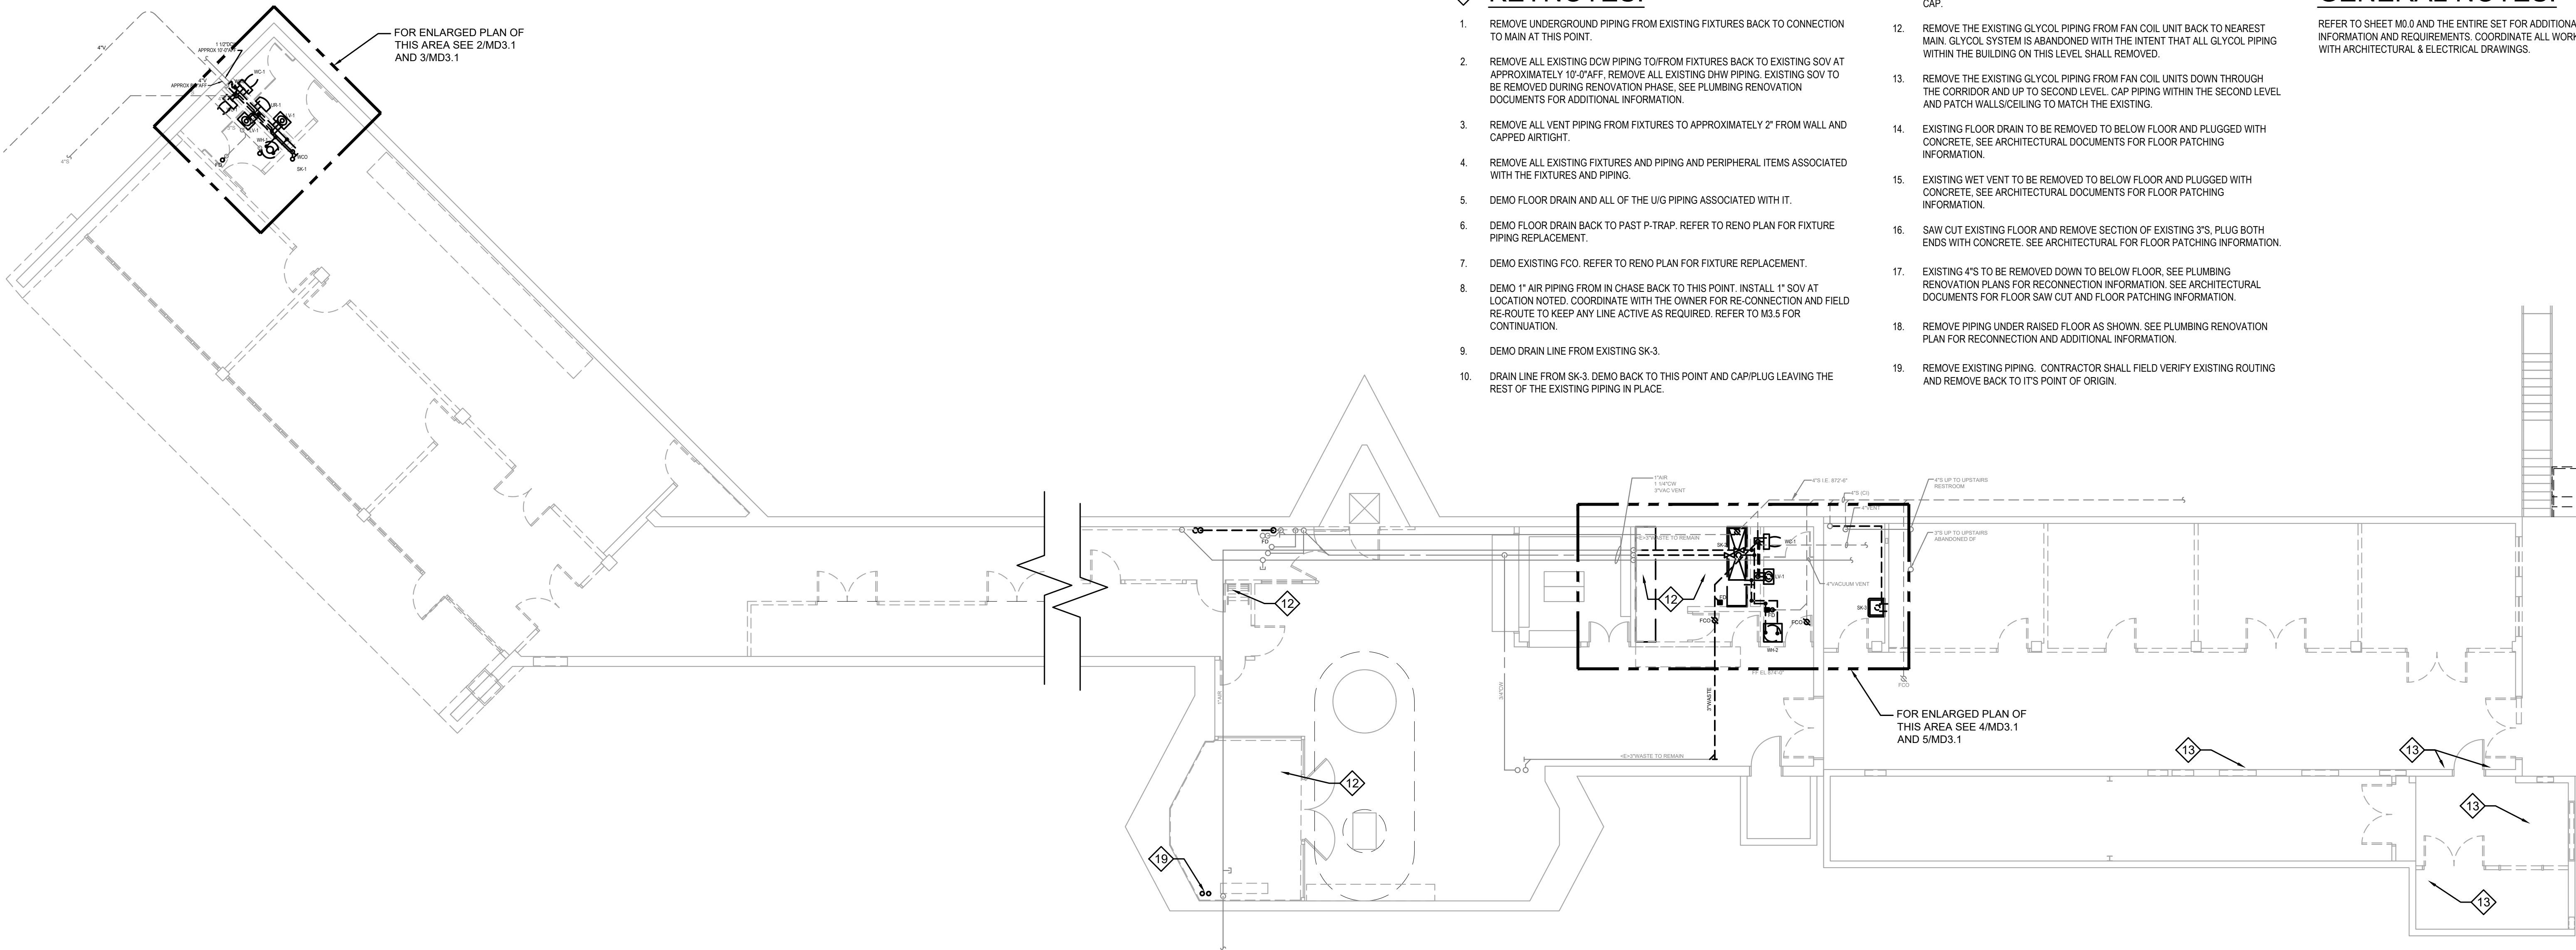MD1.1





KEYNOTES:

1. REMOVE UNDERGROUND PIPING FROM EXISTING FIXTURES BACK TO CONNECTION TO MAIN AT THIS POINT.
2. REMOVE ALL EXISTING DOW PIPING TO/FROM FIXTURES BACK TO EXISTING SOV AT APPROXIMATELY 10'-0" AFF. REMOVE ALL EXISTING DHW PIPING. EXISTING SOV TO BE REMOVED DURING RENOVATION PHASE. SEE PLUMBING RENOVATION DOCUMENTS FOR ADDITIONAL INFORMATION.
3. REMOVE ALL VENT PIPING FROM FIXTURES TO APPROXIMATELY 2' FROM WALL AND CAPPED AIRTIGHT.
4. REMOVE ALL EXISTING FIXTURES AND PIPING AND PERIPHERAL ITEMS ASSOCIATED WITH THE FIXTURES AND PIPING.
5. DEMO FLOOR DRAIN AND ALL OF THE U/G PIPING ASSOCIATED WITH IT.
6. DEMO FLOOR DRAIN BACK TO PAST P-TRAP. REFER TO RENO PLAN FOR FIXTURE PIPING REPLACEMENT.
7. DEMO EXISTING FCO. REFER TO RENO PLAN FOR FIXTURE REPLACEMENT.
8. DEMO 1" AIR PIPING FROM IN CHASE BACK TO THIS POINT. INSTALL 1" SOV AT LOCATION NOTED. COORDINATE WITH THE OWNER FOR RE-CONNECTION AND FIELD RE-ROUTE TO KEEP ANY LINE ACTIVE AS REQUIRED. REFER TO M3.5 FOR CONTINUATION.
9. DEMO DRAIN LINE FROM EXISTING SK-3.
10. DRAIN LINE FROM SK-3. DEMO BACK TO THIS POINT AND CAPP/PLUG LEAVING THE REST OF THE EXISTING PIPING IN PLACE.
11. DEMO CW AND HW LINES FROM SK-3 BACK TO NEAREST POINT OF ACCESS AND CAP.
12. REMOVE THE EXISTING GLYCOL PIPING FROM FAN COIL UNIT BACK TO NEAREST MAIN GLYCOL SYSTEM IS ABANDONED WITH THE INTENT THAT ALL GLYCOL PIPING WITHIN THE BUILDING ON THIS LEVEL SHALL BE REMOVED.
13. REMOVE THE EXISTING GLYCOL PIPING FROM FAN COIL UNITS DOWN THROUGH THE CORRIDOR AND UP TO SECOND LEVEL. CAP PIPING WITHIN THE SECOND LEVEL AND PATCH WALLS/CEILING TO MATCH THE EXISTING.
14. EXISTING FLOOR DRAIN TO BE REMOVED TO BELOW FLOOR AND PLUGGED WITH CONCRETE. SEE ARCHITECTURAL DOCUMENTS FOR FLOOR PATCHING INFORMATION.
15. EXISTING WET VENT TO BE REMOVED TO BELOW FLOOR AND PLUGGED WITH CONCRETE. SEE ARCHITECTURAL DOCUMENTS FOR FLOOR PATCHING INFORMATION.
16. SAW CUT EXISTING FLOOR AND REMOVE SECTION OF EXISTING 3'S. PLUG BOTH ENDS WITH CONCRETE. SEE ARCHITECTURAL FOR FLOOR PATCHING INFORMATION.
17. EXISTING 4'S TO BE REMOVED DOWN TO BELOW FLOOR. SEE PLUMBING RENOVATION PLANS FOR RECONNECTION INFORMATION. SEE ARCHITECTURAL DOCUMENTS FOR FLOOR SAW CUT AND FLOOR PATCHING INFORMATION.
18. REMOVE PIPING UNDER RAISED FLOOR AS SHOWN. SEE PLUMBING RENOVATION PLAN FOR RECONNECTION AND ADDITIONAL INFORMATION.
19. REMOVE EXISTING PIPING. CONTRACTOR SHALL FIELD VERIFY EXISTING ROUTING AND REMOVE BACK TO ITS POINT OF ORIGIN.

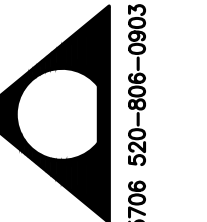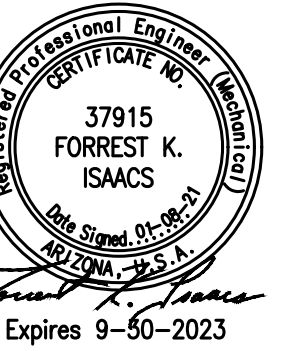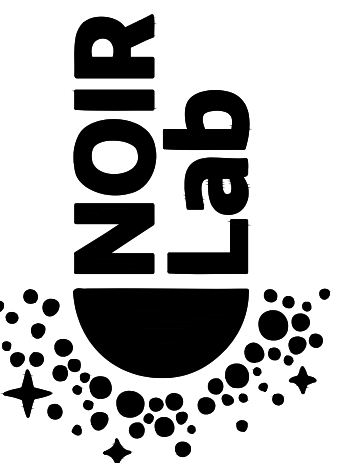
GENERAL NOTES:

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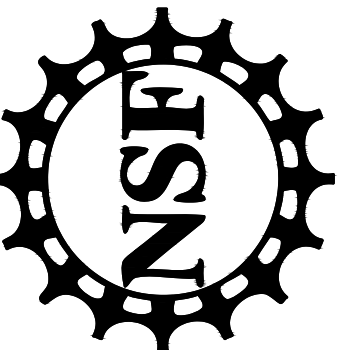


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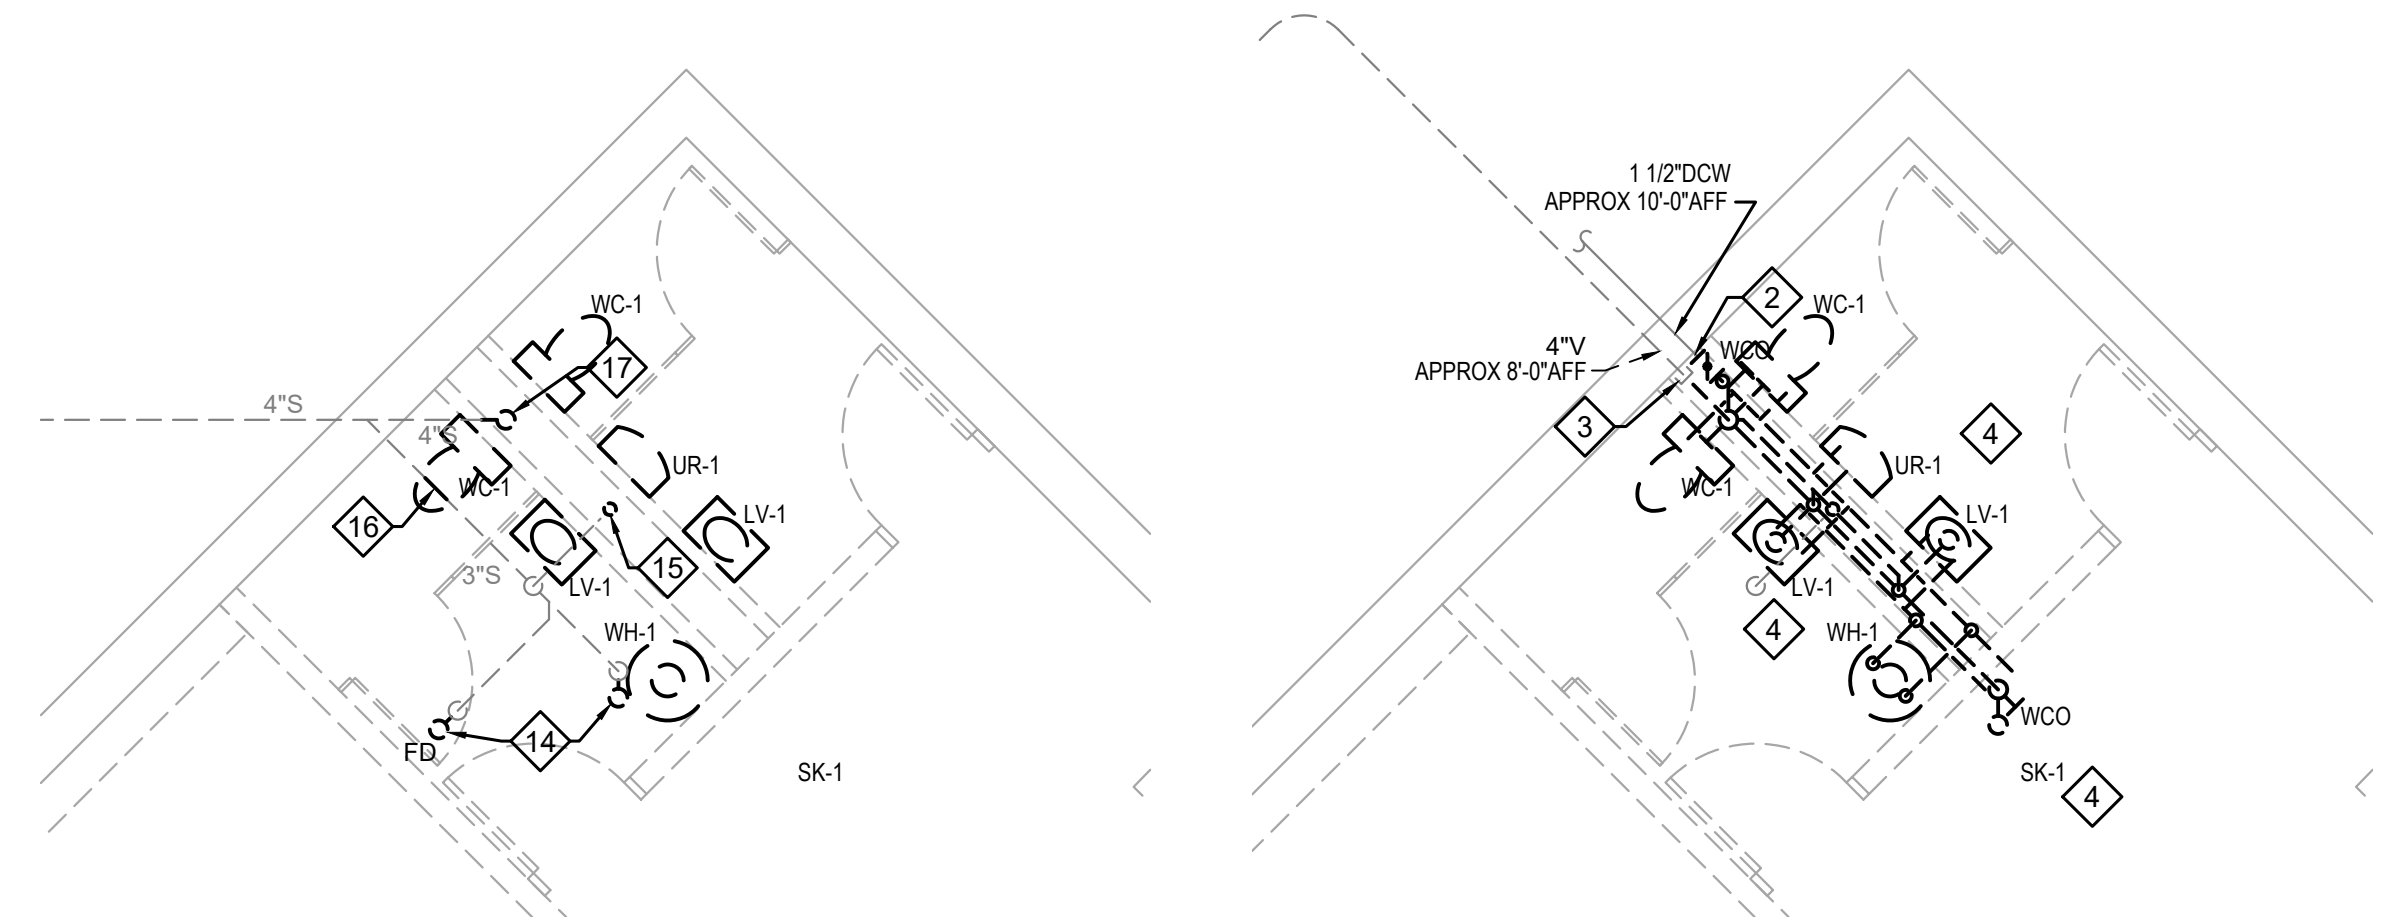


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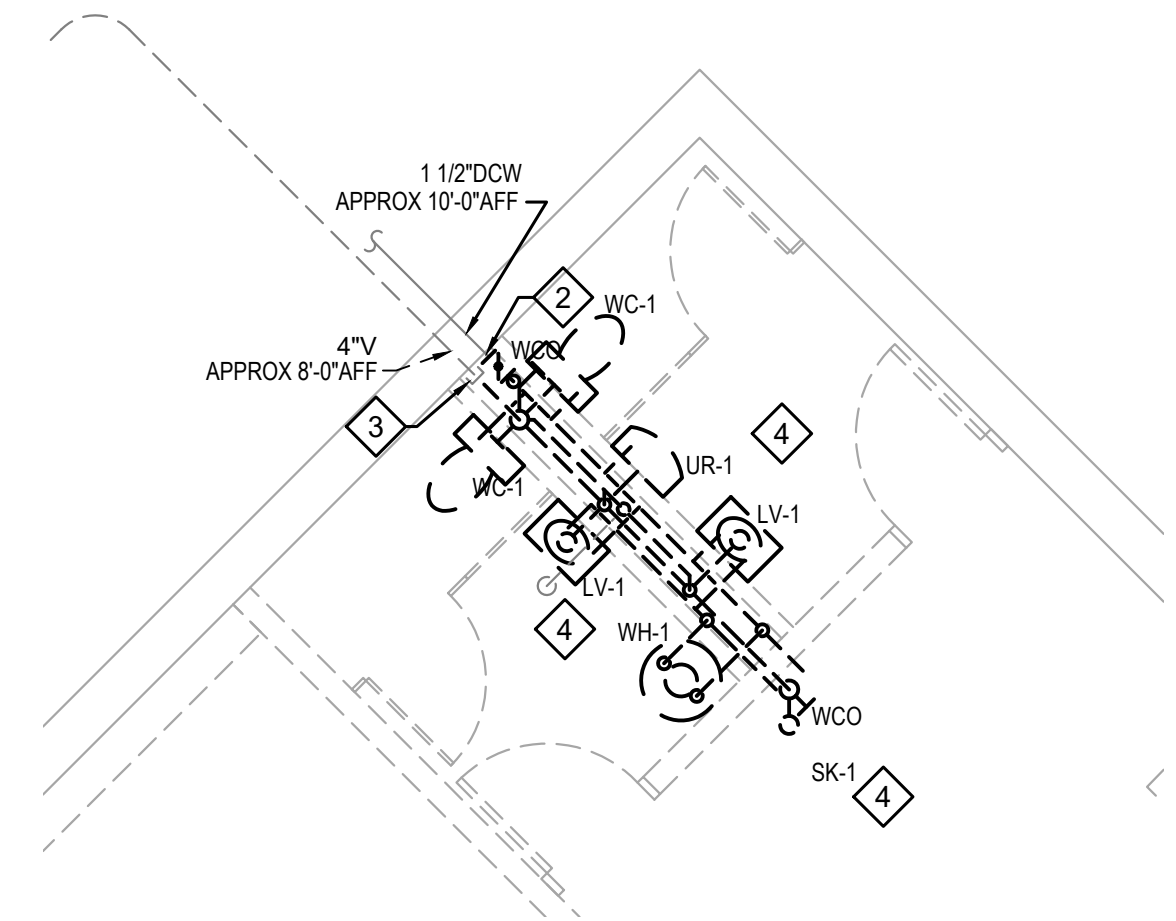


1 MECHANICAL PLUMBING DEMOLITION PLAN
1ST LEVEL

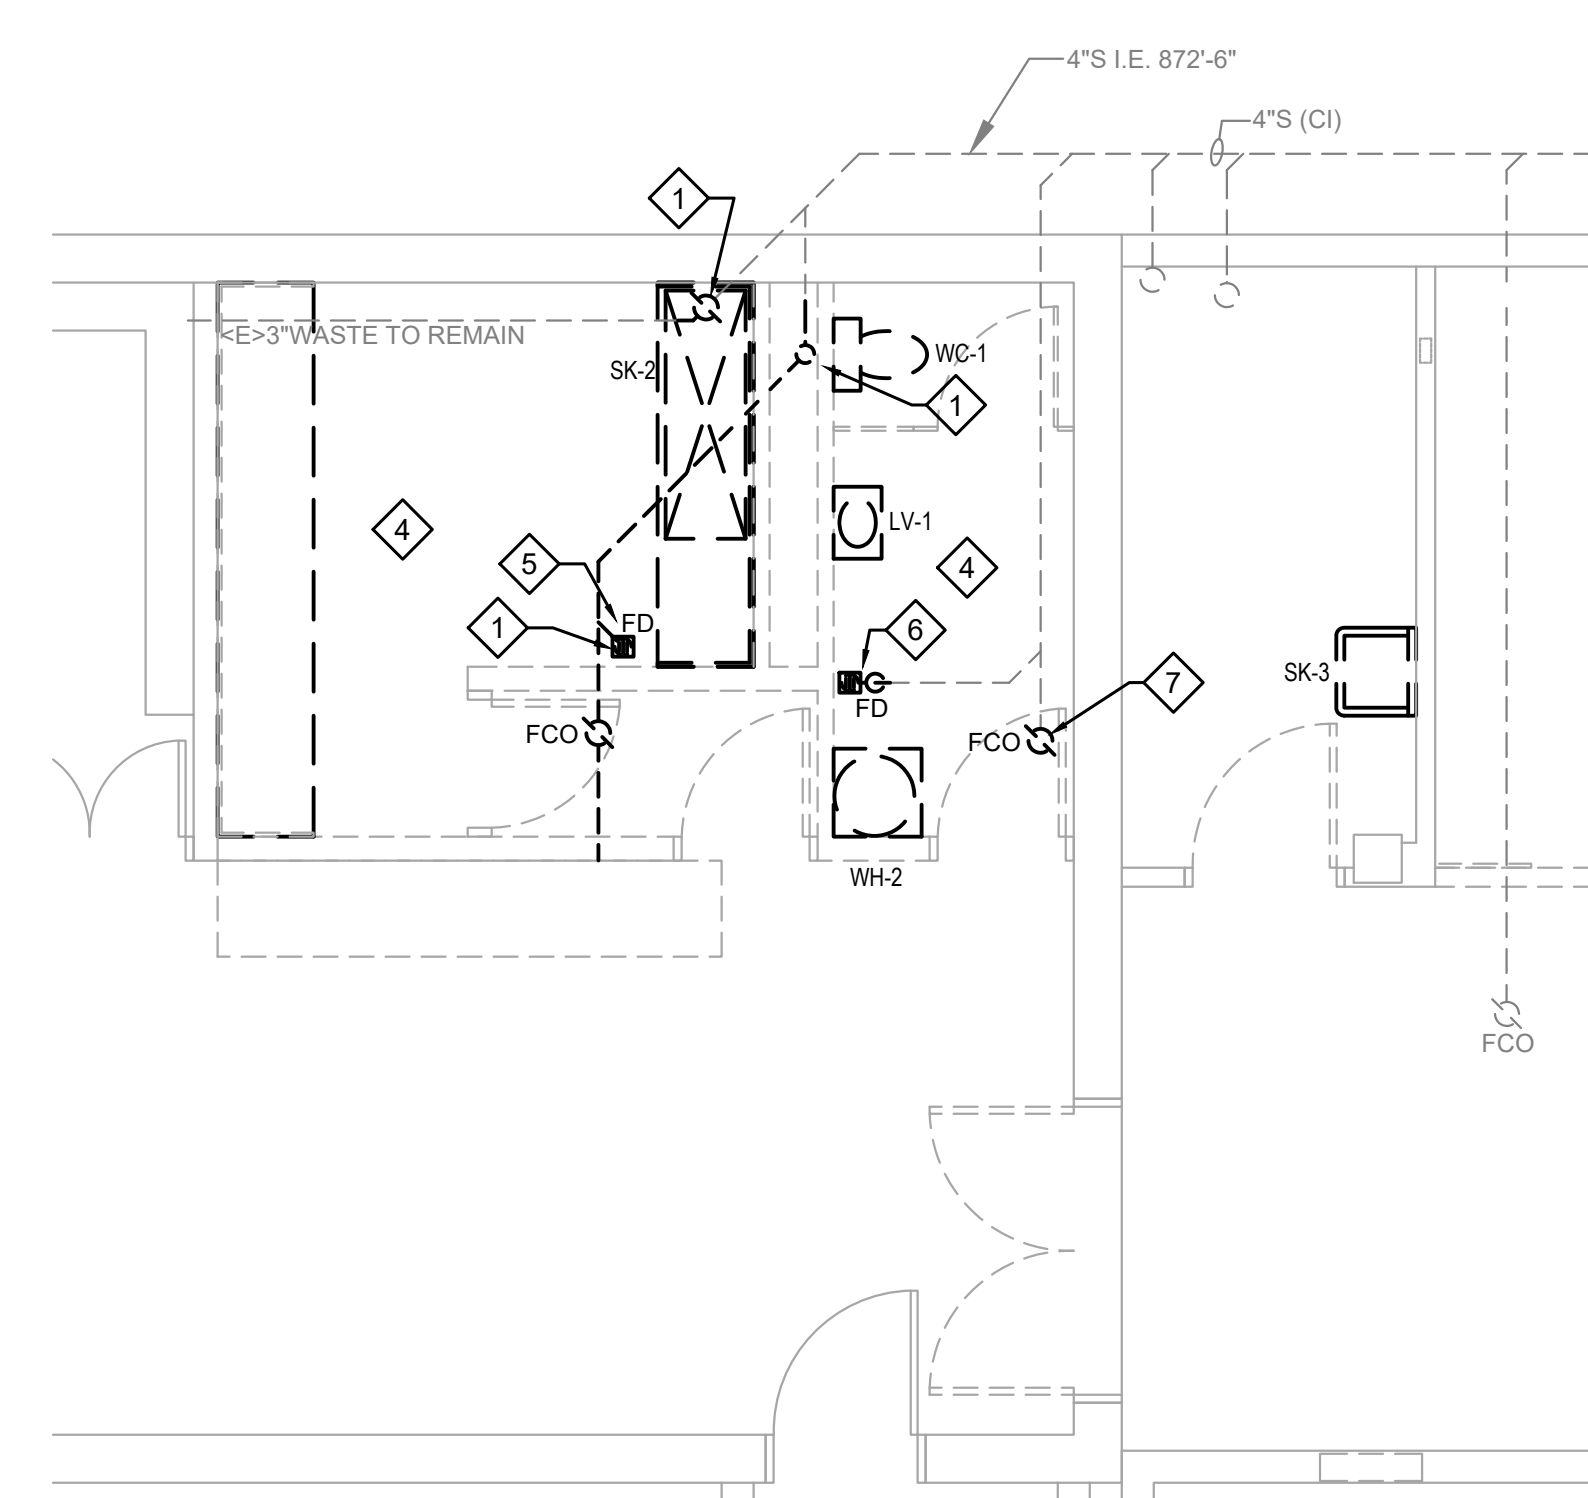
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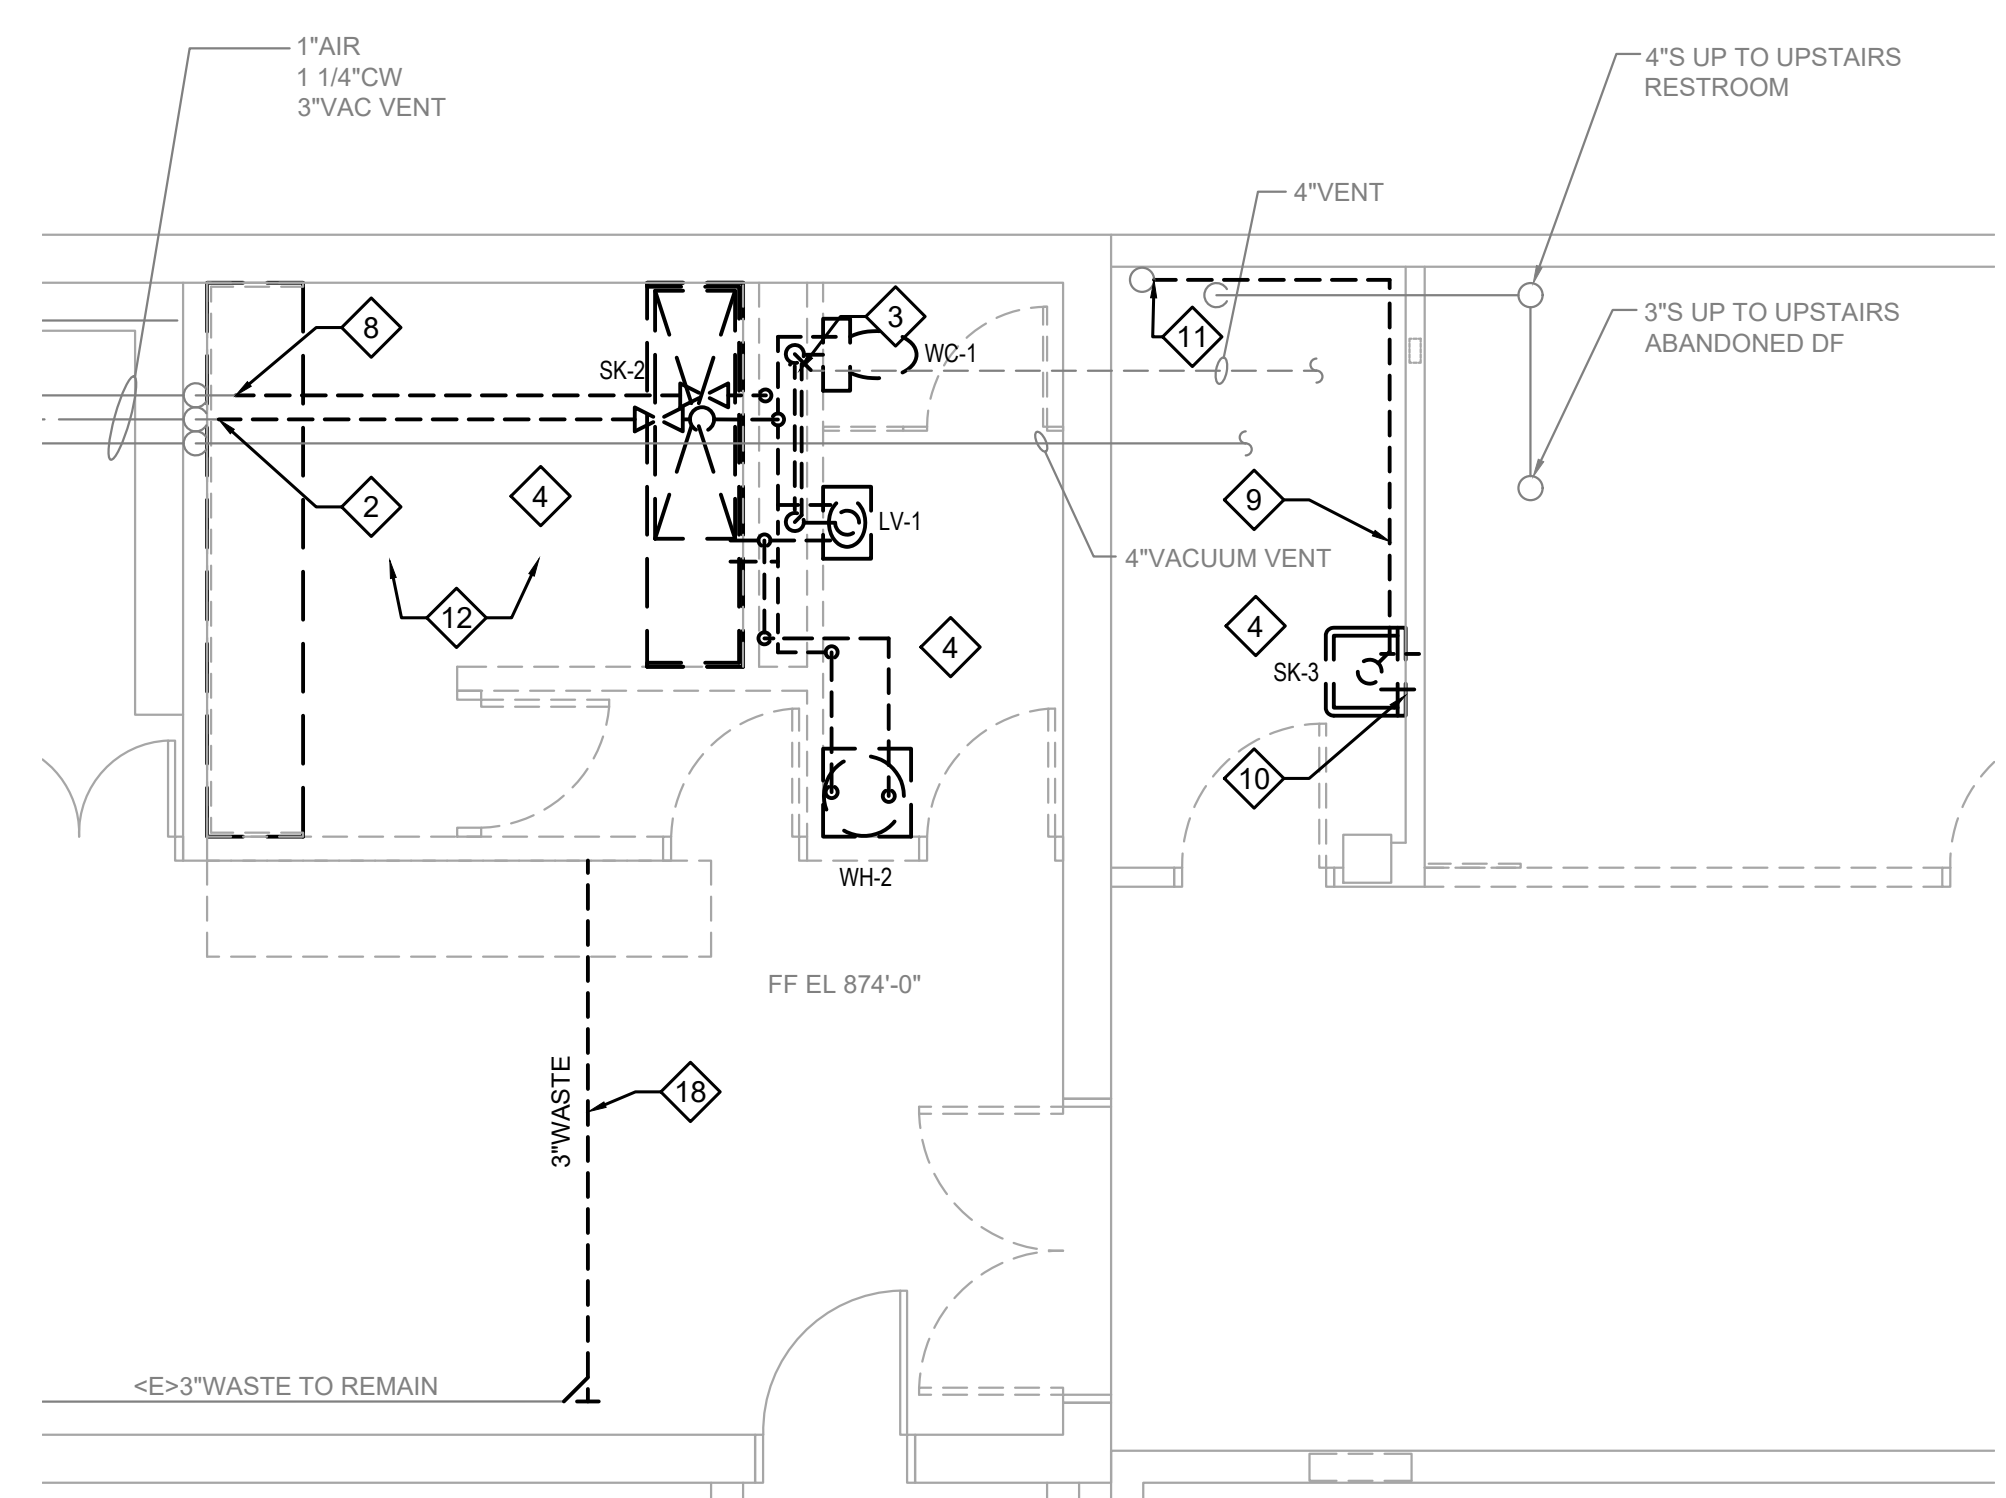
2 MECHANICAL PLUMBING DEMOLITION PLAN
1ST LEVEL - SLAB AND BELOW



3 MECHANICAL PLUMBING DEMOLITION PLAN
1ST LEVEL - SLAB AND ABOVE



4 MECHANICAL PLUMBING DEMOLITION PLAN
1ST LEVEL - SLAB AND BELOW



5 MECHANICAL PLUMBING DEMOLITION PLAN
1ST LEVEL - SLAB AND ABOVE

DATE	DESCRIPTION
01/08/21	I.F.C.

PROJECT NUMBER: 11904.00
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MECHANICAL
PLUMBING
DEMOLITION PLANS


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GENERAL NOTES:

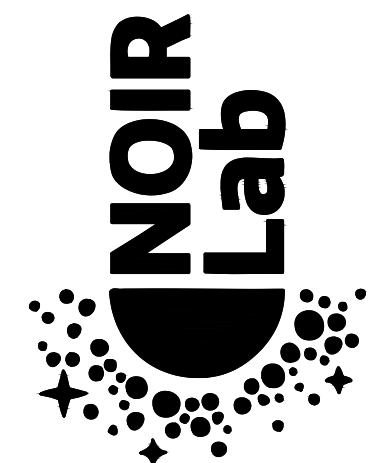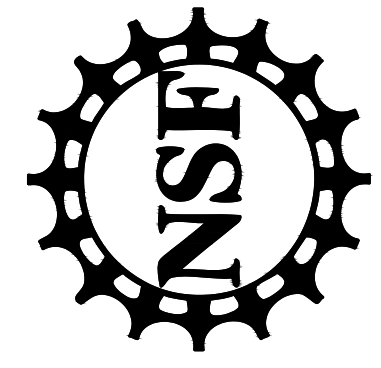
REFER TO SHEET M0.0 AND THE ENTIRE SET FOR ADDITIONAL INFORMATION AND REQUIREMENTS.
COORDINATE ALL WORK WITH ARCHITECTURAL & ELECTRICAL DRAWINGS.



WINDOWS ON
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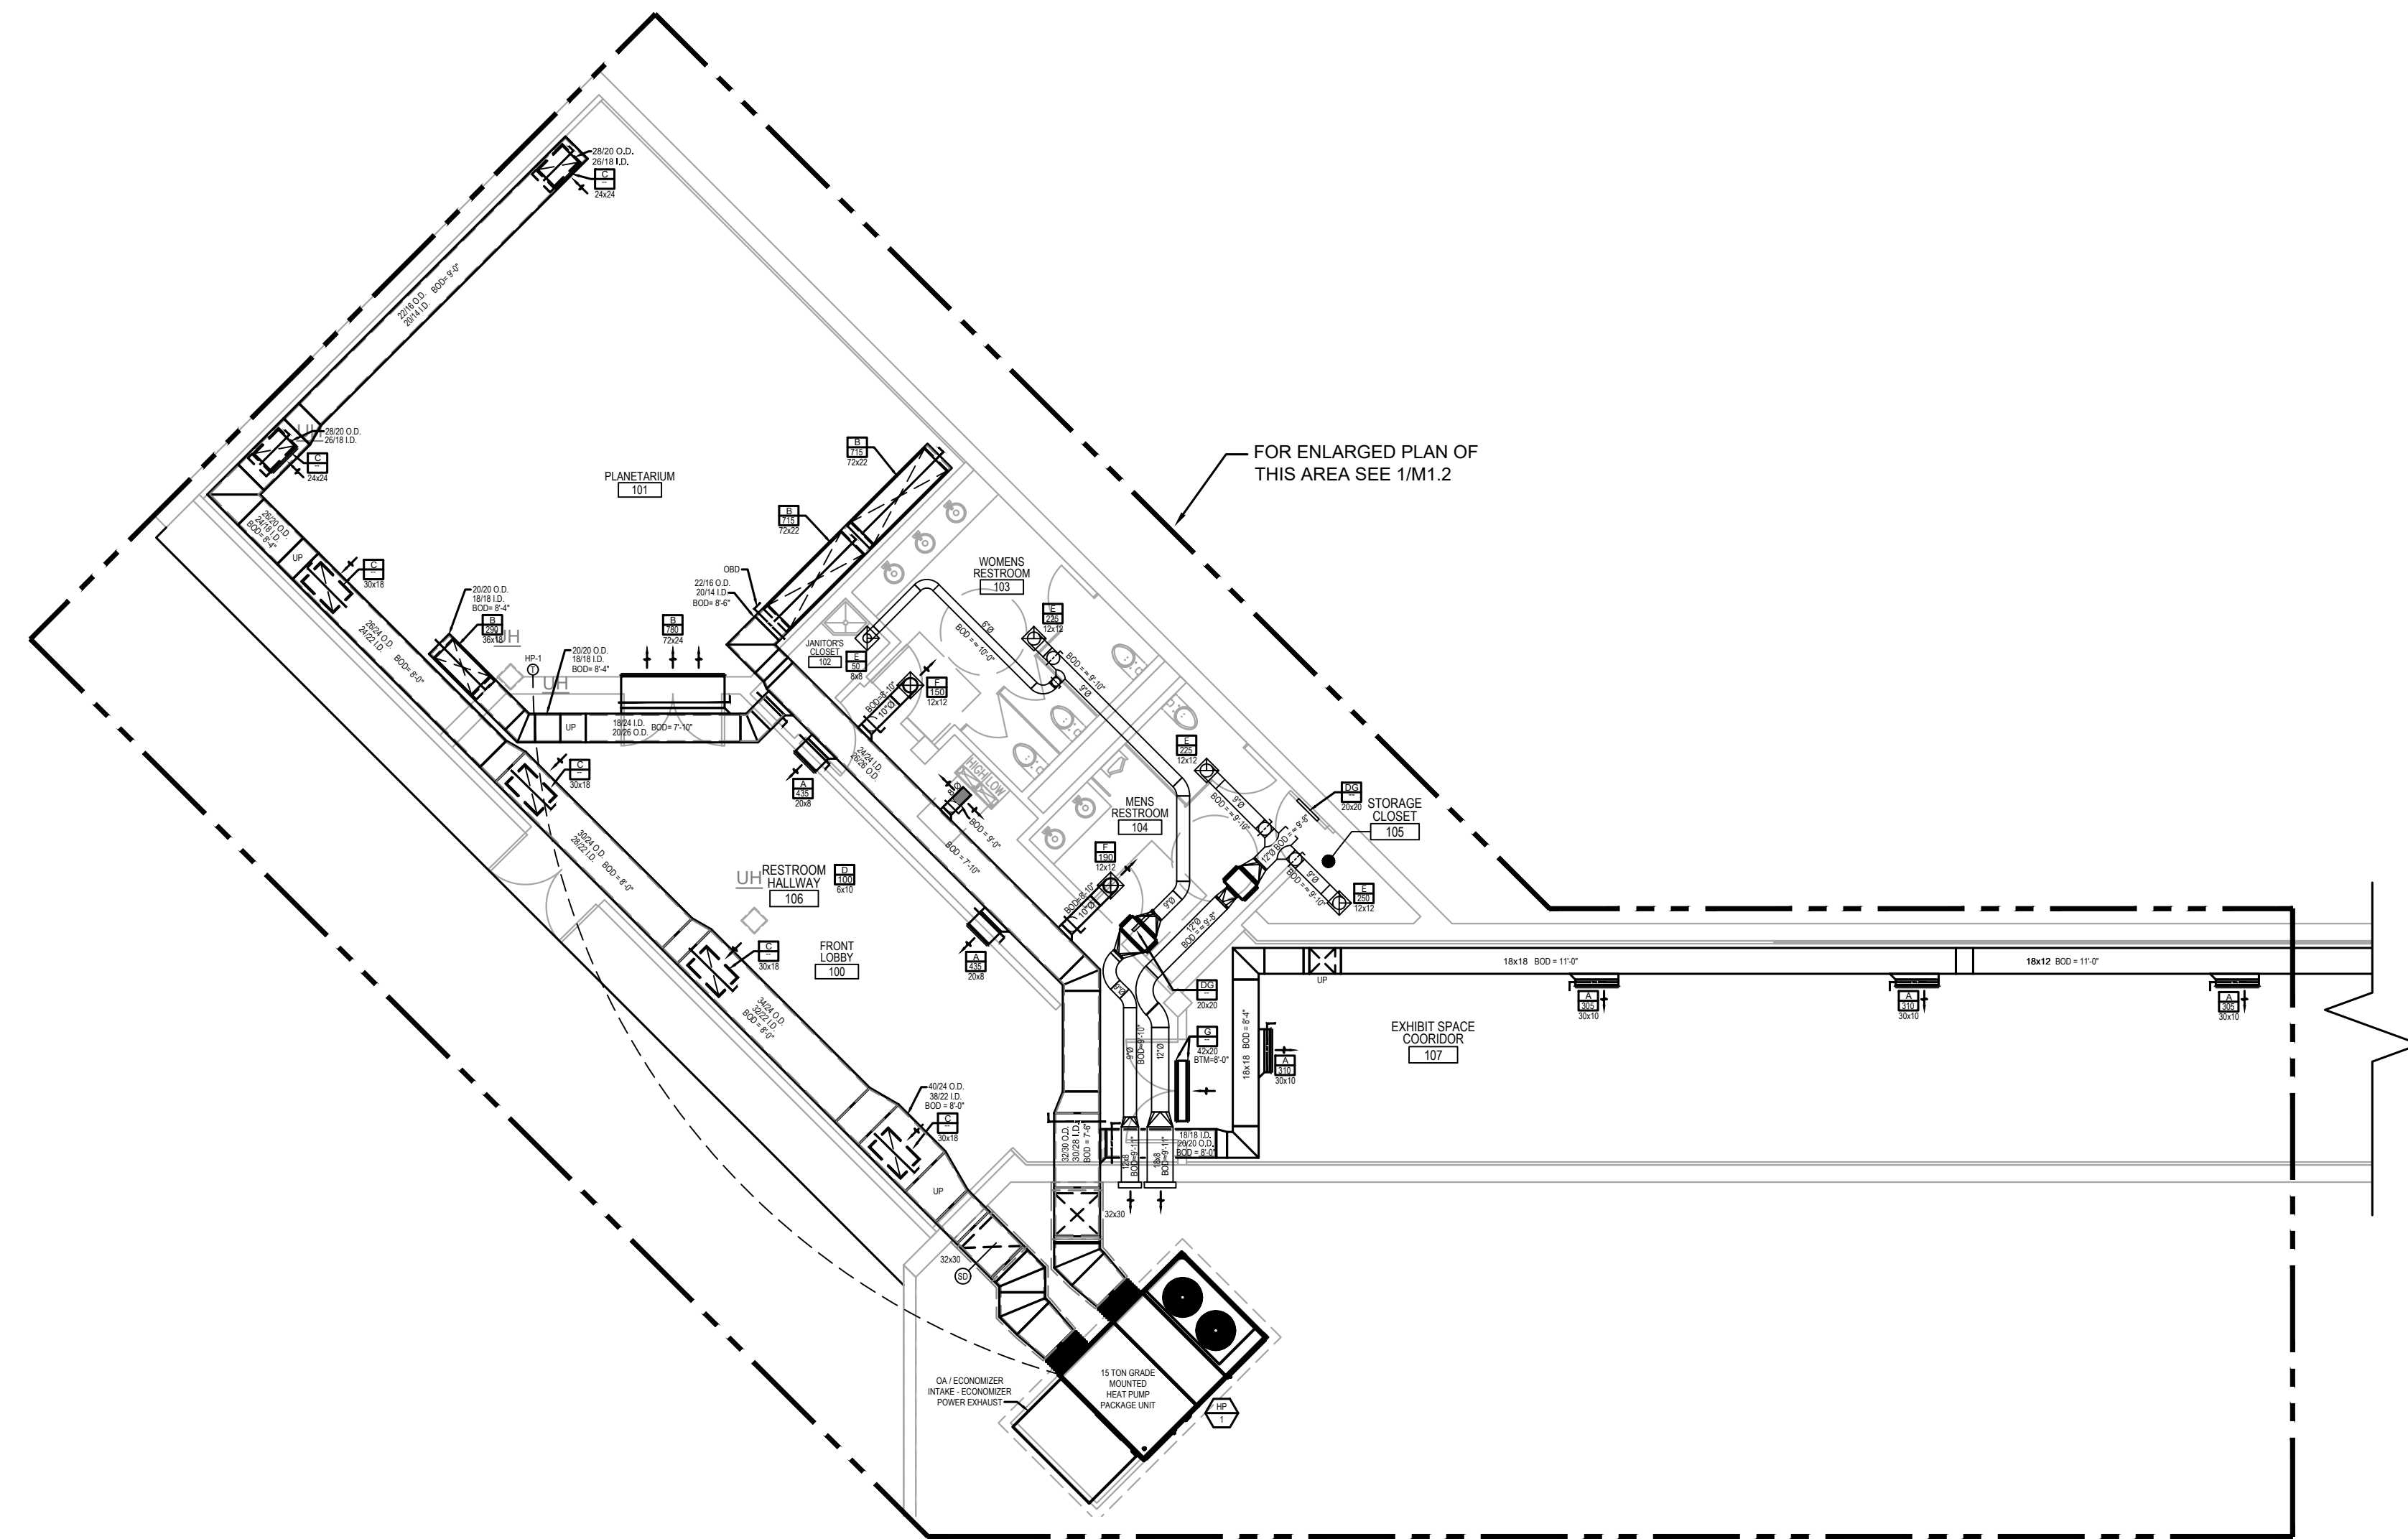


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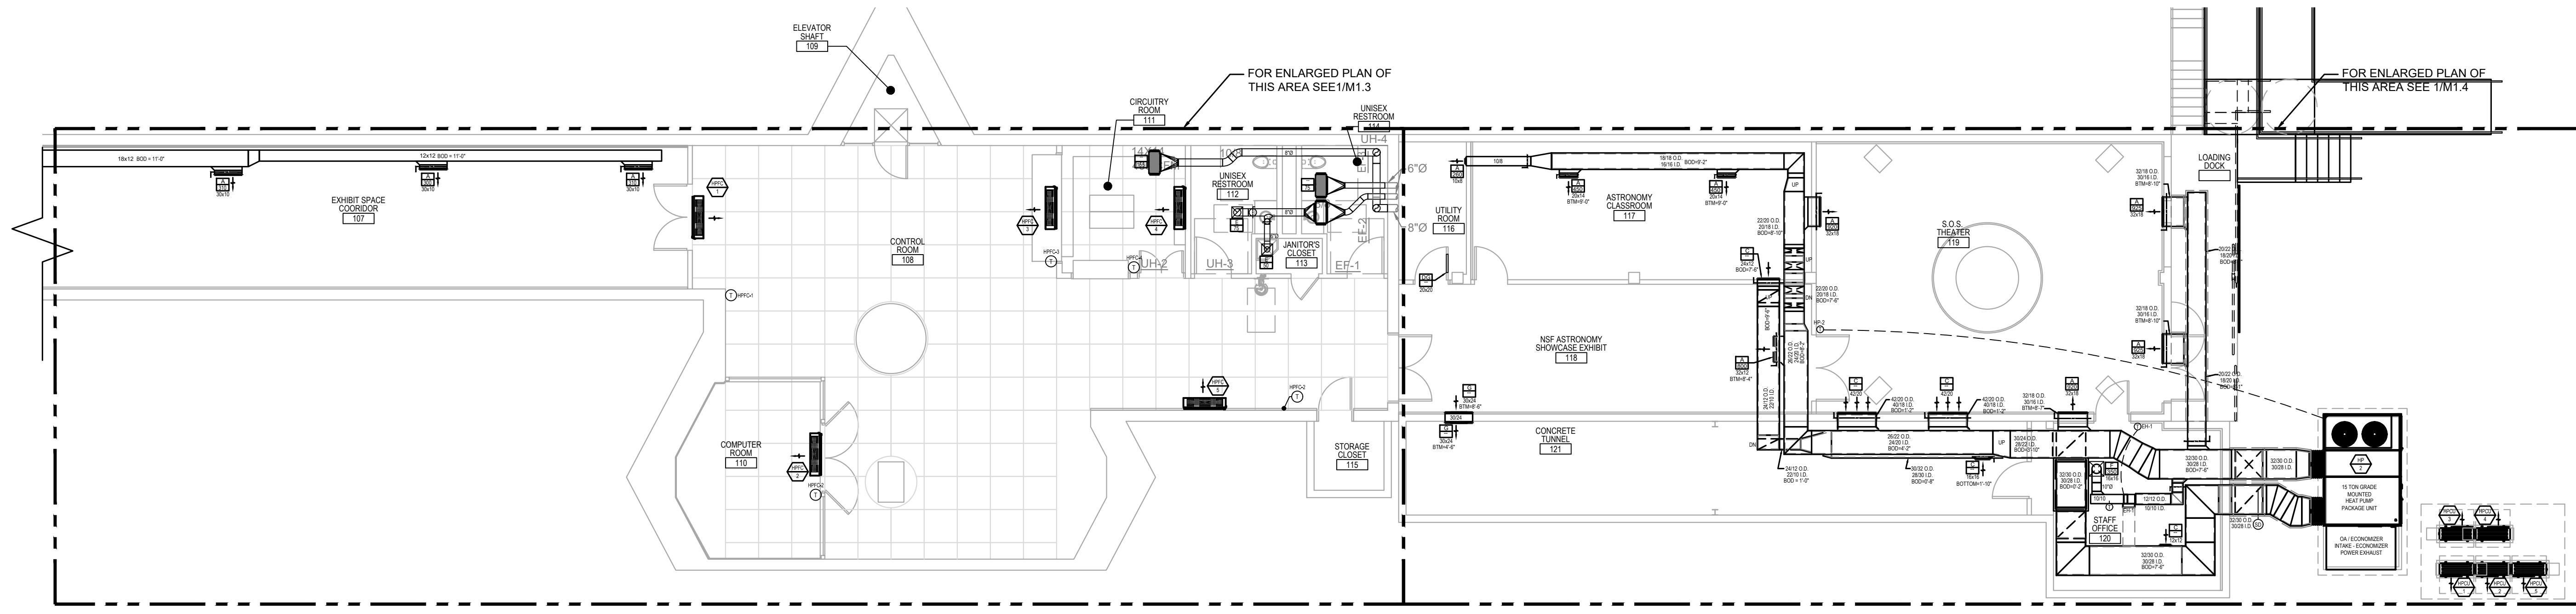
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MECHANICAL
HVAC
RENOVATION PLANS

M1.1



FOR ENLARGED PLAN OF THIS AREA SEE 1/M1.2



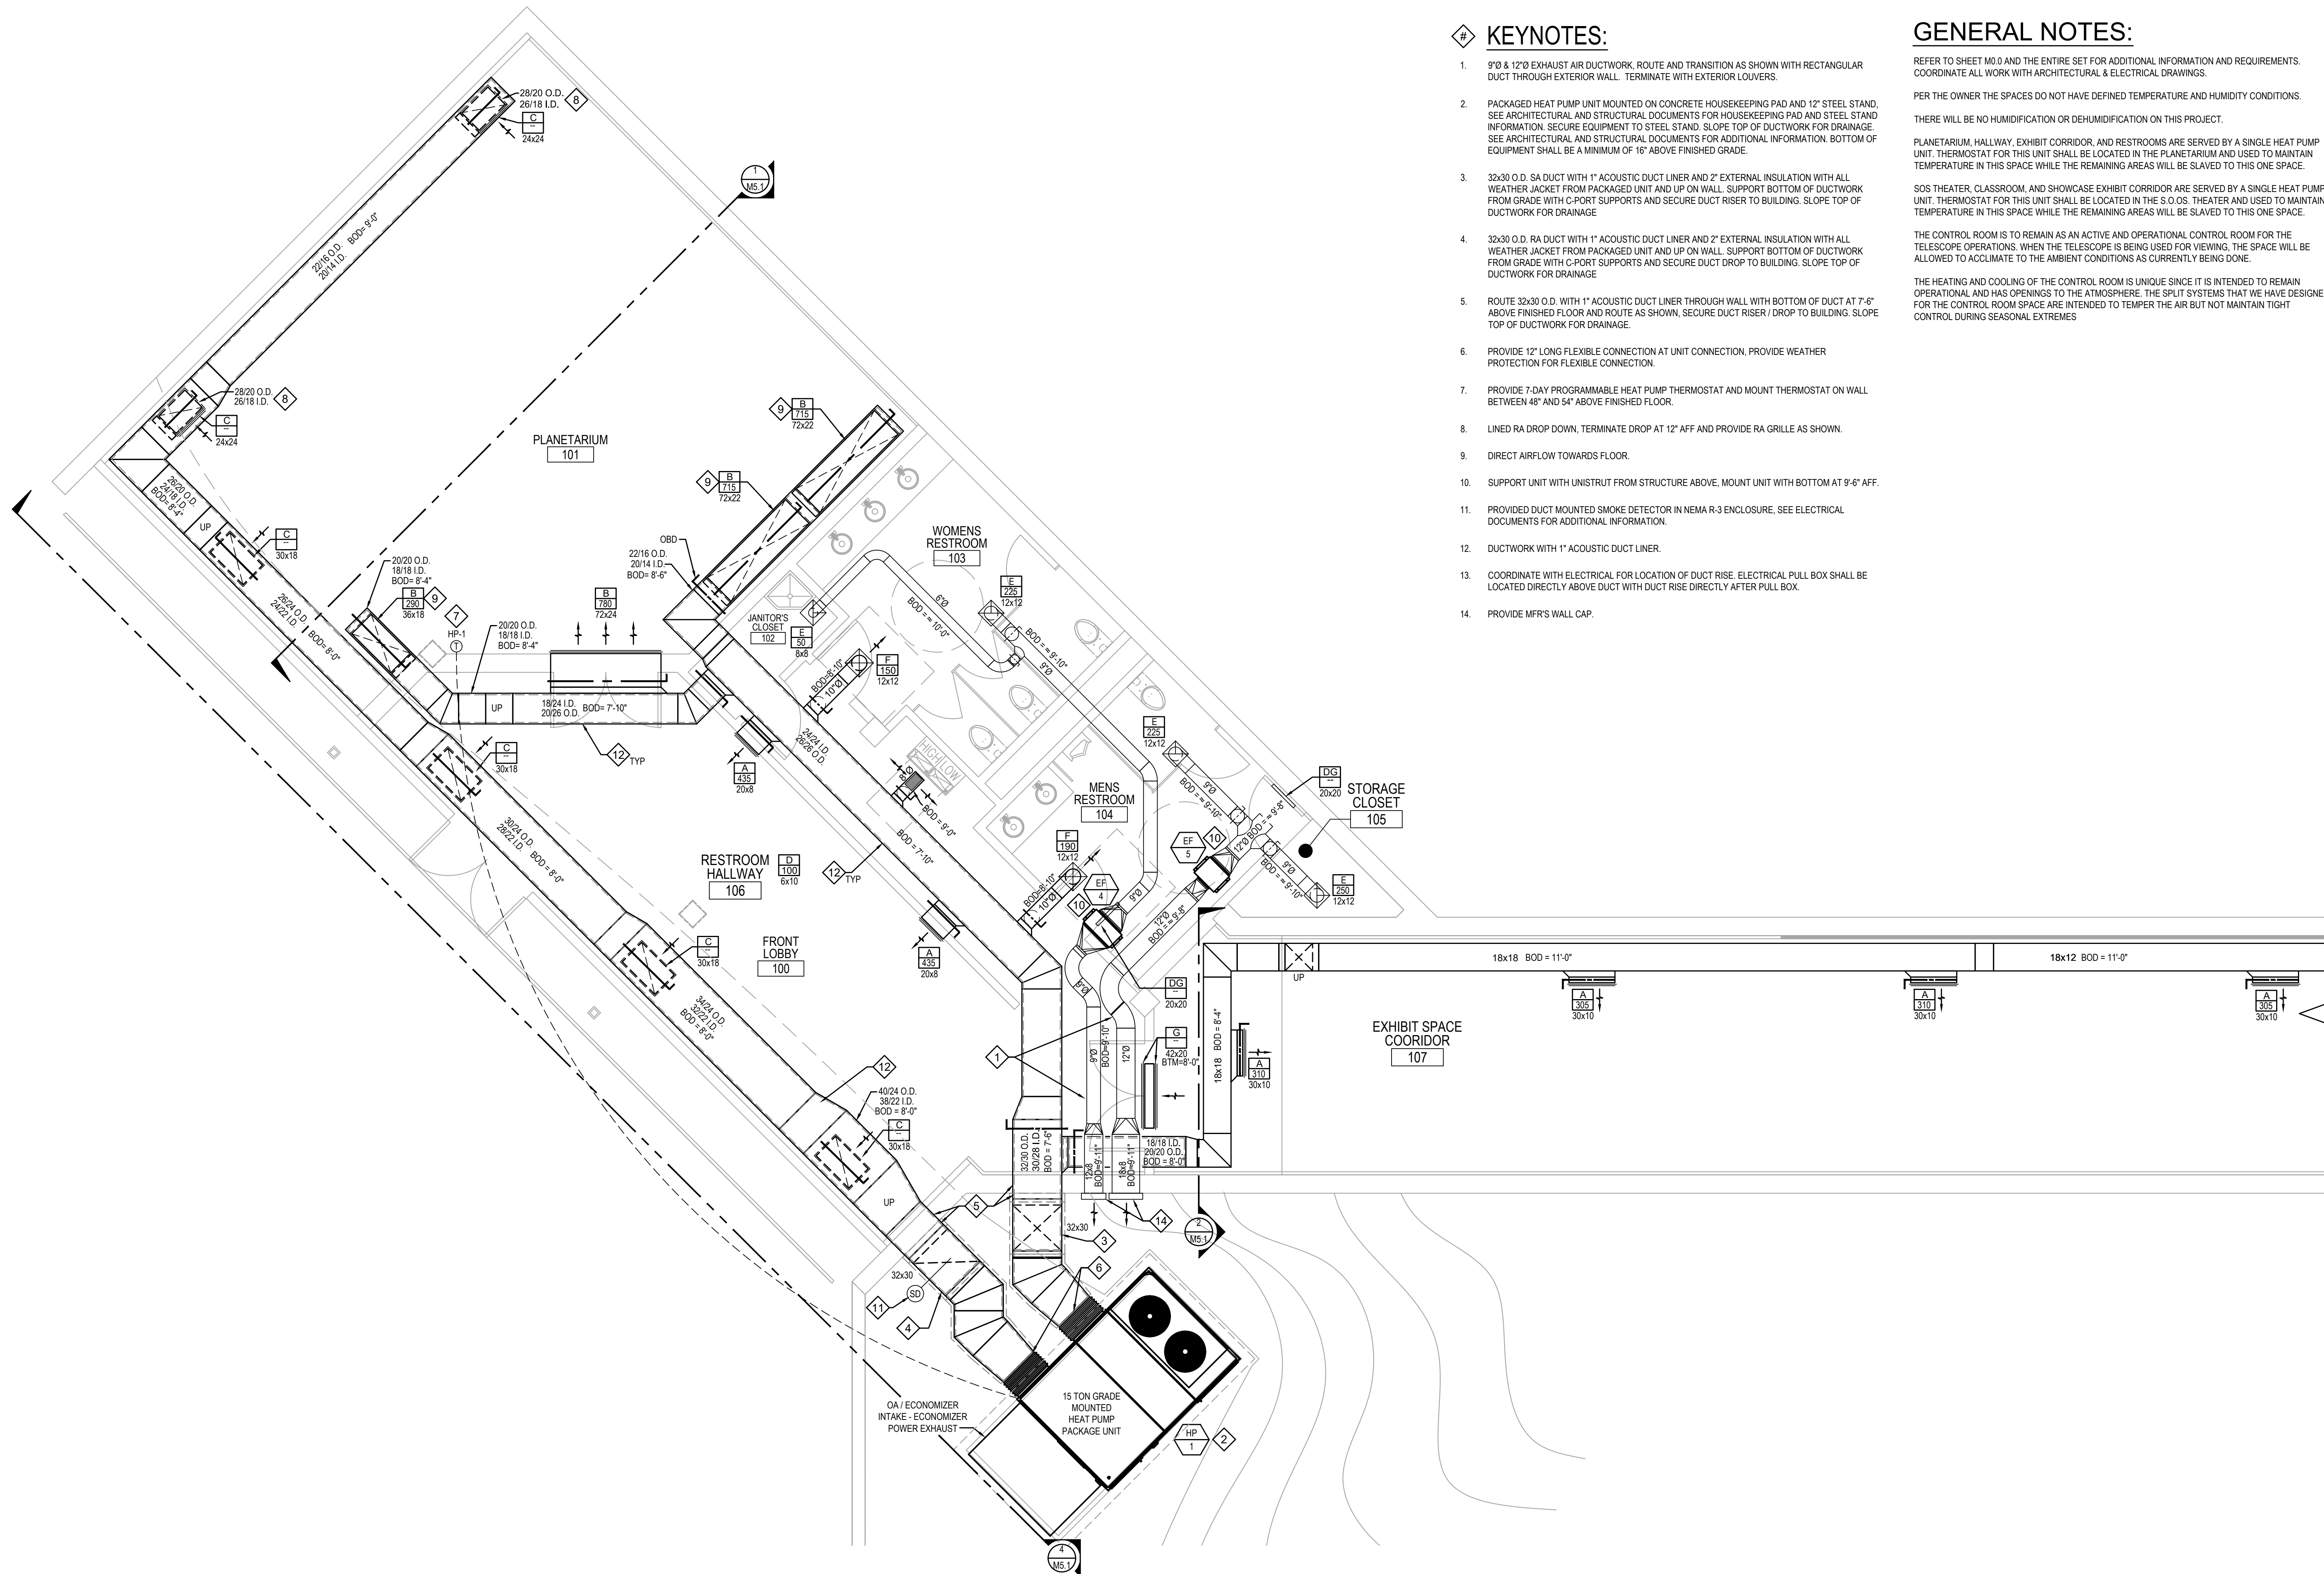
FOR ENLARGED PLAN OF THIS AREA SEE 1/M1.3

FOR ENLARGED PLAN OF THIS AREA SEE 1/M1.4

1 MECHANICAL HVAC RENOVATION PLAN
1ST LEVEL

SCALE: 1/8"=1'-0"





1 MECHANICAL HVAC RENOVATION PLAN
1ST LEVEL

SCALE: 1/4"=1'-0"

KEYNOTES:

1. 9"Ø & 12"Ø EXHAUST AIR DUCTWORK, ROUTE AND TRANSITION AS SHOWN WITH RECTANGULAR DUCT THROUGH EXTERIOR WALL. TERMINATE WITH EXTERIOR LOUVERS.
2. PACKAGED HEAT PUMP UNIT MOUNTED ON CONCRETE HOUSEKEEPING PAD AND 12" STEEL STAND. SEE ARCHITECTURAL AND STRUCTURAL DOCUMENTS FOR HOUSEKEEPING PAD AND STEEL STAND INFORMATION. SECURE EQUIPMENT TO STEEL STAND. SLOPE TOP OF DUCTWORK FOR DRAINAGE. SEE ARCHITECTURAL AND STRUCTURAL DOCUMENTS FOR ADDITIONAL INFORMATION. BOTTOM OF EQUIPMENT SHALL BE A MINIMUM OF 16" ABOVE FINISHED GRADE.
3. 32x30 O.D. SA DUCT WITH 1" ACOUSTIC DUCT LINER AND 2" EXTERNAL INSULATION WITH ALL WEATHER JACKET FROM PACKAGED UNIT AND UP ON WALL. SUPPORT BOTTOM OF DUCTWORK FROM GRADE WITH C-PORT SUPPORTS AND SECURE DUCT RISER TO BUILDING. SLOPE TOP OF DUCTWORK FOR DRAINAGE.
4. 32x30 O.D. RA DUCT WITH 1" ACOUSTIC DUCT LINER AND 2" EXTERNAL INSULATION WITH ALL WEATHER JACKET FROM PACKAGED UNIT AND UP ON WALL. SUPPORT BOTTOM OF DUCTWORK FROM GRADE WITH C-PORT SUPPORTS AND SECURE DUCT DROP TO BUILDING. SLOPE TOP OF DUCTWORK FOR DRAINAGE.
5. ROUTE 32x30 O.D. WITH 1" ACOUSTIC DUCT LINER THROUGH WALL WITH BOTTOM OF DUCT AT 7'-6" ABOVE FINISHED FLOOR AND ROUTE AS SHOWN. SECURE DUCT RISER / DROP TO BUILDING. SLOPE TOP OF DUCTWORK FOR DRAINAGE.
6. PROVIDE 12" LONG FLEXIBLE CONNECTION AT UNIT CONNECTION. PROVIDE WEATHER PROTECTION FOR FLEXIBLE CONNECTION.
7. PROVIDE 7-DAY PROGRAMMABLE HEAT PUMP THERMOSTAT AND MOUNT THERMOSTAT ON WALL BETWEEN 48" AND 54" ABOVE FINISHED FLOOR.
8. LINED RA DROP DOWN, TERMINATE DROP AT 12" AFF AND PROVIDE RA GRILLE AS SHOWN.
9. DIRECT AIRFLOW TOWARDS FLOOR.
10. SUPPORT UNIT WITH UNISTRUT FROM STRUCTURE ABOVE, MOUNT UNIT WITH BOTTOM AT 9'-6" AFF.
11. PROVIDED DUCT MOUNTED SMOKE DETECTOR IN NEMA R-3 ENCLOSURE. SEE ELECTRICAL DOCUMENTS FOR ADDITIONAL INFORMATION.
12. DUCTWORK WITH 1" ACOUSTIC DUCT LINER.
13. COORDINATE WITH ELECTRICAL FOR LOCATION OF DUCT RISE. ELECTRICAL PULL BOX SHALL BE LOCATED DIRECTLY ABOVE DUCT WITH DUCT RISE DIRECTLY AFTER PULL BOX.
14. PROVIDE MFR'S WALL CAP.

GENERAL NOTES:

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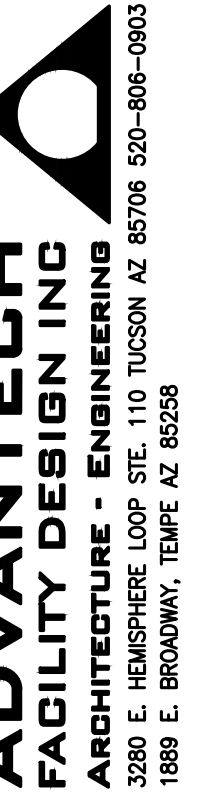
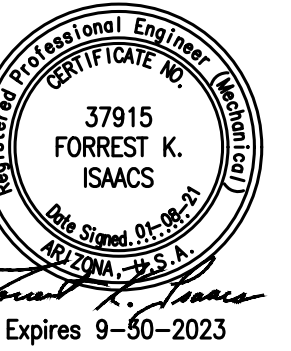
PER THE OWNER THE SPACES DO NOT HAVE DEFINED TEMPERATURE AND HUMIDITY CONDITIONS. THERE WILL BE NO HUMIDIFICATION OR DEHUMIDIFICATION ON THIS PROJECT.

PLANETARIUM, HALLWAY, EXHIBIT CORRIDOR, AND RESTROOMS ARE SERVED BY A SINGLE HEAT PUMP UNIT. THERMOSTAT FOR THIS UNIT SHALL BE LOCATED IN THE PLANETARIUM AND USED TO MAINTAIN TEMPERATURE IN THIS SPACE WHILE THE REMAINING AREAS WILL BE SLAVED TO THIS ONE SPACE.



SOS THEATER, CLASSROOM, AND SHOWCASE EXHIBIT CORRIDOR ARE SERVED BY A SINGLE HEAT PUMP UNIT. THERMOSTAT FOR THIS UNIT SHALL BE LOCATED IN THE S.O.S. THEATER AND USED TO MAINTAIN TEMPERATURE IN THIS SPACE WHILE THE REMAINING AREAS WILL BE SLAVED TO THIS ONE SPACE.

THE CONTROL ROOM IS TO REMAIN AS AN ACTIVE AND OPERATIONAL CONTROL ROOM FOR THE TELESCOPE OPERATIONS. WHEN THE TELESCOPE IS BEING USED FOR VIEWING, THE SPACE WILL BE ALLOWED TO ACCLIMATE TO THE AMBIENT CONDITIONS AS CURRENTLY BEING DONE.

THE HEATING AND COOLING OF THE CONTROL ROOM IS UNIQUE SINCE IT IS INTENDED TO REMAIN OPERATIONAL AND HAS OPENINGS TO THE ATMOSPHERE. THE SPLIT SYSTEMS THAT WE HAVE DESIGNED FOR THE CONTROL ROOM SPACE ARE INTENDED TO TEMPER THE AIR BUT NOT MAINTAIN TIGHT CONTROL DURING SEASONAL EXTREMES



WINDOWS ON
THE UNIVERSE
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KITT PEAK - Sells, AZ 85634

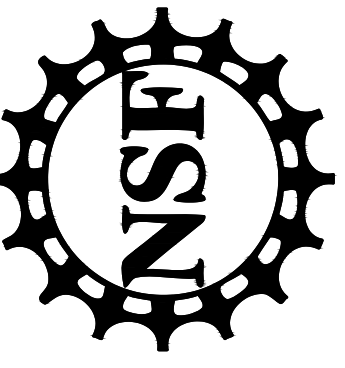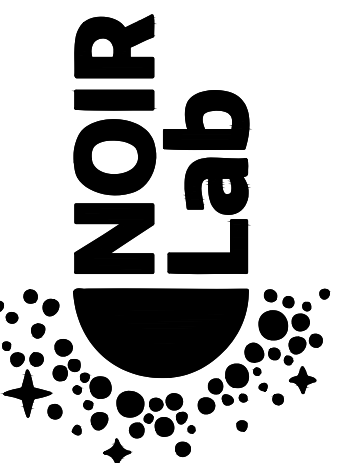Δ	DATE	DESCRIPTION
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PROJECT NUMBER: 11904.00
DRAWN BY: FI
CHECKED BY: FI
CAD FILE: 11904.00-M1.2
SCALE: AS SHOWN

MECHANICAL
HVAC
RENOVATION PLANS

M1.2

KEYNOTES:

1. CONNECT NEW 6"Ø EXHAUST AIR DUCT TO EXISTING 6"Ø AND ROUTE AS SHOW.
2. CONNECT NEW 8"Ø EXHAUST AIR DUCT TO EXISTING 8"Ø AND ROUTE AS SHOW.
3. UNDERCUT DOORS A MINIMUM 1". REFER TO ARCHITECTURAL DOCUMENTS FOR ADDITIONAL INFORMATION.
4. THERMOSTAT. MOUNT ON WALL @ 48" TO 54" AFF.
5. EXHAUST FAN WITH MFR'S PROVIDE WHITE ALUMINUM GRILLE.
6. REFRIGERANT PIPING, SEE M2 SERIES DOCUMENTS FOR ADDITIONAL INFORMATION.
7. PROVIDE 3 TON DUCTLESS SPLIT EVAPORATOR. INSTALL ON WALL USING MANUFACTURER'S WALL MOUNTING HARDWARE.

GENERAL NOTES:

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PER THE OWNER THE SPACES DO NOT HAVE DEFINED TEMPERATURE AND HUMIDITY CONDITIONS. THERE WILL BE NO HUMIDIFICATION OR DEHUMIDIFICATION ON THIS PROJECT.

PLANETARIUM, HALLWAY, EXHIBIT CORRIDOR, AND RESTROOMS ARE SERVED BY A SINGLE HEAT PUMP UNIT. THERMOSTAT FOR THIS UNIT SHALL BE LOCATED IN THE PLANETARIUM AND USED TO MAINTAIN TEMPERATURE IN THIS SPACE WHILE THE REMAINING AREAS WILL BE SLAVED TO THIS ONE SPACE.

SOS THEATER, CLASSROOM, AND SHOWCASE EXHIBIT CORRIDOR ARE SERVED BY A SINGLE HEAT PUMP UNIT. THERMOSTAT FOR THIS UNIT SHALL BE LOCATED IN THE S.O.S. THEATER AND USED TO MAINTAIN TEMPERATURE IN THIS SPACE WHILE THE REMAINING AREAS WILL BE SLAVED TO THIS ONE SPACE.

THE CONTROL ROOM IS TO REMAIN AS AN ACTIVE AND OPERATIONAL CONTROL ROOM FOR THE TELESCOPE OPERATIONS. WHEN THE TELESCOPE IS BEING USED FOR VIEWING, THE SPACE WILL BE ALLOWED TO ACCLIMATE TO THE AMBIENT CONDITIONS AS CURRENTLY BEING DONE.

THE HEATING AND COOLING OF THE CONTROL ROOM IS UNIQUE SINCE IT IS INTENDED TO REMAIN OPERATIONAL AND HAS OPENINGS TO THE ATMOSPHERE. THE SPLIT SYSTEMS THAT WE HAVE DESIGNED FOR THE CONTROL ROOM SPACE ARE INTENDED TO TEMPER THE AIR BUT NOT MAINTAIN TIGHT CONTROL DURING SEASONAL EXTREMES.

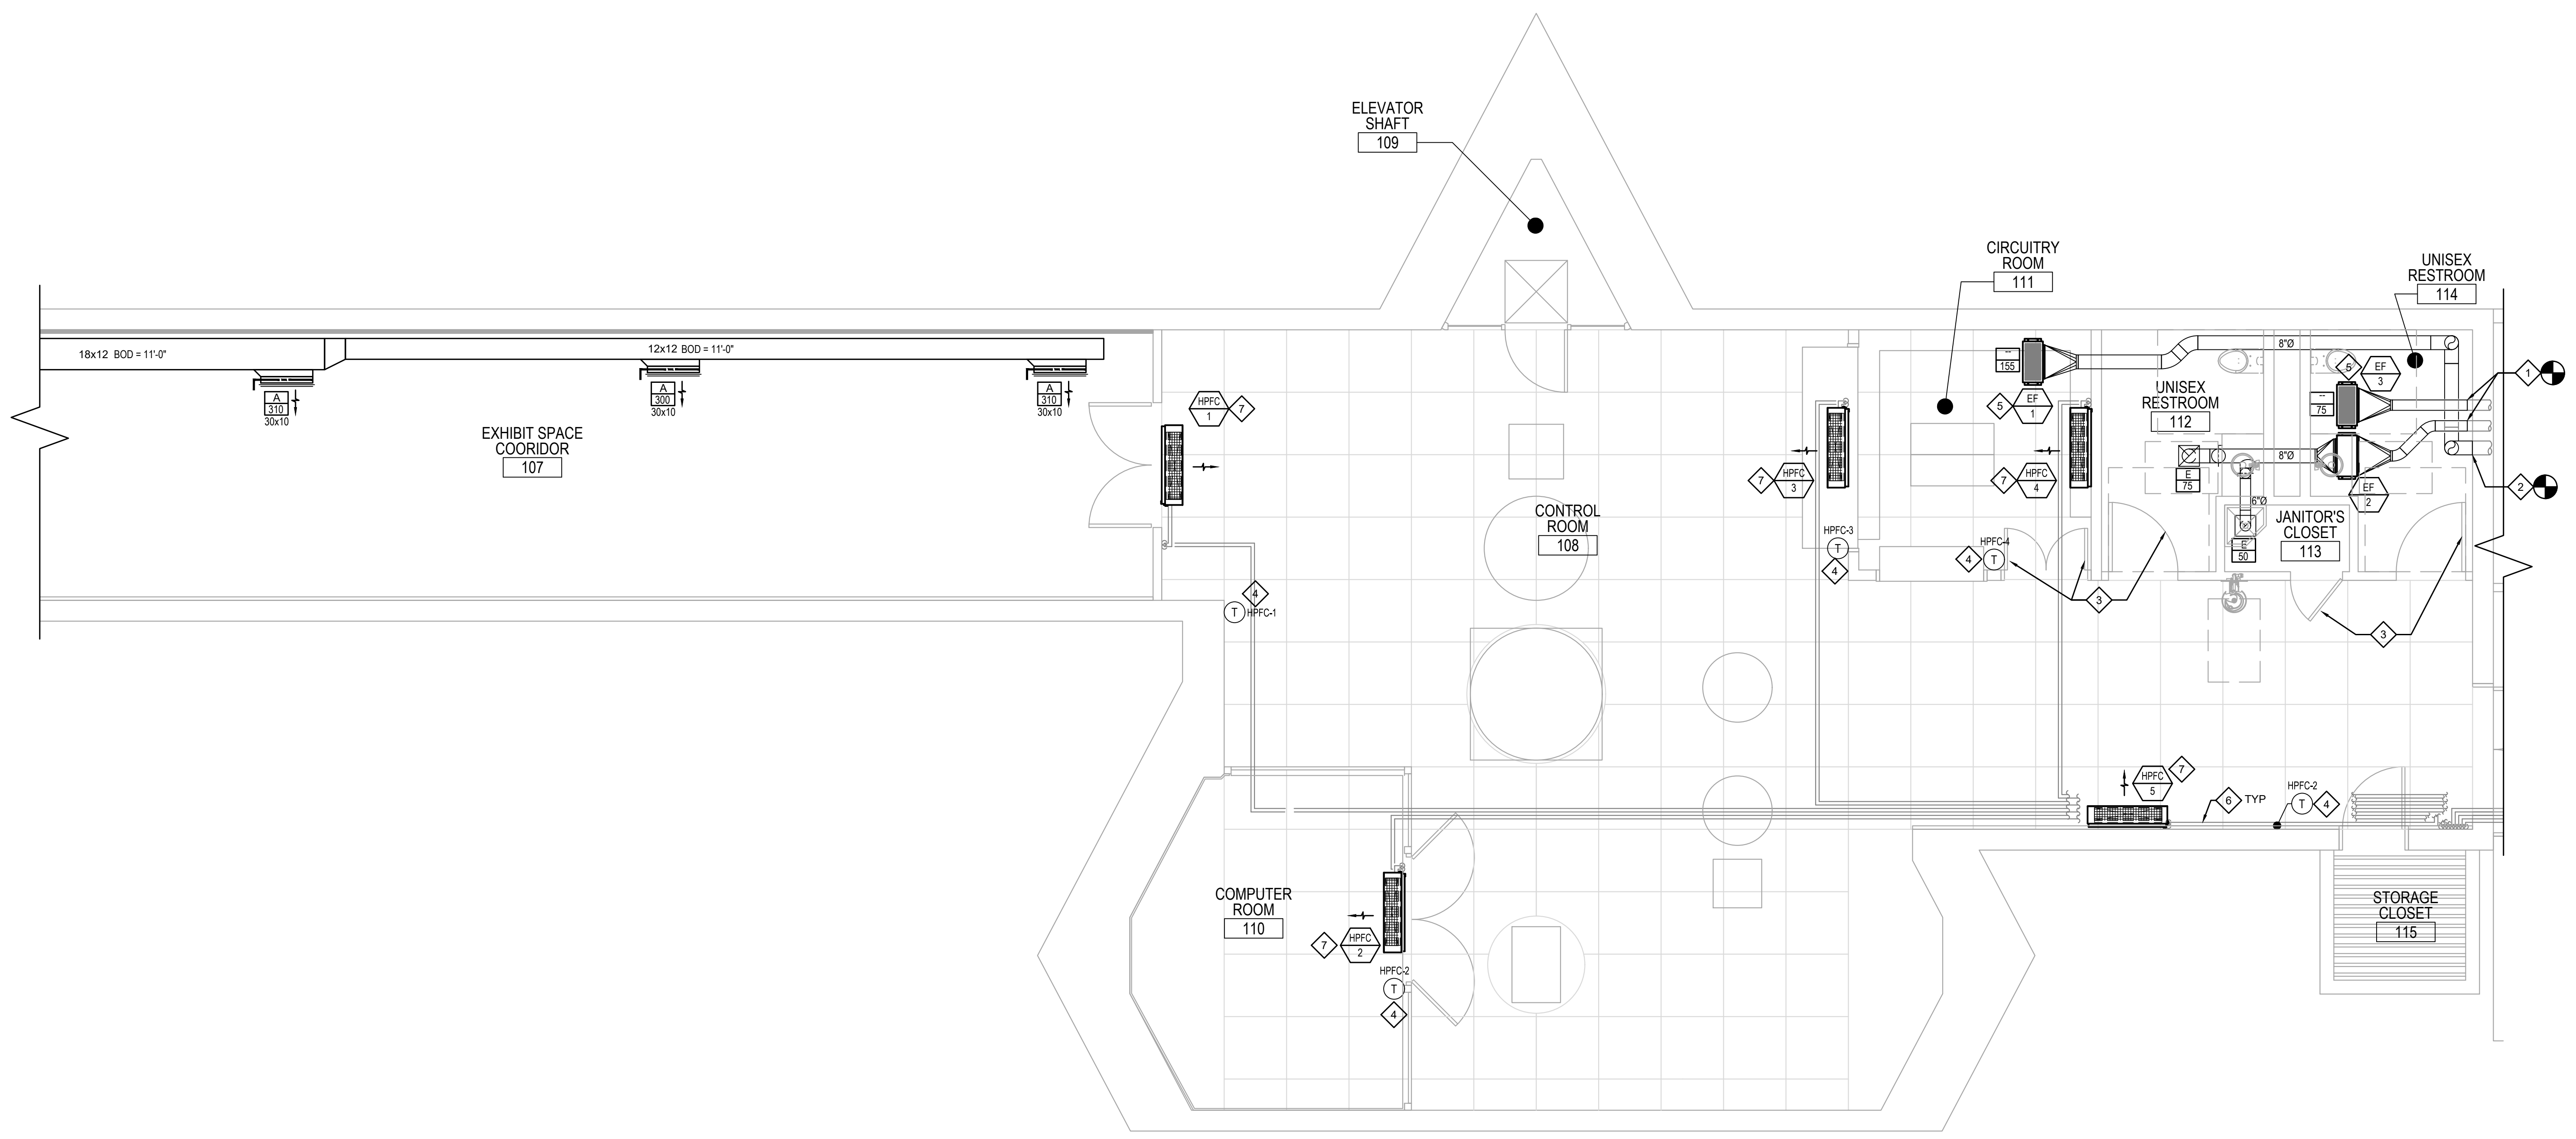
CONTRACTOR SHALL PROTECT ALL EXISTING EQUIPMENT AND VIEWING PORTALS IN PLACE.




WINDOWS ON THE UNIVERSE CENTER FOR ASTRONOMY OUTREACH



KITT PEAK - Sells, AZ 85634



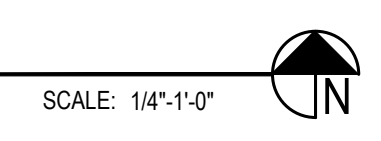1 MECHANICAL HVAC RENOVATION PLAN
1ST LEVEL



△	DATE	DESCRIPTION
0	01/08/21	I.F.C.

PROJECT NUMBER: 11904.00
 DRAWN BY: FI
 CHECKED BY: FI
 CAD FILE: 11904.00-M1.3
 SCALE: AS SHOWN

MECHANICAL
 HVAC
 RENOVATION PLANS

M1.3

KEYNOTES:

- PACKAGED HEAT PUMP UNIT MOUNTED ON CONCRETE HOUSEKEEPING PAD AND 12" STEEL STAND. SEE ARCHITECTURAL AND STRUCTURAL DOCUMENTS FOR HOUSEKEEPING PAD AND STEEL STAND INFORMATION. SECURE EQUIPMENT TO STEEL STAND. SEE ARCHITECTURAL AND STRUCTURAL DOCUMENTS FOR ADDITIONAL INFORMATION. BOTTOM OF EQUIPMENT SHALL BE A MINIMUM OF 16" ABOVE FINISHED GRADE.
- AIR COOLED CONDENSING UNIT MOUNTED ON CONCRETE HOUSEKEEPING PAD AND 12" STEEL STAND. SEE ARCHITECTURAL AND STRUCTURAL DOCUMENTS FOR HOUSEKEEPING PAD AND STEEL STAND INFORMATION. SECURE EQUIPMENT TO STEEL STAND. SEE ARCHITECTURAL AND STRUCTURAL DOCUMENTS FOR ADDITIONAL INFORMATION. BOTTOM OF EQUIPMENT SHALL BE A MINIMUM OF 16" ABOVE FINISHED GRADE.
- 32x30 O.D. SA DUCT WITH 1" ACOUSTIC DUCT LINER AND 2" EXTERNAL INSULATION WITH ALL WEATHER JACKET FROM PACKAGED UNIT AND UP ON WALL. SUPPORT BOTTOM OF DUCTWORK FROM GRADE WITH C-PORT SUPPORTS AND SECURE DUCT RISER TO BUILDING. SLOPE TOP OF DUCTWORK FOR DRAINAGE.
- 32x30 O.D. RA DUCT WITH 1" ACOUSTIC DUCT LINER AND 2" EXTERNAL INSULATION WITH ALL WEATHER JACKET FROM PACKAGED UNIT AND UP ON WALL. SUPPORT BOTTOM OF DUCTWORK FROM GRADE WITH C-PORT SUPPORTS AND SECURE DUCT TO BUILDING. SLOPE TOP OF DUCTWORK FOR DRAINAGE.
- ROUTE 32x30 O.D. RA DUCT WITH 1" ACOUSTIC DUCT LINER THROUGH WALL WITH BOTTOM OF DUCT AT 7'-6" ABOVE FINISHED FLOOR AND ROUTE AS SHOWN. SECURE DUCT RISER/DROP TO BUILDING. SLOPE TOP OF DUCTWORK FOR DRAINAGE.
- PROVIDE FLEXIBLE CONNECTION AT UNIT CONNECTION, PROVIDE WEATHER PROTECTION FOR FLEXIBLE CONNECTION.
- PROVIDE 7-DAY PROGRAMMABLE HEAT PUMP THERMOSTAT AND MOUNT THERMOSTAT ON WALL BETWEEN 48" AND 54" ABOVE FINISHED FLOOR.
- PROVIDE NEW OPENING IN EXISTING CONCRETE WALL. SEE ARCHITECTURAL AND STRUCTURAL DOCUMENTS FOR ADDITIONAL INFORMATION.
- ENLARGE EXISTING OPENING IN CONCRETE WALL. SEE ARCHITECTURAL AND STRUCTURAL DOCUMENTS FOR ADDITIONAL INFORMATION.
- REFRIGERANT PIPING. SEE M2 SERIES DOCUMENTS FOR ADDITIONAL INFORMATION.
- PROVIDE ALUMINUM ALL WEATHER JACKET ON ALL EXTERIOR REFRIGERANT PIPING. SEE M2 SERIES DOCUMENTS FOR ADDITIONAL INFORMATION. SUPPORT PIPING FROM GRADE WITH C-PORT SUPPORTS.
- ROUTE DUCT THROUGH EXISTING WALL OPENING. SEAL DUCT OPENINGS WEATHER TIGHT. SEE ARCHITECTURAL AND STRUCTURAL DOCUMENTS FOR ADDITIONAL INFORMATION.
- PROVIDED DUCT MOUNTED SMOKE DETECTOR IN NEMA R-3 ENCLOSURE. SEE ELECTRICAL DOCUMENTS FOR ADDITIONAL INFORMATION.
- SUSPEND DUCTWORK FROM OVERHANG AND ALSO SECURE SUPPORTS TO WALL TO PREVENT DUCT MOVEMENT AS A RESULT OF WIND LOAD.
- 32x30 O.D. SA DUCT RISER WITH 1" ACOUSTIC DUCT LINER AND SECURE DUCT RISER/DROP TO BUILDING. SLOPE TOP OF DUCTWORK FOR DRAINAGE.
- COORDINATE ALL WALL PENETRATIONS WITH ARCHITECTURAL AND STRUCTURAL DOCUMENTS. TYPICAL ALL.
- DROP 32/30 DOWN TO APPROX 0'-2" AFF. PROVIDE CLEARANCE IN CORNER OF ROOM FOR STORAGE OF PORTABLE STAIR. COORDINATE WITH OWNER AND ARCHITECTURE FOR CLEARANCE CRITERIA PRIOR TO FABRICATION AND INSTALLATION OF DUCTWORK.
- PROVIDE DUCT MOUNTED ELECTRIC HEATER FOR OFFICE AREA. LOCATE TO MAINTAIN MINIMUM 42" CLEARANCE IN FRONT OF THE ELECTRICAL PANEL.

GENERAL NOTES:

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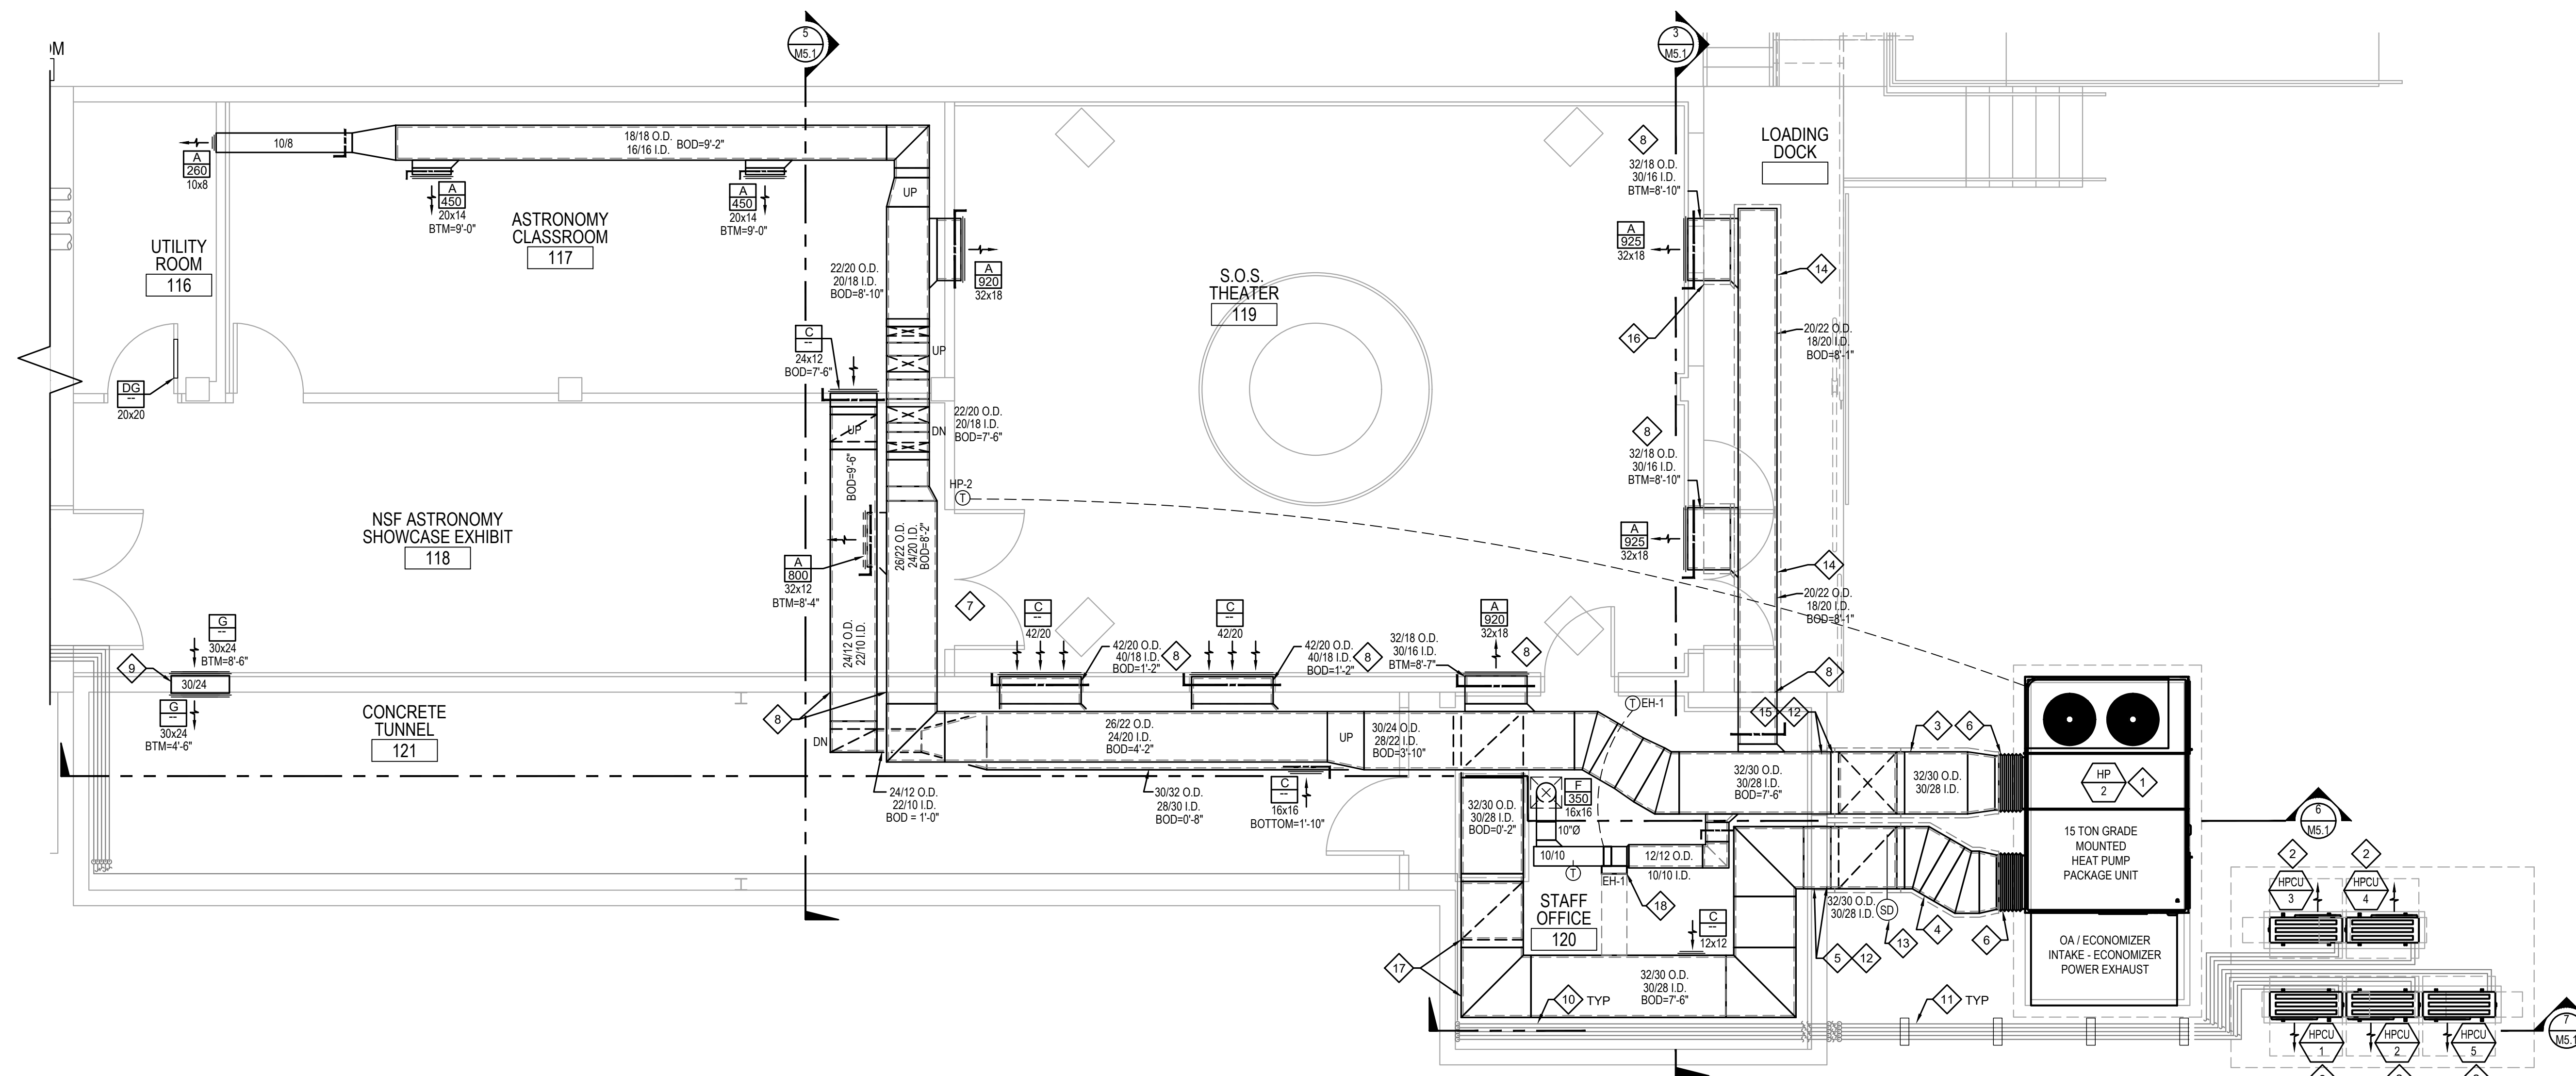
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PLANETARIUM, HALLWAY, EXHIBIT CORRIDOR, AND RESTROOMS ARE SERVED BY A SINGLE HEAT PUMP UNIT. THERMOSTAT FOR THIS UNIT SHALL BE LOCATED IN THE PLANETARIUM AND USED TO MAINTAIN TEMPERATURE IN THIS SPACE WHILE THE REMAINING AREAS WILL BE SLAVED TO THIS ONE SPACE.

SOS THEATER, CLASSROOM, AND SHOWCASE EXHIBIT CORRIDOR ARE SERVED BY A SINGLE HEAT PUMP UNIT. THERMOSTAT FOR THIS UNIT SHALL BE LOCATED IN THE S.O.S. THEATER AND USED TO MAINTAIN TEMPERATURE IN THIS SPACE WHILE THE REMAINING AREAS WILL BE SLAVED TO THIS ONE SPACE.

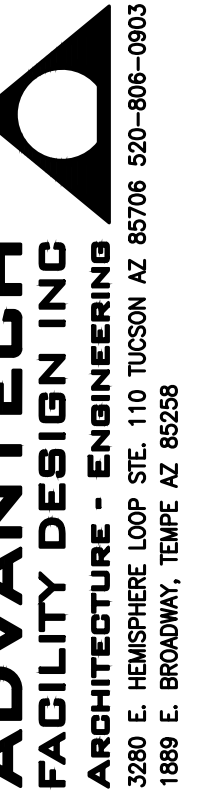
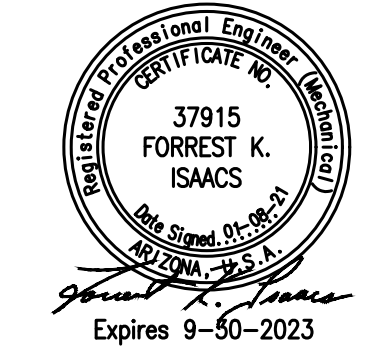
THE CONTROL ROOM IS TO REMAIN AS AN ACTIVE AND OPERATIONAL CONTROL ROOM FOR THE TELESCOPE OPERATIONS. WHEN THE TELESCOPE IS BEING USED FOR VIEWING, THE SPACE WILL BE ALLOWED TO ACCLIMATE TO THE AMBIENT CONDITIONS AS CURRENTLY BEING DONE.

THE HEATING AND COOLING OF THE CONTROL ROOM IS UNIQUE SINCE IT IS INTENDED TO REMAIN OPERATIONAL AND HAS OPENINGS TO THE ATMOSPHERE. THE SPLIT SYSTEMS THAT WE HAVE DESIGNED FOR THE CONTROL ROOM SPACE ARE INTENDED TO TEMPER THE AIR BUT NOT MAINTAIN TIGHT CONTROL DURING SEASONAL EXTREMES




1 MECHANICAL HVAC RENOVATION PLAN
1ST LEVEL

SCALE: 1/4"=1'-0"



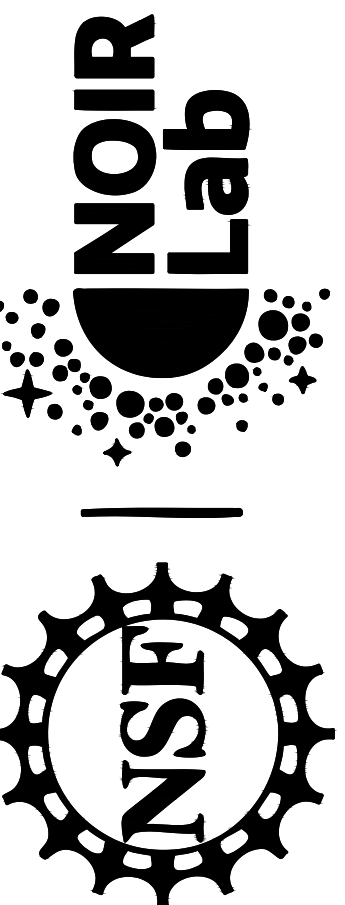WINDOWS ON
THE UNIVERSE
CENTER FOR
ASTRONOMY
OUTREACH



KITT PEAK - Sells, AZ 85634

DATE	DESCRIPTION
01/08/21	I.F.C.

PROJECT NUMBER: 11904.00
DRAWN BY: FI
CHECKED BY: FI
CAD FILE: 11904.00-M1.4
SCALE: AS SHOWN

MECHANICAL
HVAC
RENOVATION PLANS


M1.4

GENERAL NOTES:

A REFER TO SHEET M0.0 AND THE ENTIRE SET FOR ADDITIONAL INFORMATION AND REQUIREMENTS. COORDINATE ALL WORK WITH ARCHITECTURAL & ELECTRICAL DRAWINGS.



WINDOWS ON
THE UNIVERSE
CENTER FOR
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OUTREACH

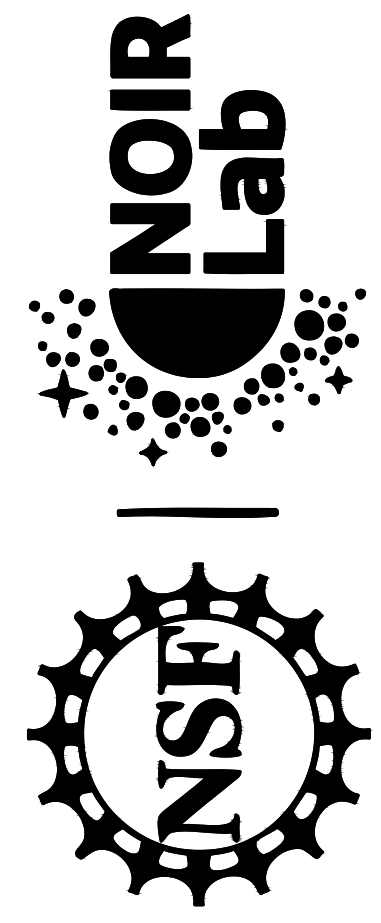


KITT PEAK - Sells, AZ 85634

△	DATE	DESCRIPTION
0	01/08/21	I.F.C.

PROJECT NUMBER: 11904.00
 DRAWN BY: FI
 CHECKED BY: FI
 CAD FILE: 11904.00-M2.1
 SCALE: AS SHOWN

MECHANICAL
PIPING
RENOVATION PLANS

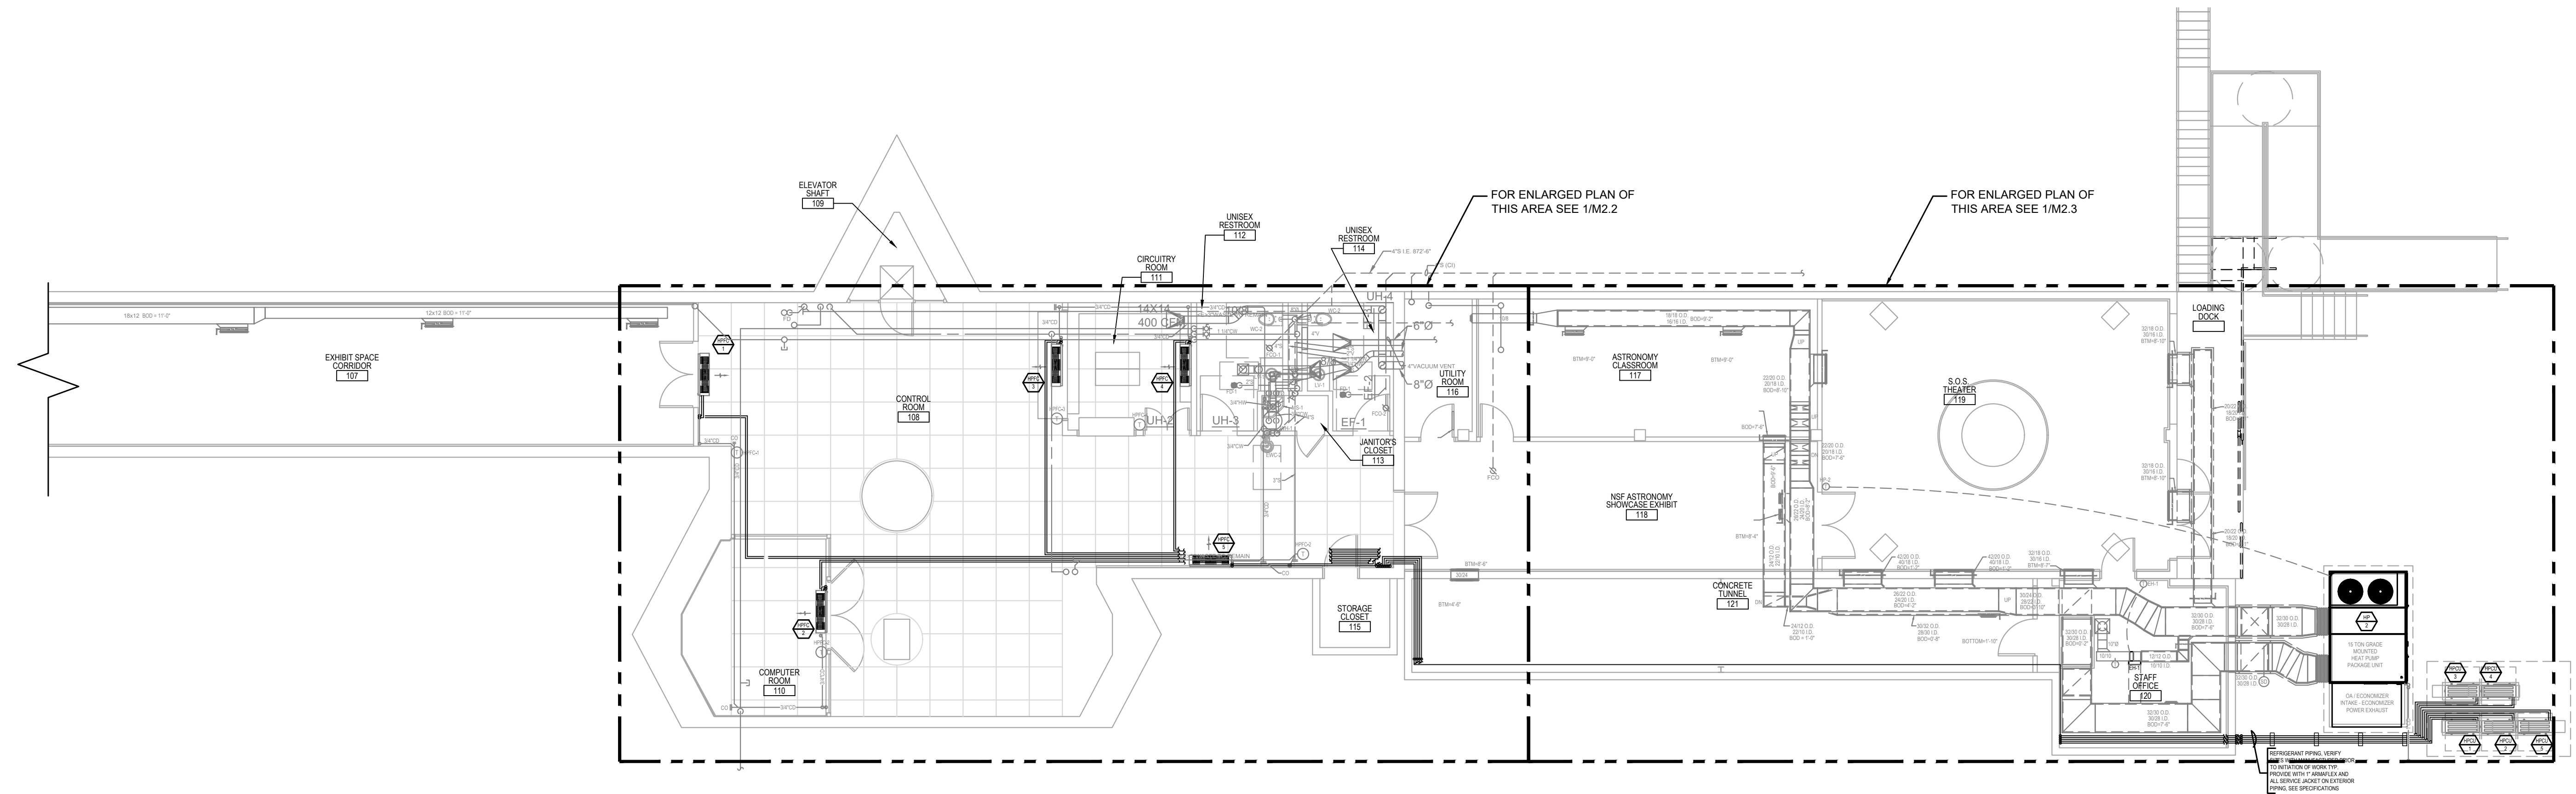M2.1



1 MECHANICAL PIPING RENOVATION PLAN
1ST LEVEL

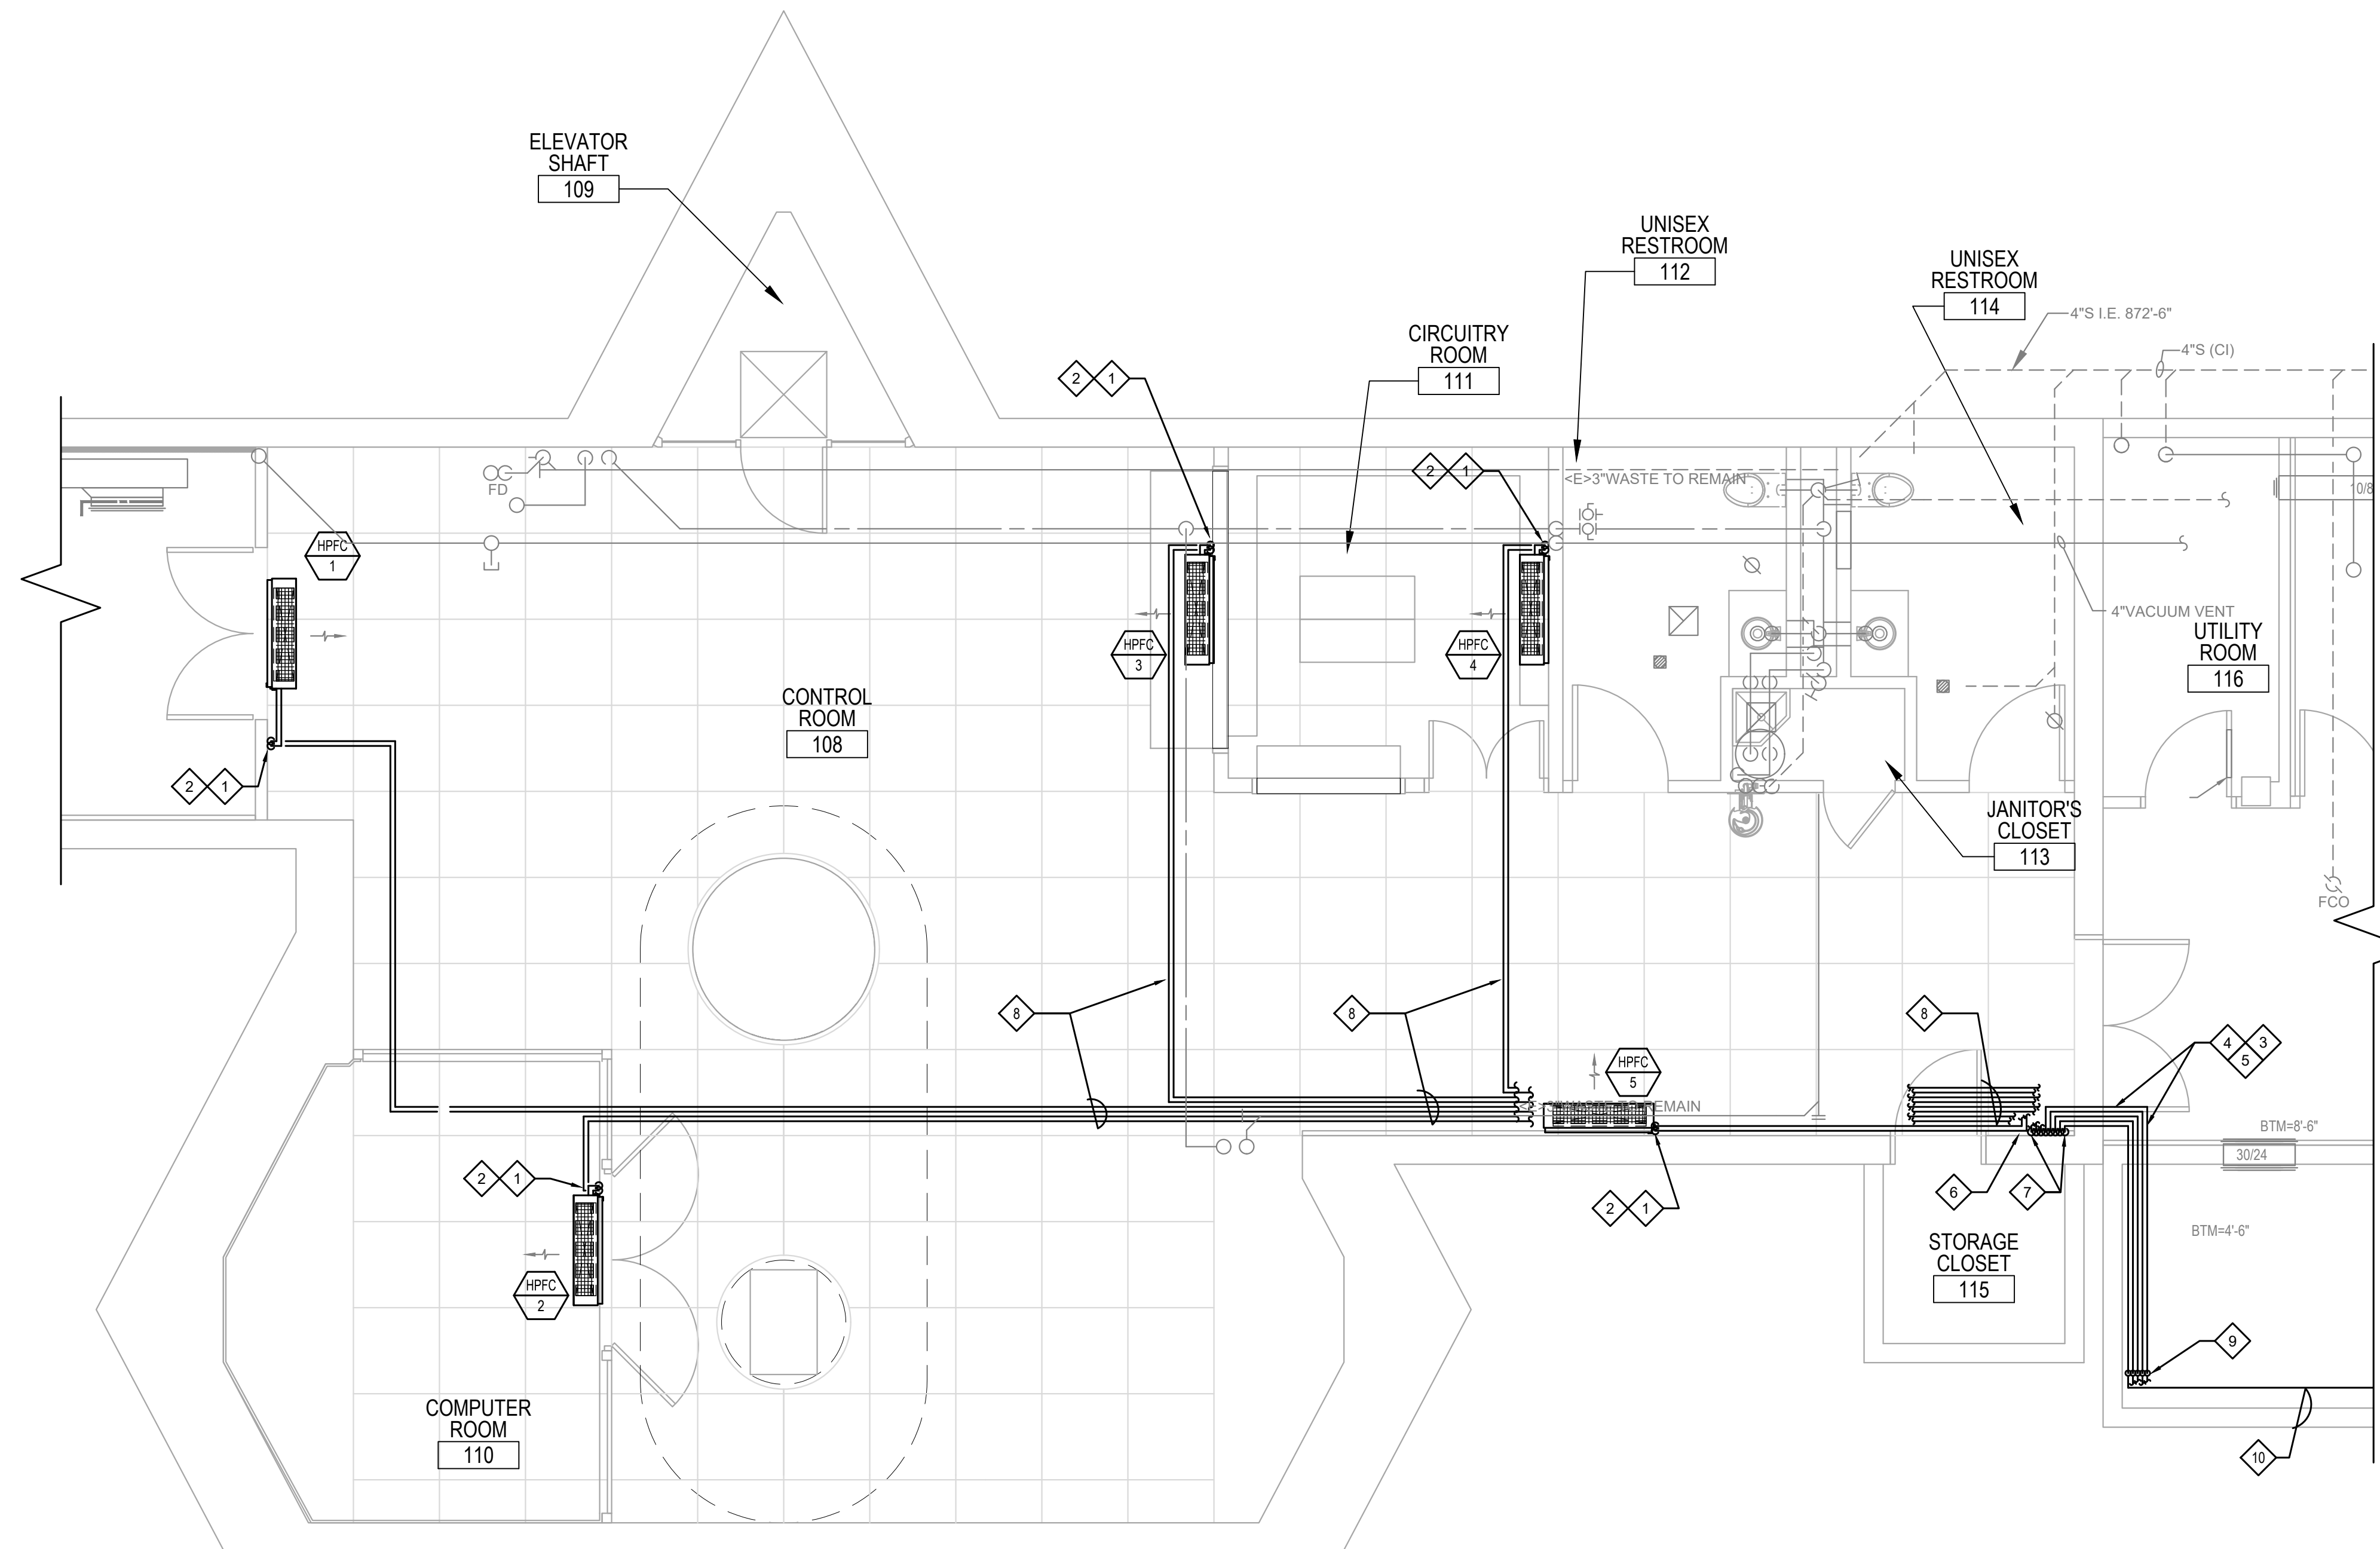
SCALE: 1/8"=1'-0"

GENERAL NOTES:

REFER TO SHEET M0.0 AND THE ENTIRE SET FOR ADDITIONAL INFORMATION AND REQUIREMENTS. COORDINATE ALL WORK WITH ARCHITECTURAL & ELECTRICAL DRAWINGS.



KEYNOTES:

1. REFRIGERANT LINES UP FROM BELOW RAISED FLOOR AND TO EVAPORATOR. PROVIDE REFRIGERANT TUBING SET FOR DUCTLESS SPLIT SYSTEM FROM EVAPORATOR TO CONDENSER AS SHOWN. FOLLOW MANUFACTURER'S RECOMMENDATIONS FOR LINE SIZES AND TUBING LENGTH LIMITS. ROUTING SHALL NOT PERMIT LINE LENGTHS LONGER THAN THE MANUFACTURER'S MAXIMUM 245 LINEAR FEET OF DEVELOPED LINE LENGTH.
2. CONNECT REFRIGERANT LINES TO EVAPORATOR PER MANUFACTURER'S INSTALLATION INSTRUCTIONS.
3. REFRIGERANT LINES THROUGH WALL. FLASH PENETRATIONS PER ARCHITECTURAL DRAWINGS. COORDINATE WALL PENETRATION WITH ARCHITECTURAL, STRUCTURAL AND ELECTRICAL DOCUMENTS. SEAL WATER TIGHT AROUND PIPE PENETRATIONS.
4. INSULATE REFRIGERANT LINES INDEPENDENTLY, PROVIDE 1" ARMAFLEX INSULATION.
5. REFRIGERANT LINES INTO CORRIDOR AREA. ROUTE TIGHT TO BELOW CEILING.
6. WRAP PIPING AROUND OTHER PIPING TIGHT TO DECK TO KEEP ON WALL. ROUTE ON WALL TO HPFC-5.
7. WRAP REFRIGERANT PIPING AROUND TIGHT TO WALL IN CORNER AND DROP TO BELOW RAISED FLOOR.
8. ROUTE REFRIGERANT PIPING BELOW RAISED FLOOR ON UNISTRUT SUPPORTS. FIELD OFFSET AROUND EXISTING PIPING, ELECTRICAL, AND OTHER CONFLICTS AS REQUIRED.
9. ROUTE PIPING UP TO TOP OF TUNNEL WITH PIPING 2 PIPES HIGH AND ROUTE INTO CORRIDOR AS HIGH AS POSSIBLE.
10. REFRIGERANT LINES INTO CONCRETE TUNNEL. RACK PIPING ON WALL WITH TOP OF PIPE AT APPROXIMATELY 5'-6" ABOVE TUNNEL FLOOR AND SUPPORT PIPING FROM WALL WITH UNISTRUT.





1 MECHANICAL PIPING RENOVATION PLAN
1ST LEVEL

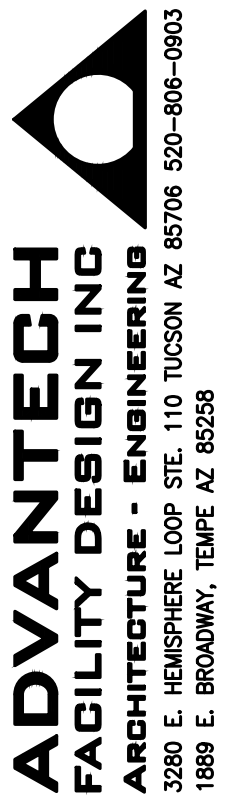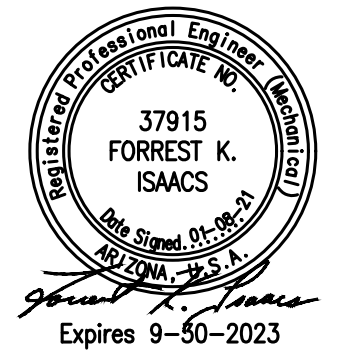SCALE: 1/4"=1'-0"



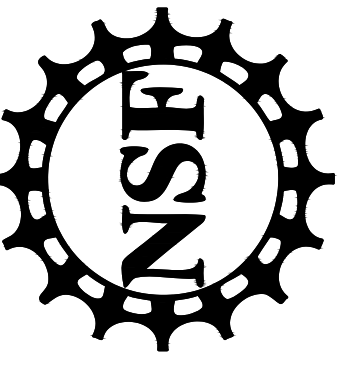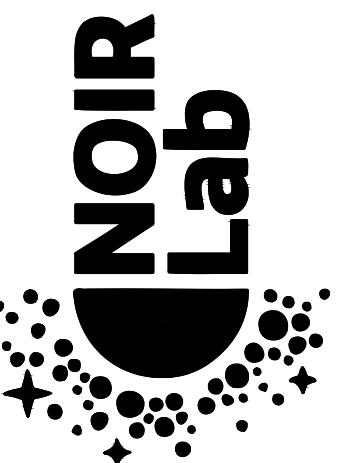WINDOWS ON
THE UNIVERSE
CENTER FOR
ASTRONOMY
OUTREACH



KITT PEAK - Sells, AZ 85634

△	DATE	DESCRIPTION
0	01/08/21	I.F.C.

PROJECT NUMBER: 11904.00
DRAWN BY: FI
CHECKED BY: FI
CAD FILE: 11904.00-M2.2
SCALE: AS SHOWN

MECHANICAL
PIPING
RENOVATION PLANS

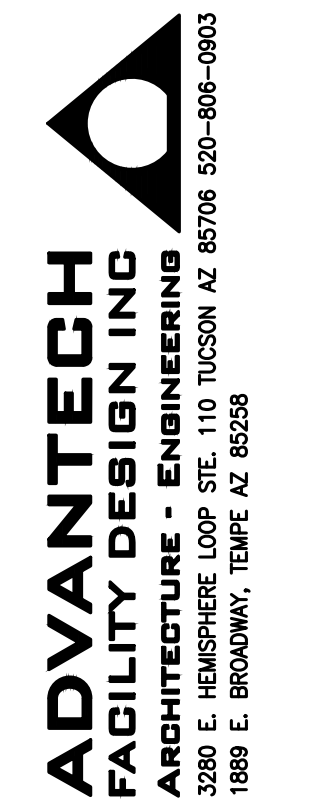
M2.2

GENERAL NOTES:

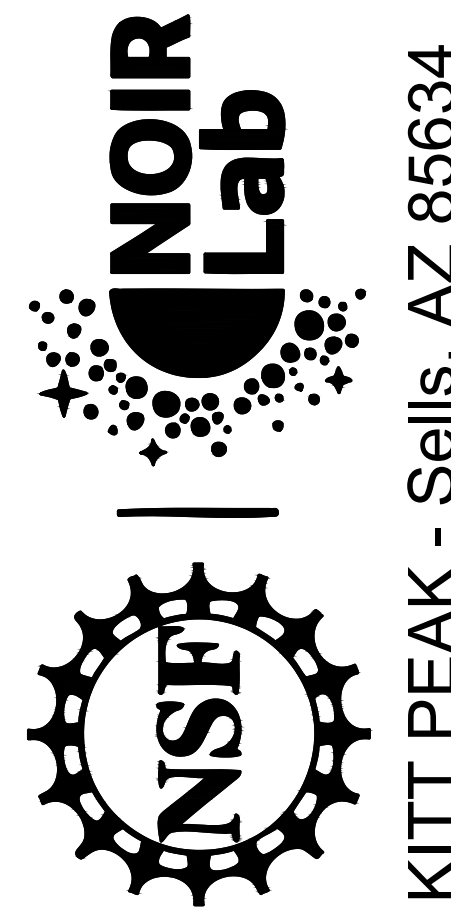
- A. REFER TO SHEET M0.0 AND THE ENTIRE SET FOR ADDITIONAL INFORMATION AND REQUIREMENTS. COORDINATE ALL WORK WITH ARCHITECTURAL & ELECTRICAL DRAWINGS.
- B. PROVIDE REFRIGERANT CHARGE AS REQUIRED FOR TUBING LENGTHS INSTALLED PER MANUFACTURER'S REQUIREMENTS.
- C. HANG NEW PIPING PER DETAIL 6M6.1 AND THE SPECIFICATIONS.
- D. INSULATE REFRIGERANT LINES PER SPECIFICATIONS. INSULATION ON EXTERIOR OF BUILDING TO BE JACKETED PER SPECIFICATIONS.

KEYNOTES:

- 1. PROVIDE REFRIGERANT TUBING SET FOR DUCTLESS SPLIT SYSTEM FROM EVAPORATOR TO CONDENSER AS SHOWN. FOLLOW MANUFACTURER'S RECOMMENDATIONS FOR LINE SIZES AND TUBING LENGTH LIMITS. ROUTING SHALL NOT PERMIT LINE LENGTHS LONGER THAN THE MANUFACTURER'S MAXIMUM 245 LINEAR FEET OF DEVELOPED LINE LENGTH.
- 2. CONNECT REFRIGERANT LINES TO CONDENSER PER MANUFACTURER'S INSTALLATION INSTRUCTIONS.
- 3. REFRIGERANT LINES THROUGH WALL, FLASH PENETRATIONS PER ARCHITECTURAL DRAWINGS. COORDINATE PENETRATION WITH ARCHITECTURAL, STRUCTURAL AND ELECTRICAL DISCIPLINES. SEAL WATER TIGHT AROUND PIPE PENETRATIONS. PIPING SHALL BE ROUTED IN LEVELS WITH AT LEAST TWO LEVELS OF REFRIGERANT PIPING TO MINIMIZE THE WIDTH OF PIPING ROUTED THROUGH THE FACILITY. ROUTE PIPING AS HIGH AS POSSIBLE (APPROXIMATELY 10'-0" FOR TOP OF TOP PIPING).
- 4. INSULATE REFRIGERANT LINES INDEPENDENTLY. PROVIDE ALUMINUM ALL SERVICE JACKET (ASJ) ON EXTERIOR INSULATED PIPING.
- 5. REFRIGERANT LINES INTO CONCRETE TUNNEL, RACK PIPING ON WALL WITH TOP OF PIPE AT APPROXIMATELY 5'-6" ABOVE TUNNEL FLOOR AND SUPPORT PIPING FROM WALL WITH UNISTRUT.
- 6. PIPE AND EQUIPMENT SUPPORTS. SEE DETAILS SHEET M6.1
- 7. REFRIGERANT LINES IN OFFICE SPACE, STACK PIPING 2 PIPES HIGH AND SUPPORT WITH HANGERS FROM ROOF, ROUTE PIPING AS HIGH AS POSSIBLE TO MAINTAIN MAXIMUM HEAD CLEARANCE.
- 8. DROP REFRIGERANT LINES DOWN AND RACK ON WALL WITH TOP OF TOP PIPE AT APPROXIMATELY 8'-6" AFF.



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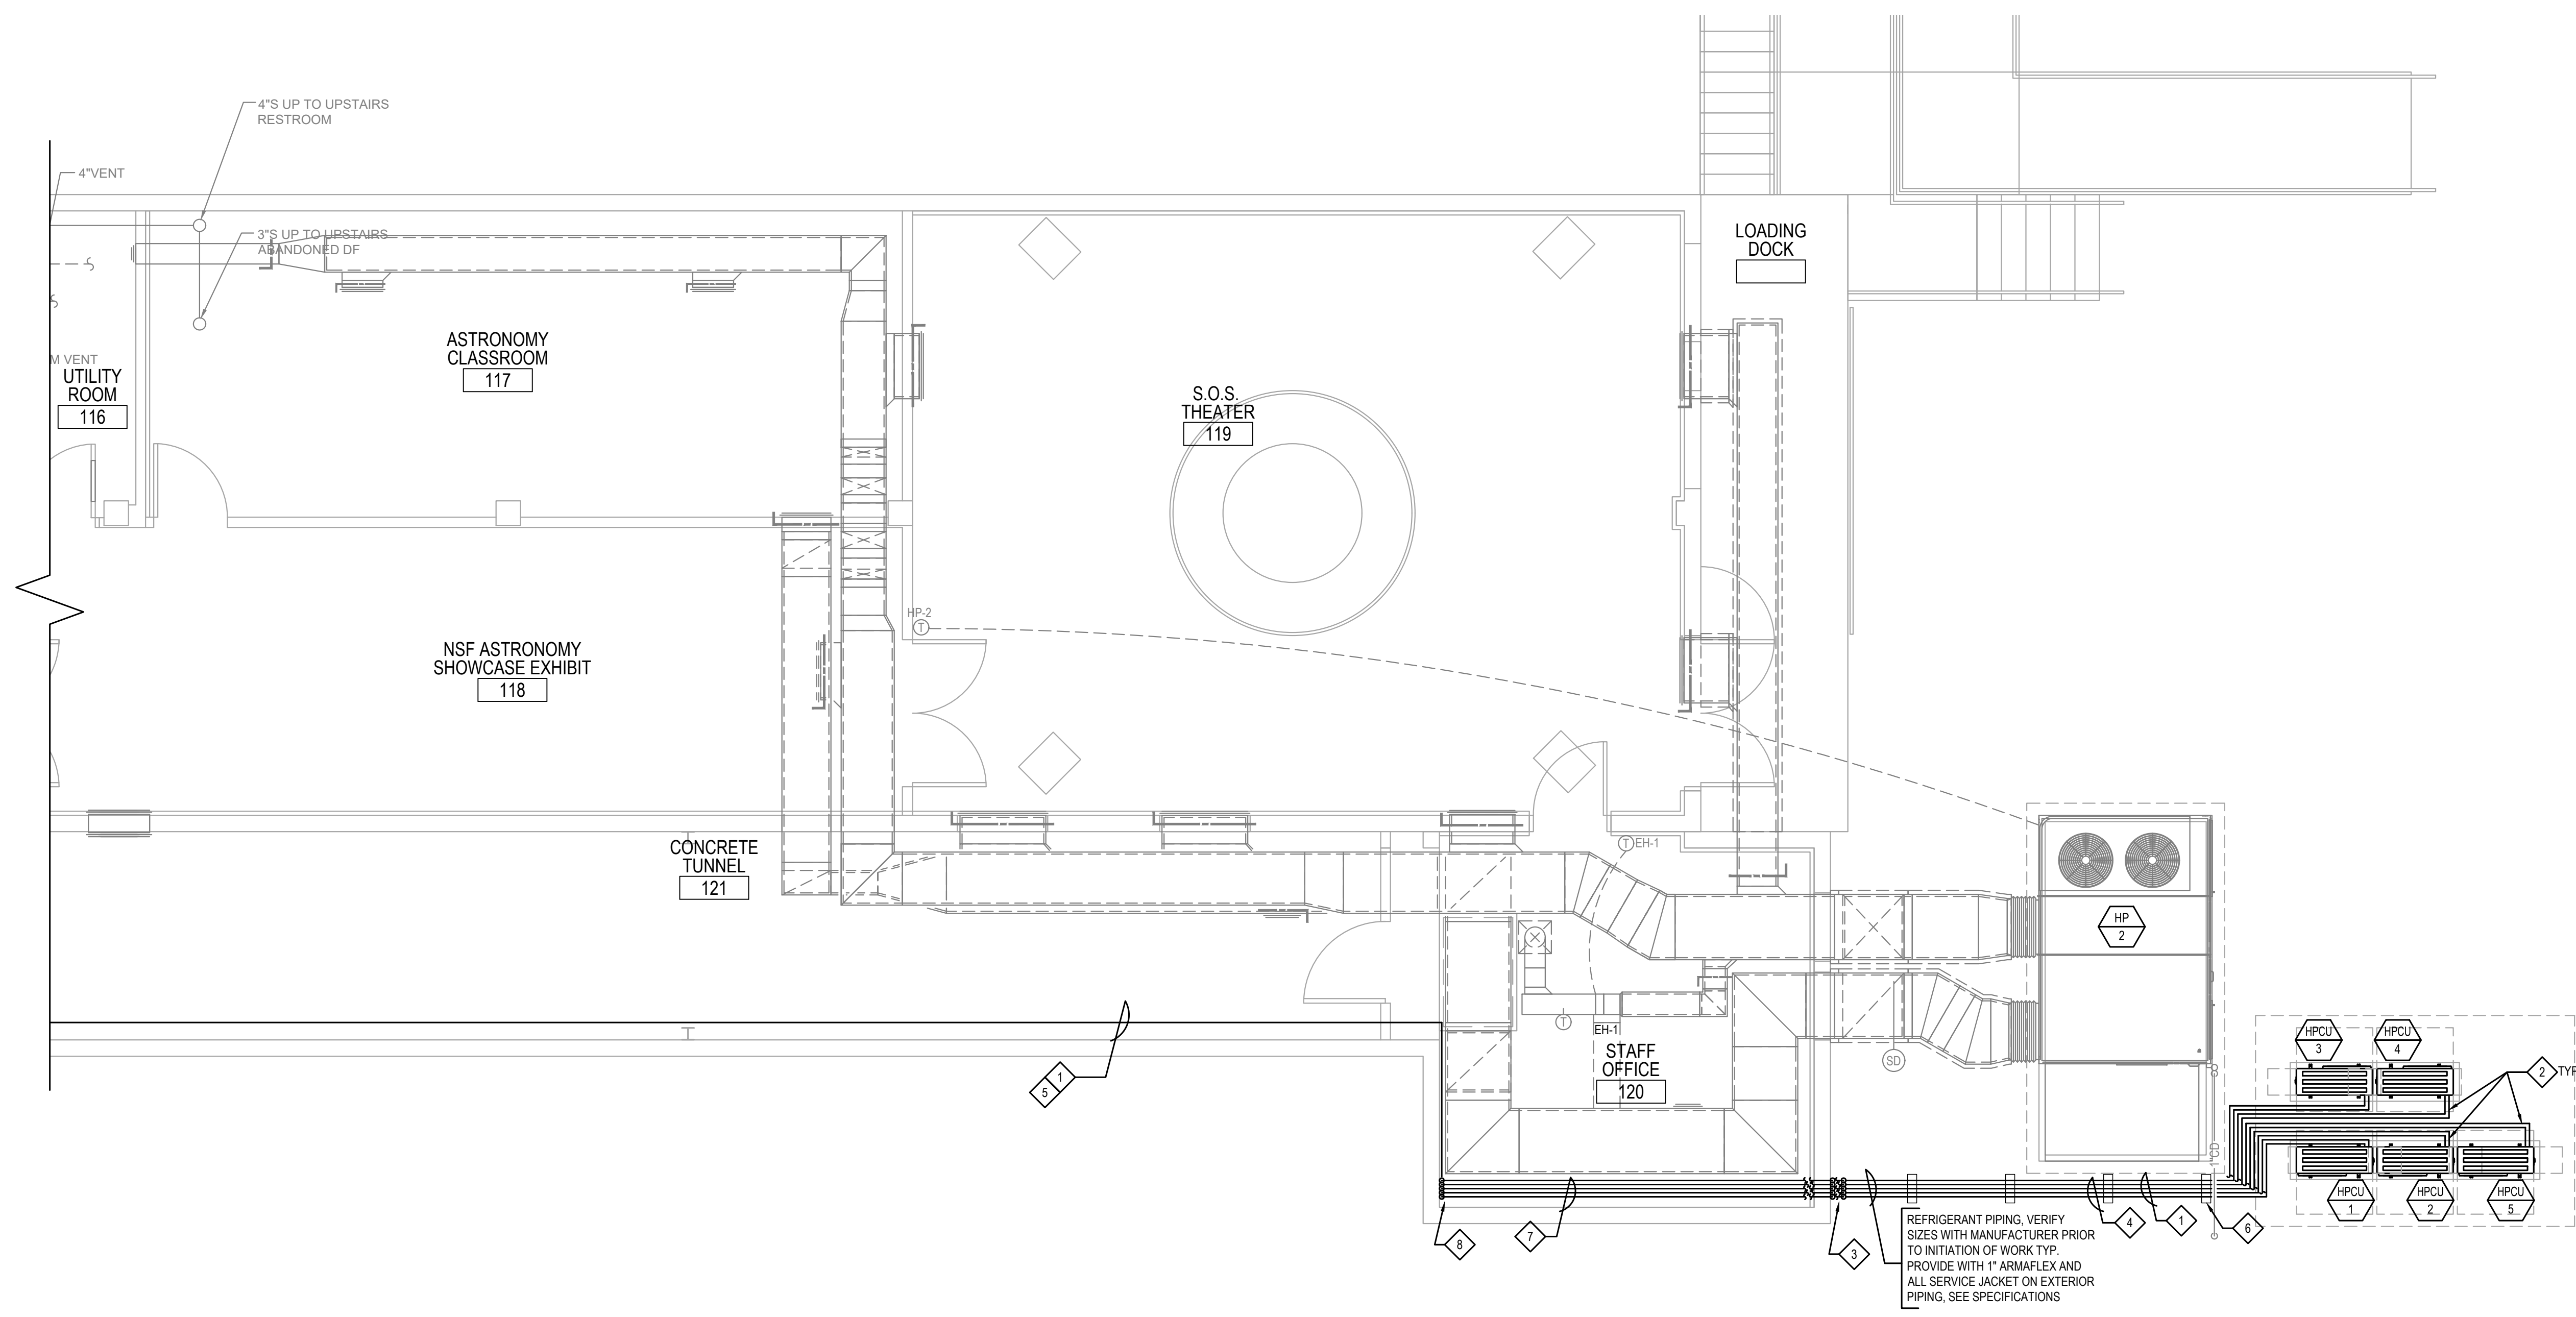
KITT PEAK - Sells, AZ 85634

△	DATE	DESCRIPTION
0	01/08/21	I.F.C.

PROJECT NUMBER: 11904.00
 DRAWN BY: FI
 CHECKED BY: FI
 CAD FILE: 11904.00-M2.3
 SCALE: AS SHOWN

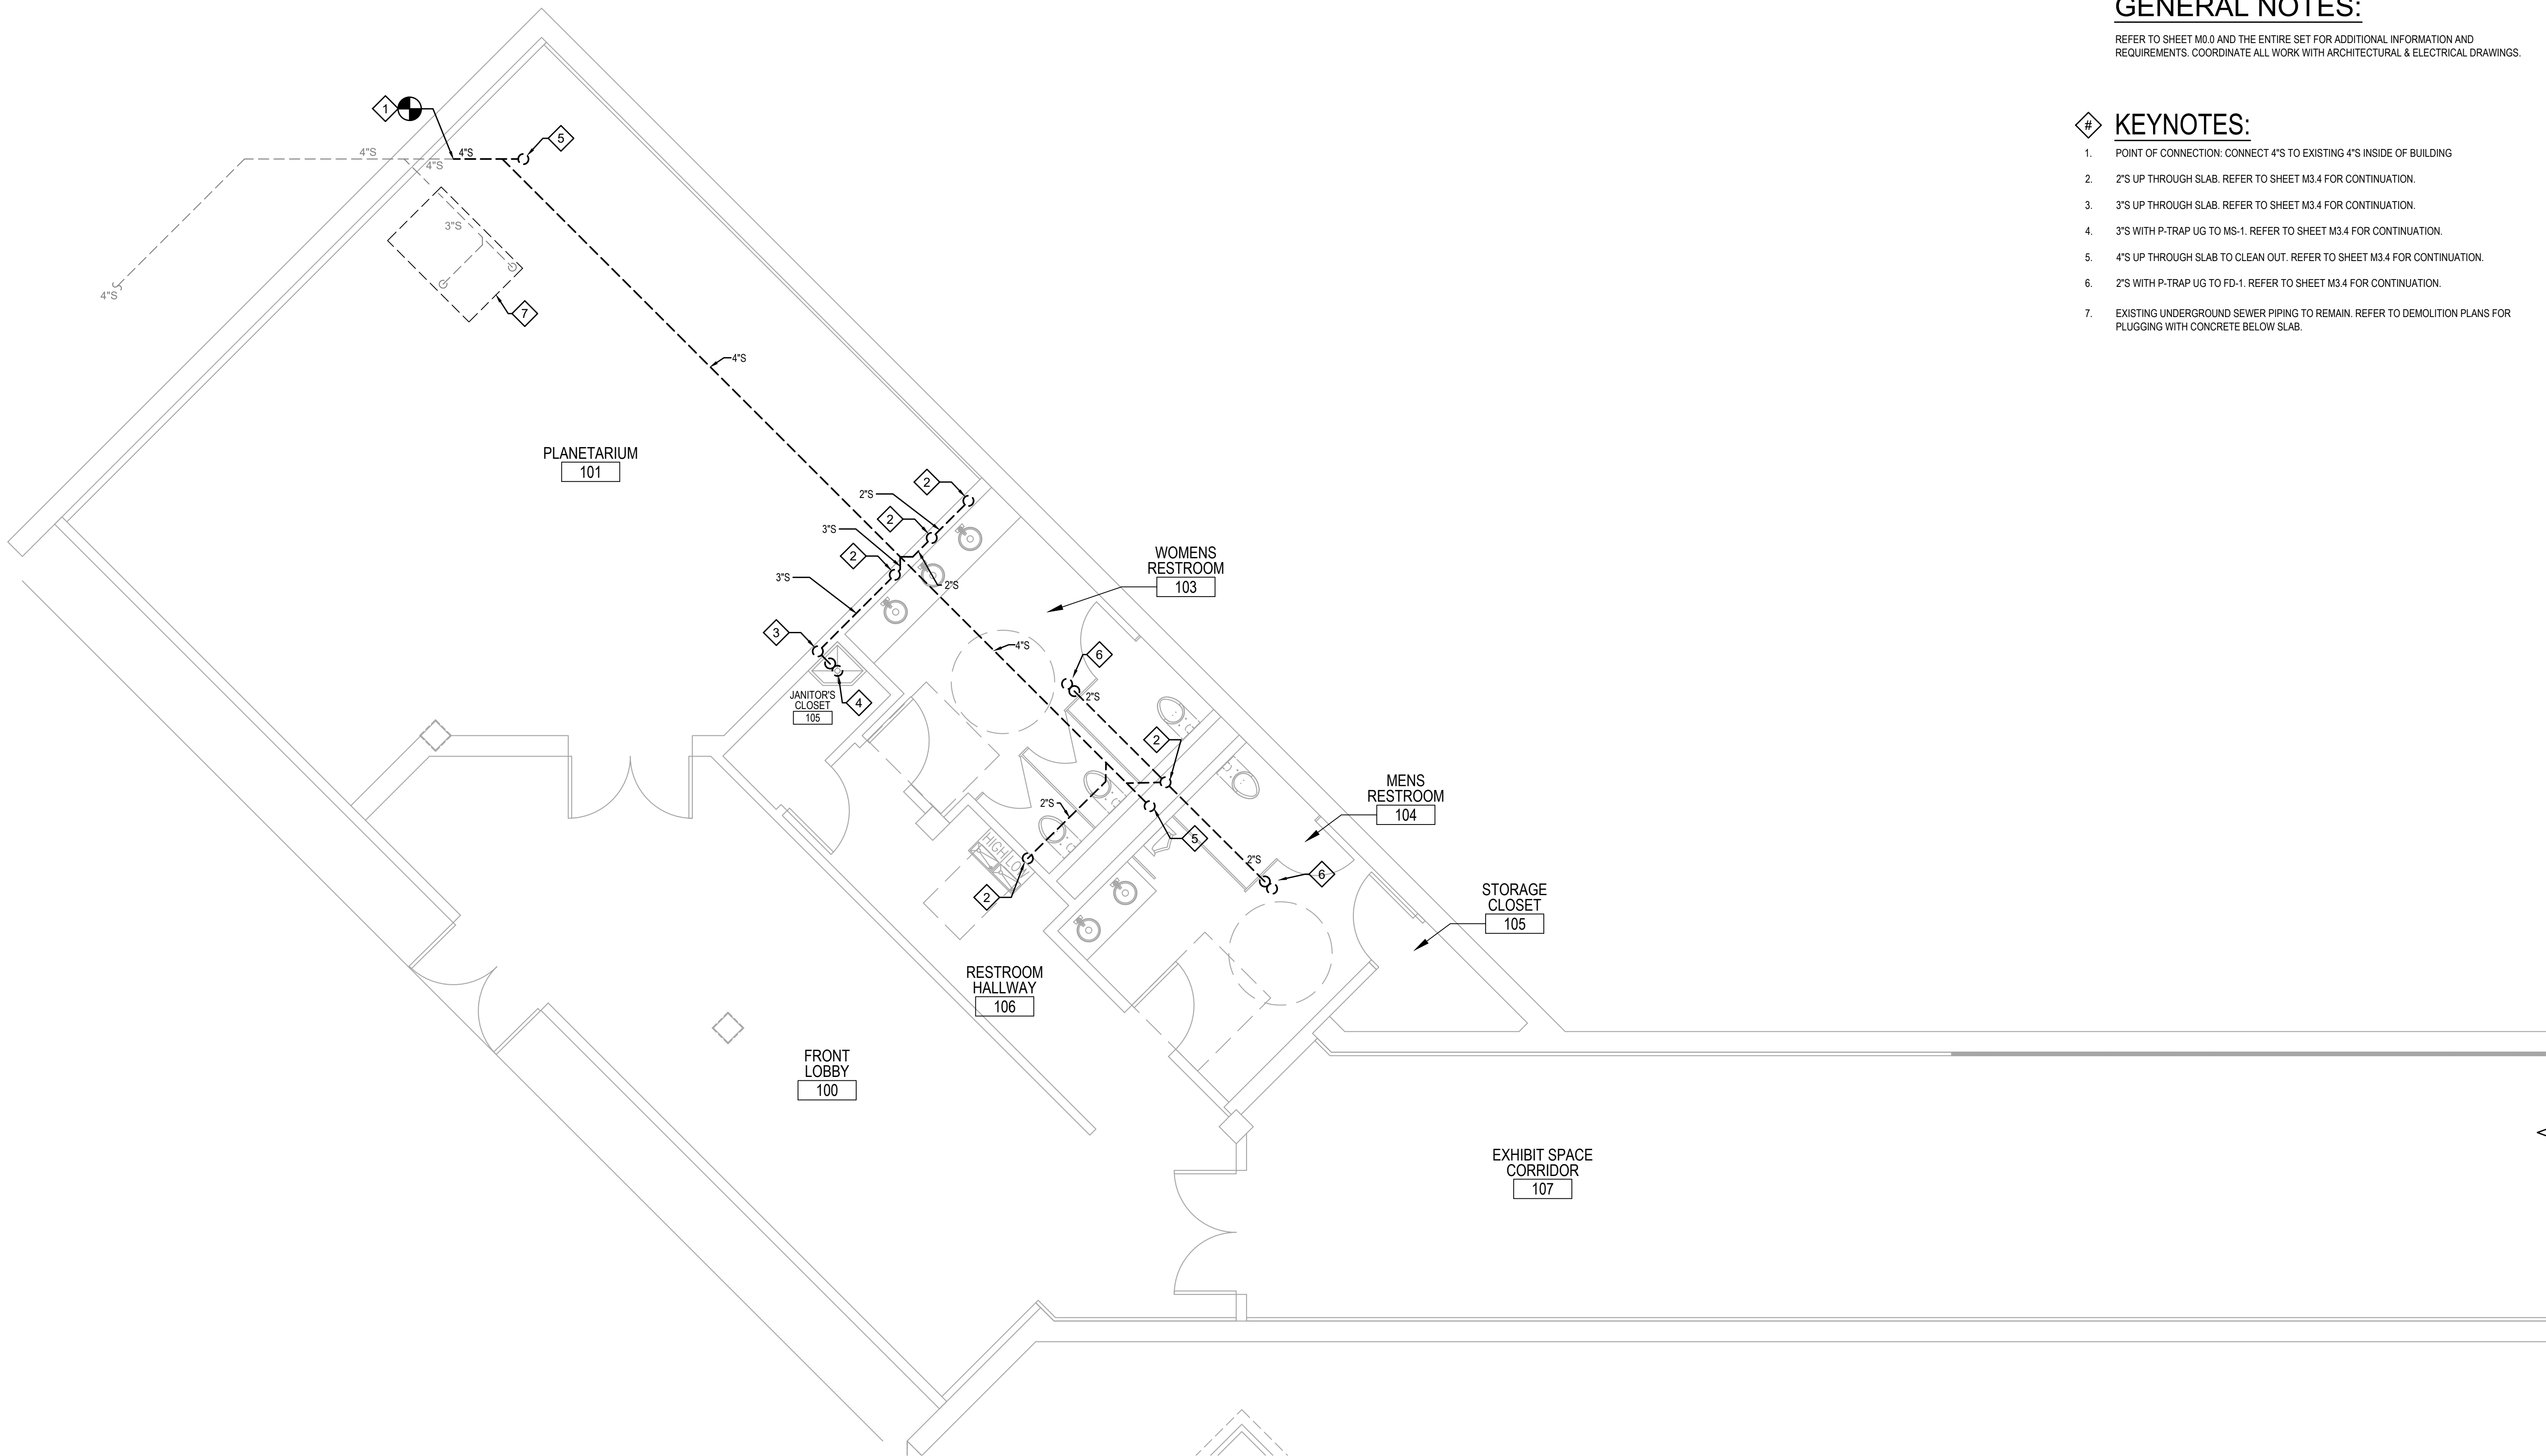
MECHANICAL
 PIPING
 RENOVATION PLANS

M2.3



1 MECHANICAL PIPING RENOVATION PLAN
 1ST LEVEL

SCALE: 1/4"=1'-0"





GENERAL NOTES:


REFER TO SHEET M0.0 AND THE ENTIRE SET FOR ADDITIONAL INFORMATION AND REQUIREMENTS. COORDINATE ALL WORK WITH ARCHITECTURAL & ELECTRICAL DRAWINGS.

KEYNOTES:

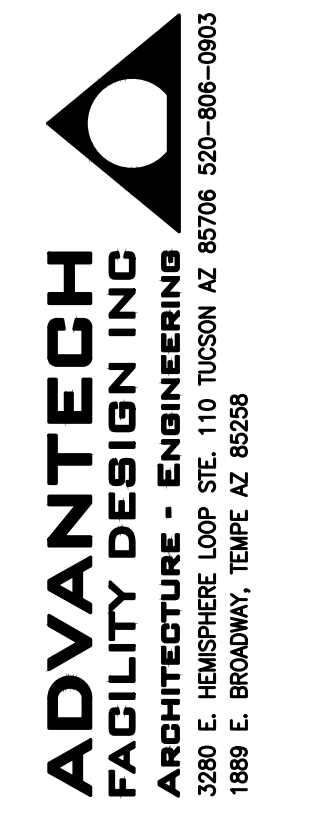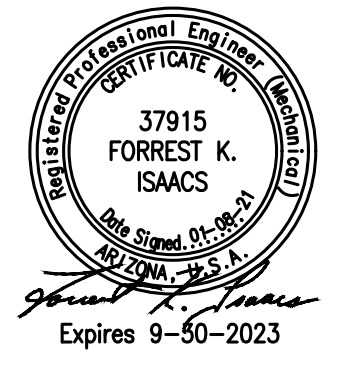1. POINT OF CONNECTION: CONNECT 4"S TO EXISTING 4"S INSIDE OF BUILDING
2. 2"S UP THROUGH SLAB. REFER TO SHEET M3.4 FOR CONTINUATION.
3. 3"S UP THROUGH SLAB. REFER TO SHEET M3.4 FOR CONTINUATION.
4. 3"S WITH P-TRAP UG TO MS-1. REFER TO SHEET M3.4 FOR CONTINUATION.
5. 4"S UP THROUGH SLAB TO CLEAN OUT. REFER TO SHEET M3.4 FOR CONTINUATION.
6. 2"S WITH P-TRAP UG TO FD-1. REFER TO SHEET M3.4 FOR CONTINUATION.
7. EXISTING UNDERGROUND SEWER PIPING TO REMAIN. REFER TO DEMOLITION PLANS FOR PLUGGING WITH CONCRETE BELOW SLAB.



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KITT PEAK - Sells, AZ 85634

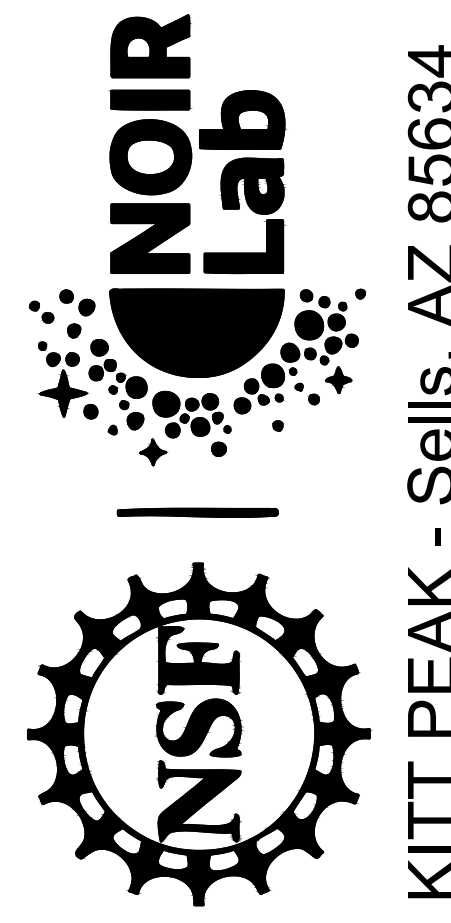△	DATE	DESCRIPTION
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1 MECHANICAL PLUMBING RENOVATION PLAN
UNDERGROUND

SCALE: 1/4"=1'-0"

PROJECT NUMBER: 11904.00
DRAWN BY: FI
CHECKED BY: FI
CAD FILE: 11904.00-M3.2
SCALE: AS SHOWN

MECHANICAL
PLUMBING
RENOVATION PLANS

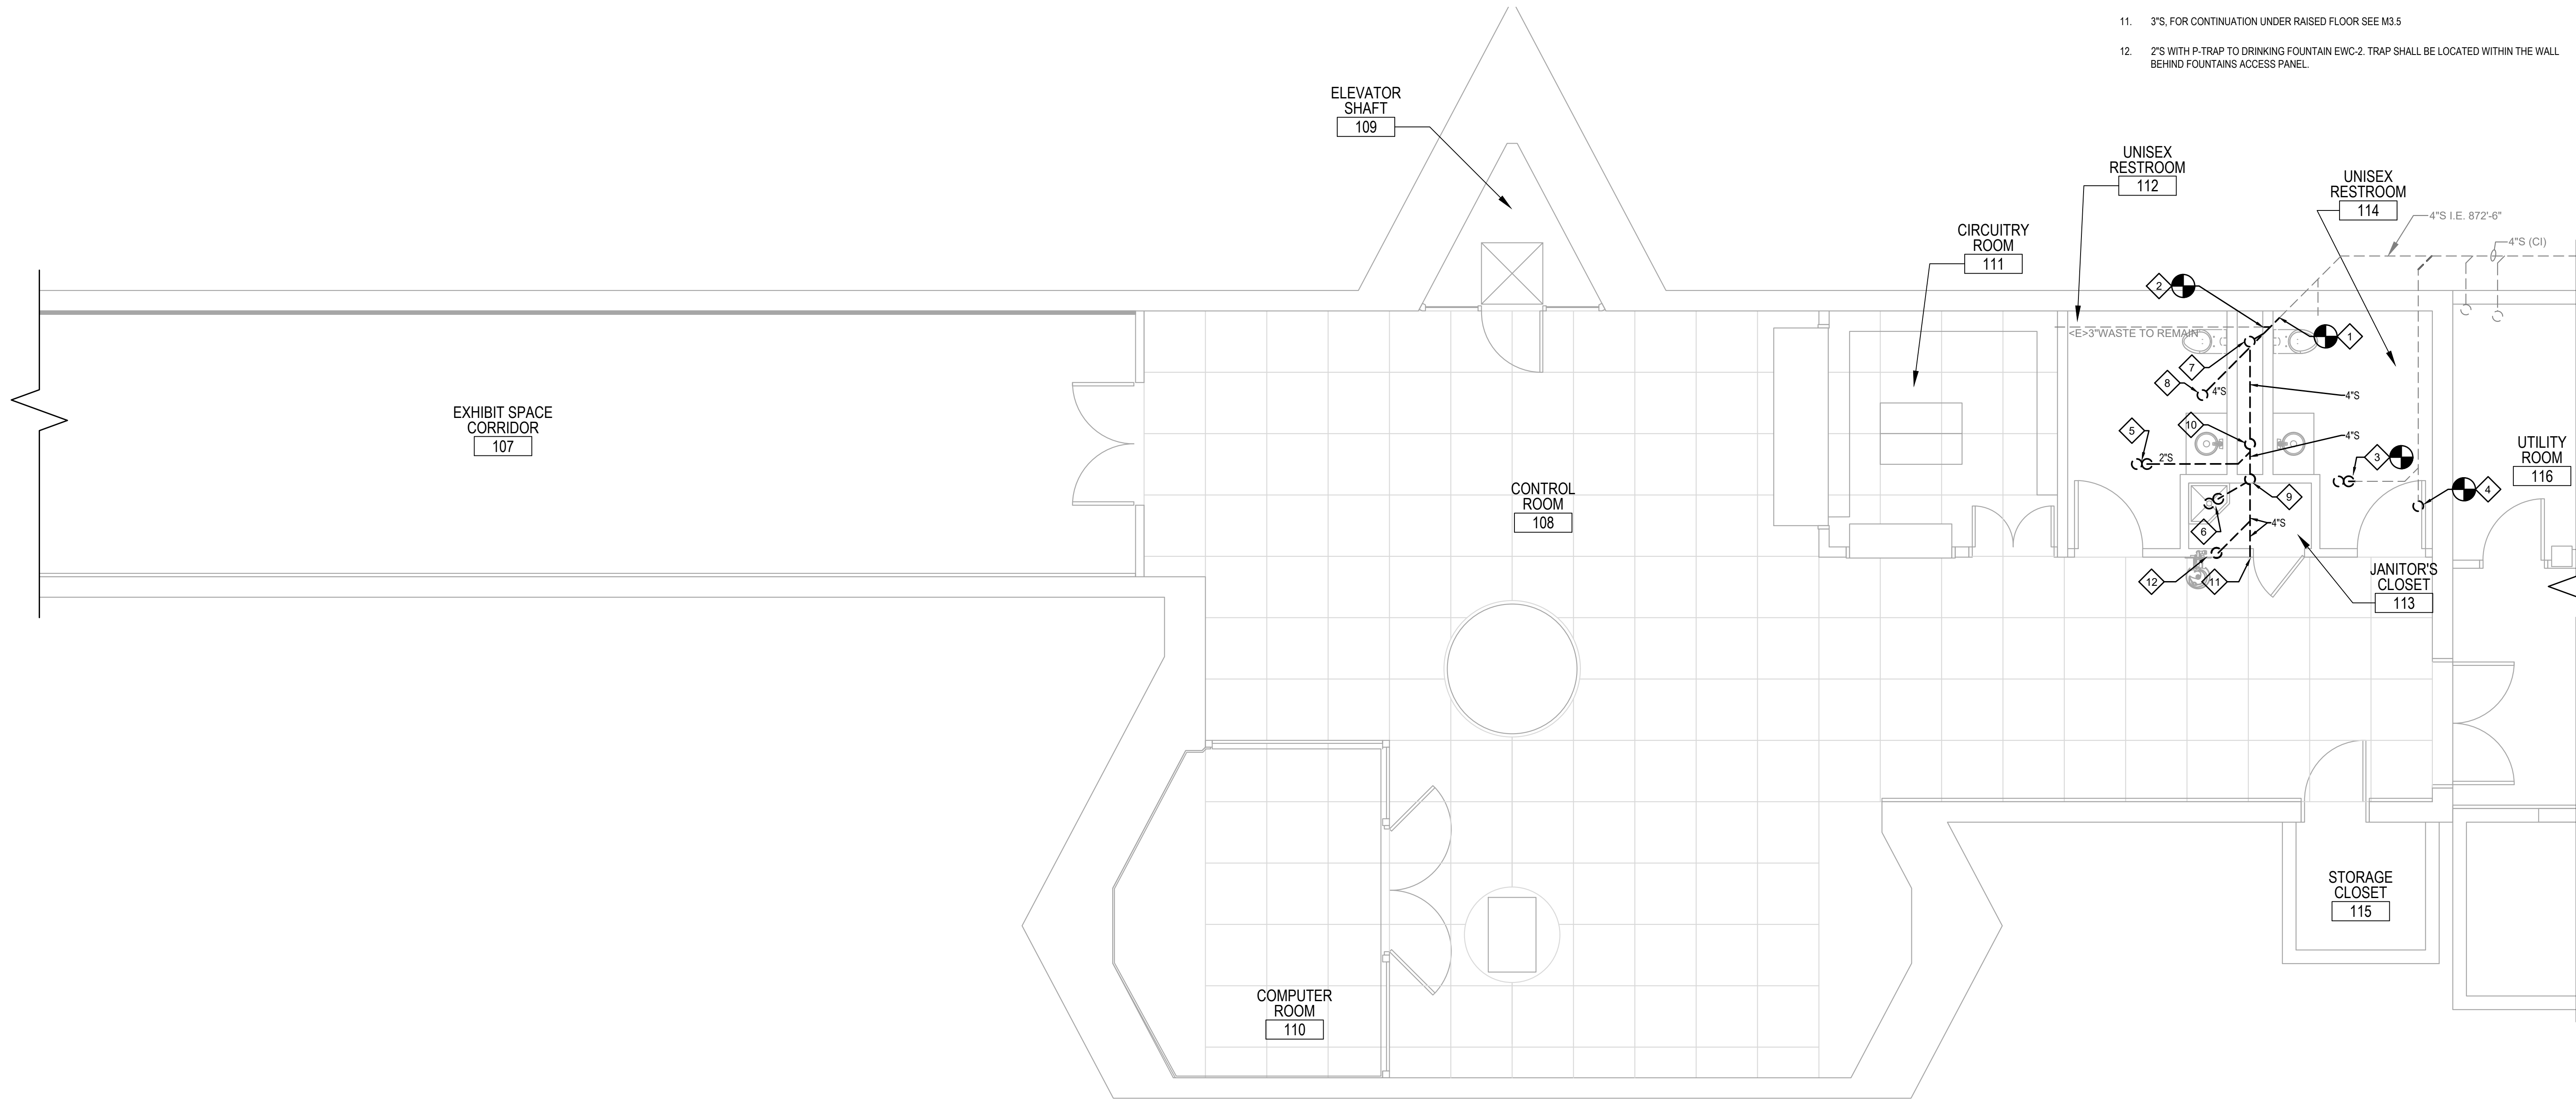
M3.2

GENERAL NOTES:

REFER TO SHEET M0.0 AND THE ENTIRE SET FOR ADDITIONAL INFORMATION AND REQUIREMENTS.


KEYNOTES:

1. CONNECT 4'S TO EXISTING 4'S.
2. CONNECT EXISTING 3'S TO NEW 4'S.
3. PROVIDE 2" FD-1 AND P-TRAP WITH TRAP SEAL AND AND CONNECT TO THE EXISTING 2'S UG. REFER TO M9 SHEET FOR FIXTURE INFORMATION.
4. PROVIDE 2" FCO AND CONNECT TO EXISTING SOIL BELOW SLAB. REFER TO M9 SHEET FOR FIXTURE INFORMATION.
5. 2" FD-1 AND P-TRAP WITH TRAP SEAL.
6. 3'S WITH P-TRAP TO MOP SINK MS-1.
7. 4'S UP THROUGH SLAB. REFER TO SHEET M3.5 FOR CONTINUATION.
8. 4'S UP TO 4" FCO. REFER TO SHEET M3.5 FOR CONTINUATION.
9. 3'S UP TO 3" WCO AND VENT. REFER TO SHEET M3.5 FOR CONTINUATION.
10. 2'S UP THROUGH SLAB FOR LAVS. REFER TO SHEET M3.5 FOR CONTINUATION.
11. 3'S, FOR CONTINUATION UNDER RAISED FLOOR SEE M3.5
12. 2'S WITH P-TRAP TO DRINKING FOUNTAIN EWC-2. TRAP SHALL BE LOCATED WITHIN THE WALL BEHIND FOUNTAINS ACCESS PANEL.




1 MECHANICAL PLUMBING RENOVATION PLAN
UNDERGROUND

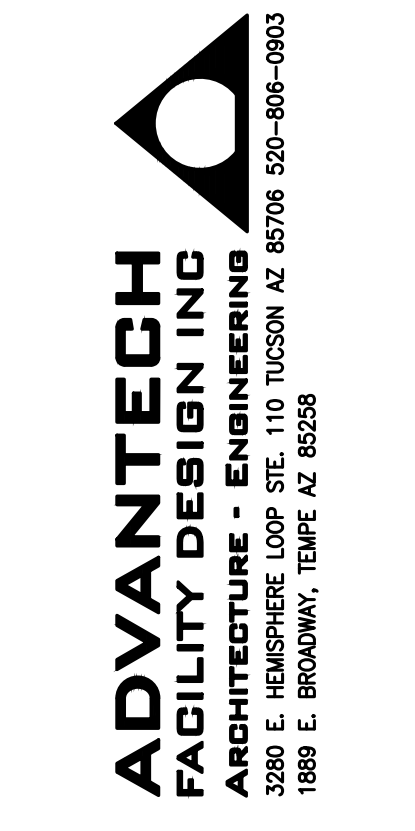SCALE: 1/4"=1'-0"



WINDOWS ON
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OUTREACH

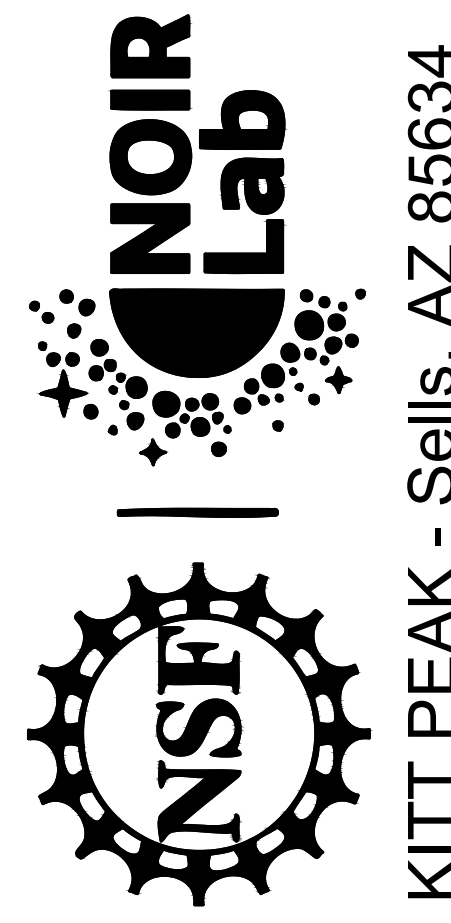


KITT PEAK - Sells, AZ 85634

△	DATE	DESCRIPTION
0	01/08/21	I.F.C.

PROJECT NUMBER: 11904.00
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CAD FILE: 11904.00-M3.3
SCALE: AS SHOWN

MECHANICAL
PLUMBING
RENOVATION PLANS

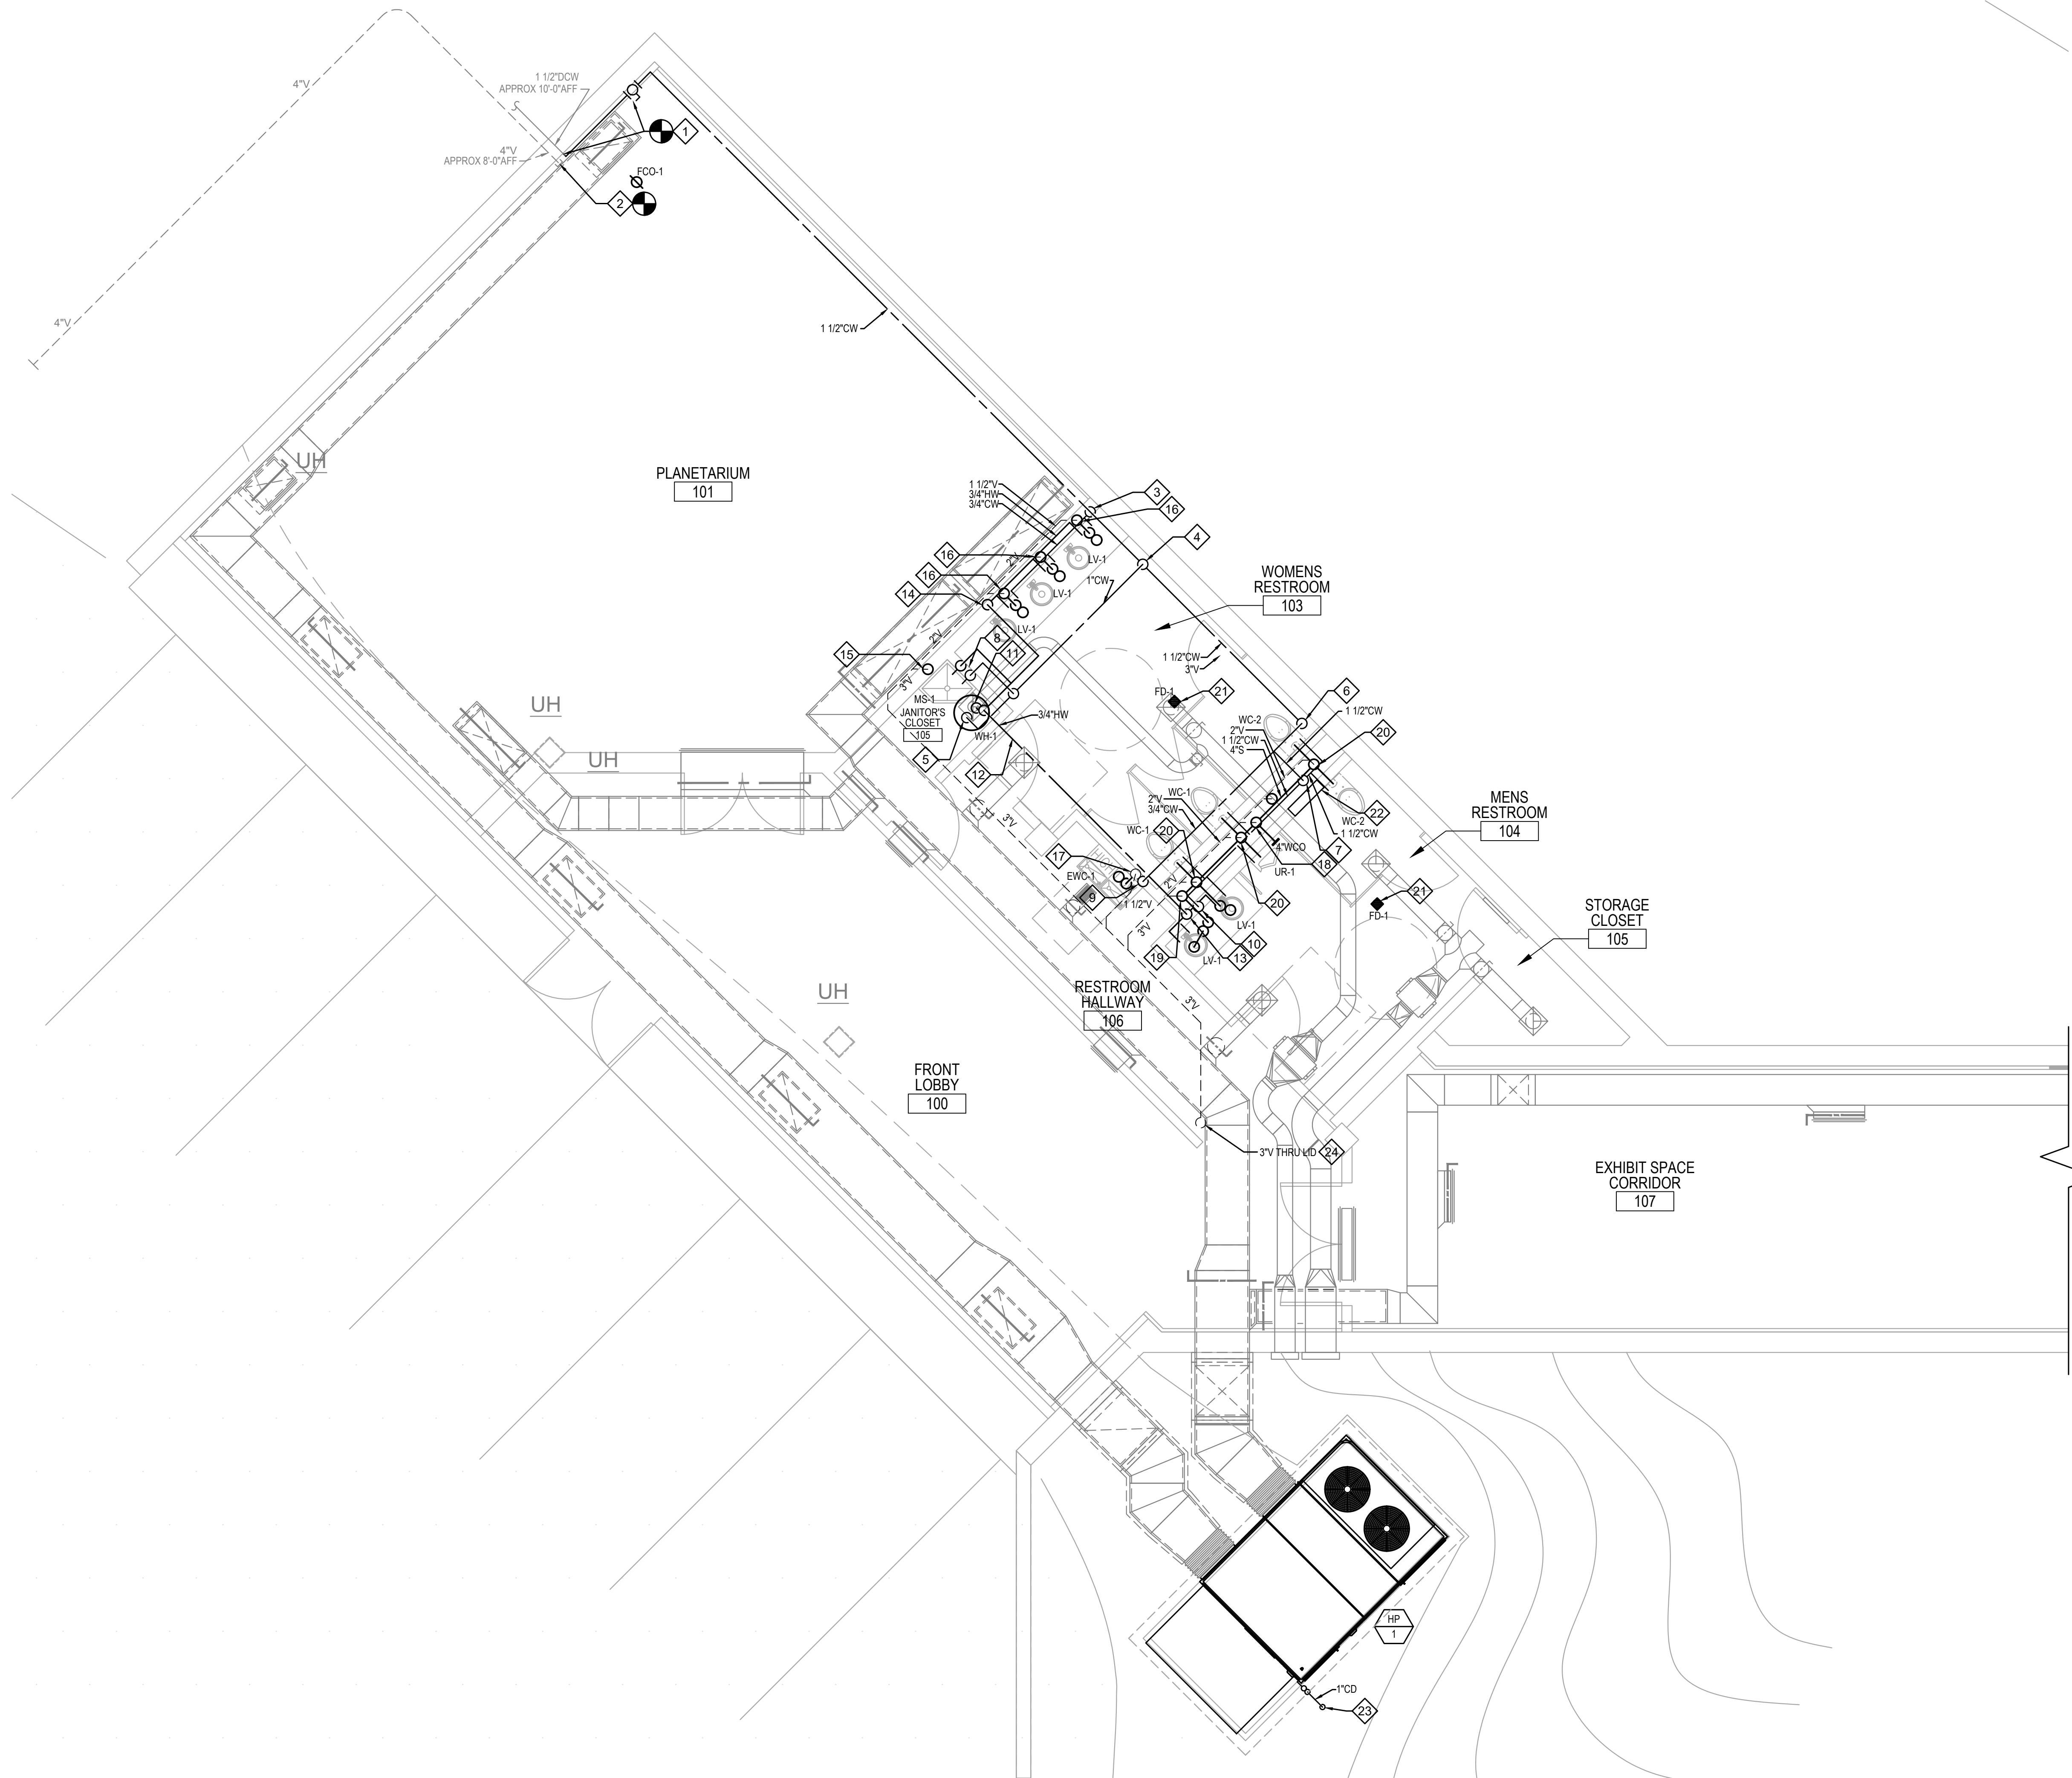M3.3




GENERAL NOTES:


REFER TO SHEET M0.0 AND THE ENTIRE SET FOR ADDITIONAL INFORMATION AND REQUIREMENTS. COORDINATE ALL WORK WITH ARCHITECTURAL & ELECTRICAL DRAWINGS.

KEYNOTES:

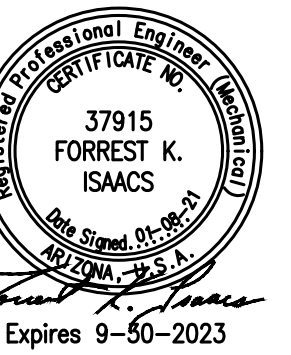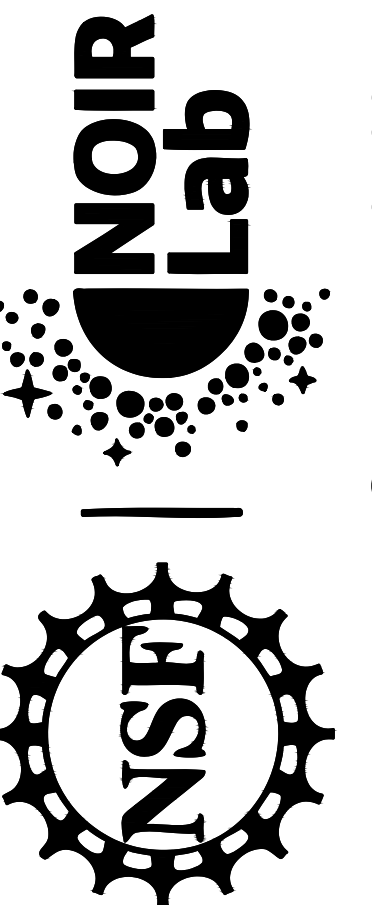1. POINT OF CONNECTION: CONNECT 1 1/2" CW TO EXISTING 1 1/2" CW AT APPROX 10'-0" AFF. INSTALL NEW SOV IN RUN WHERE SHUTOFF VALVE IS NOT BEHIND DUCTWORK, COORDINATE LOCATION WITH DUCT LAYOUT.
2. POINT OF CONNECTION: CAP EXISTING 4" V AND ABANDON IN PLACE.
3. 3/4" CW FROM 1 1/2" CW HEADER. DROP DOWN IN CHASE AND ROUTE TO FIXTURES.
4. 1" CW FROM TOP OF 1 1/2" CW HEADER. ROUTE OVERHEAD TO WH-1 IN JANITORS CLOSET.
5. 1" CW ROUTED TO WH-1. REFER TO M9 SHEET FOR WH-1 INFORMATION.
6. 1 1/2" CW ROUTED UP OVERHEAD, SPLIT AND ROUTE 3/4" CW TO WALL AT EWC-1, AND ROUTE 1 1/2" CW TO CHASE.
7. 1 1/2" CW ROUTED DOWN INTO CHASE TO SUPPLY FIXTURES.
8. 3/4" CW AND 3/4" HW DOWN IN WALL FOR CONNECTION TO MS-1. REFER TO M9 SHEET FOR FIXTURE INFORMATION.
9. 3/4" CW DOWN IN WALL. ELBOW OUT OF WALL AND TRANSITION TO 1/2" CW FOR CONNECTION TO EWC-1.
10. 3/4" CW DOWN IN WALL. ELBOW OUT OF WALL AND TRANSITION TO 1/2" CW FOR CONNECTION TO LV-1.
11. 1" HW FROM WH-1 TO DISTRIBUTION.
12. 3/4" HW ROUTED OVERHEAD TO CHASE TO SUPPLY LV-1 FIXTURES IN MENS RESTROOM.
13. 3/4" HW DOWN IN WALL. ELBOW OUT OF WALL. SPLIT, AND TRANSITION TO 1/2" HW TO FEED TWO LV-1 FIXTURES.
14. 3/4" HW DOWN IN WALL. ROUTE IN WALL TO SERVE LV-1 FIXTURES.
15. 3" S UP FROM UNDERGROUND. INSTALL 3" WCO AND TRANSITION TO 1 1/2" V. ROUTE VENT UP IN WALL TO OVERHEAD.
16. 2" S UP FROM UNDERGROUND. INSTALL 2" WCO AND TRANSITION TO 1 1/2" V. ROUTE VENT UP IN WALL TO OVERHEAD.
17. 2" S UP FROM UNDERGROUND. ROUTE UP IN WALL TO EWC-1.
18. 4" S UP FROM UNDERGROUND. SPLIT TO 4" S IN EACH DIRECTION.
19. 2" S UP IN CHASE.
20. 4" S UP IN CHASE FROM 4" S MAIN.
21. INSTALL FD-1. REFER TO UNDERGROUND SHEET M3.2 FOR CONTINUATION OF PIPING.
22. 2'-0" SQ ACCESS PANEL FOR SOV AND WHA. REFER TO M6 SHEET FOR DETAIL. REFER TO M8.1 SHEET FOR APPROX LOCATION.
23. 1" CONDENSATE FROM OUTDOOR HEAT PUMP UNIT. FIELD ROUTE AT GRADE AND ELBOW DOWN TO TERMINATE ABOVE THE DIRT AREA.
24. 3" V UP THROUGH CONCRETE LID. TERMINATE 36" ABOVE FINISHED GRADE. SEE DETAIL 11M6.1. SEE ARCHITECTURAL AND STRUCTURAL DOCUMENTS FOR ADDITIONAL INFORMATION.



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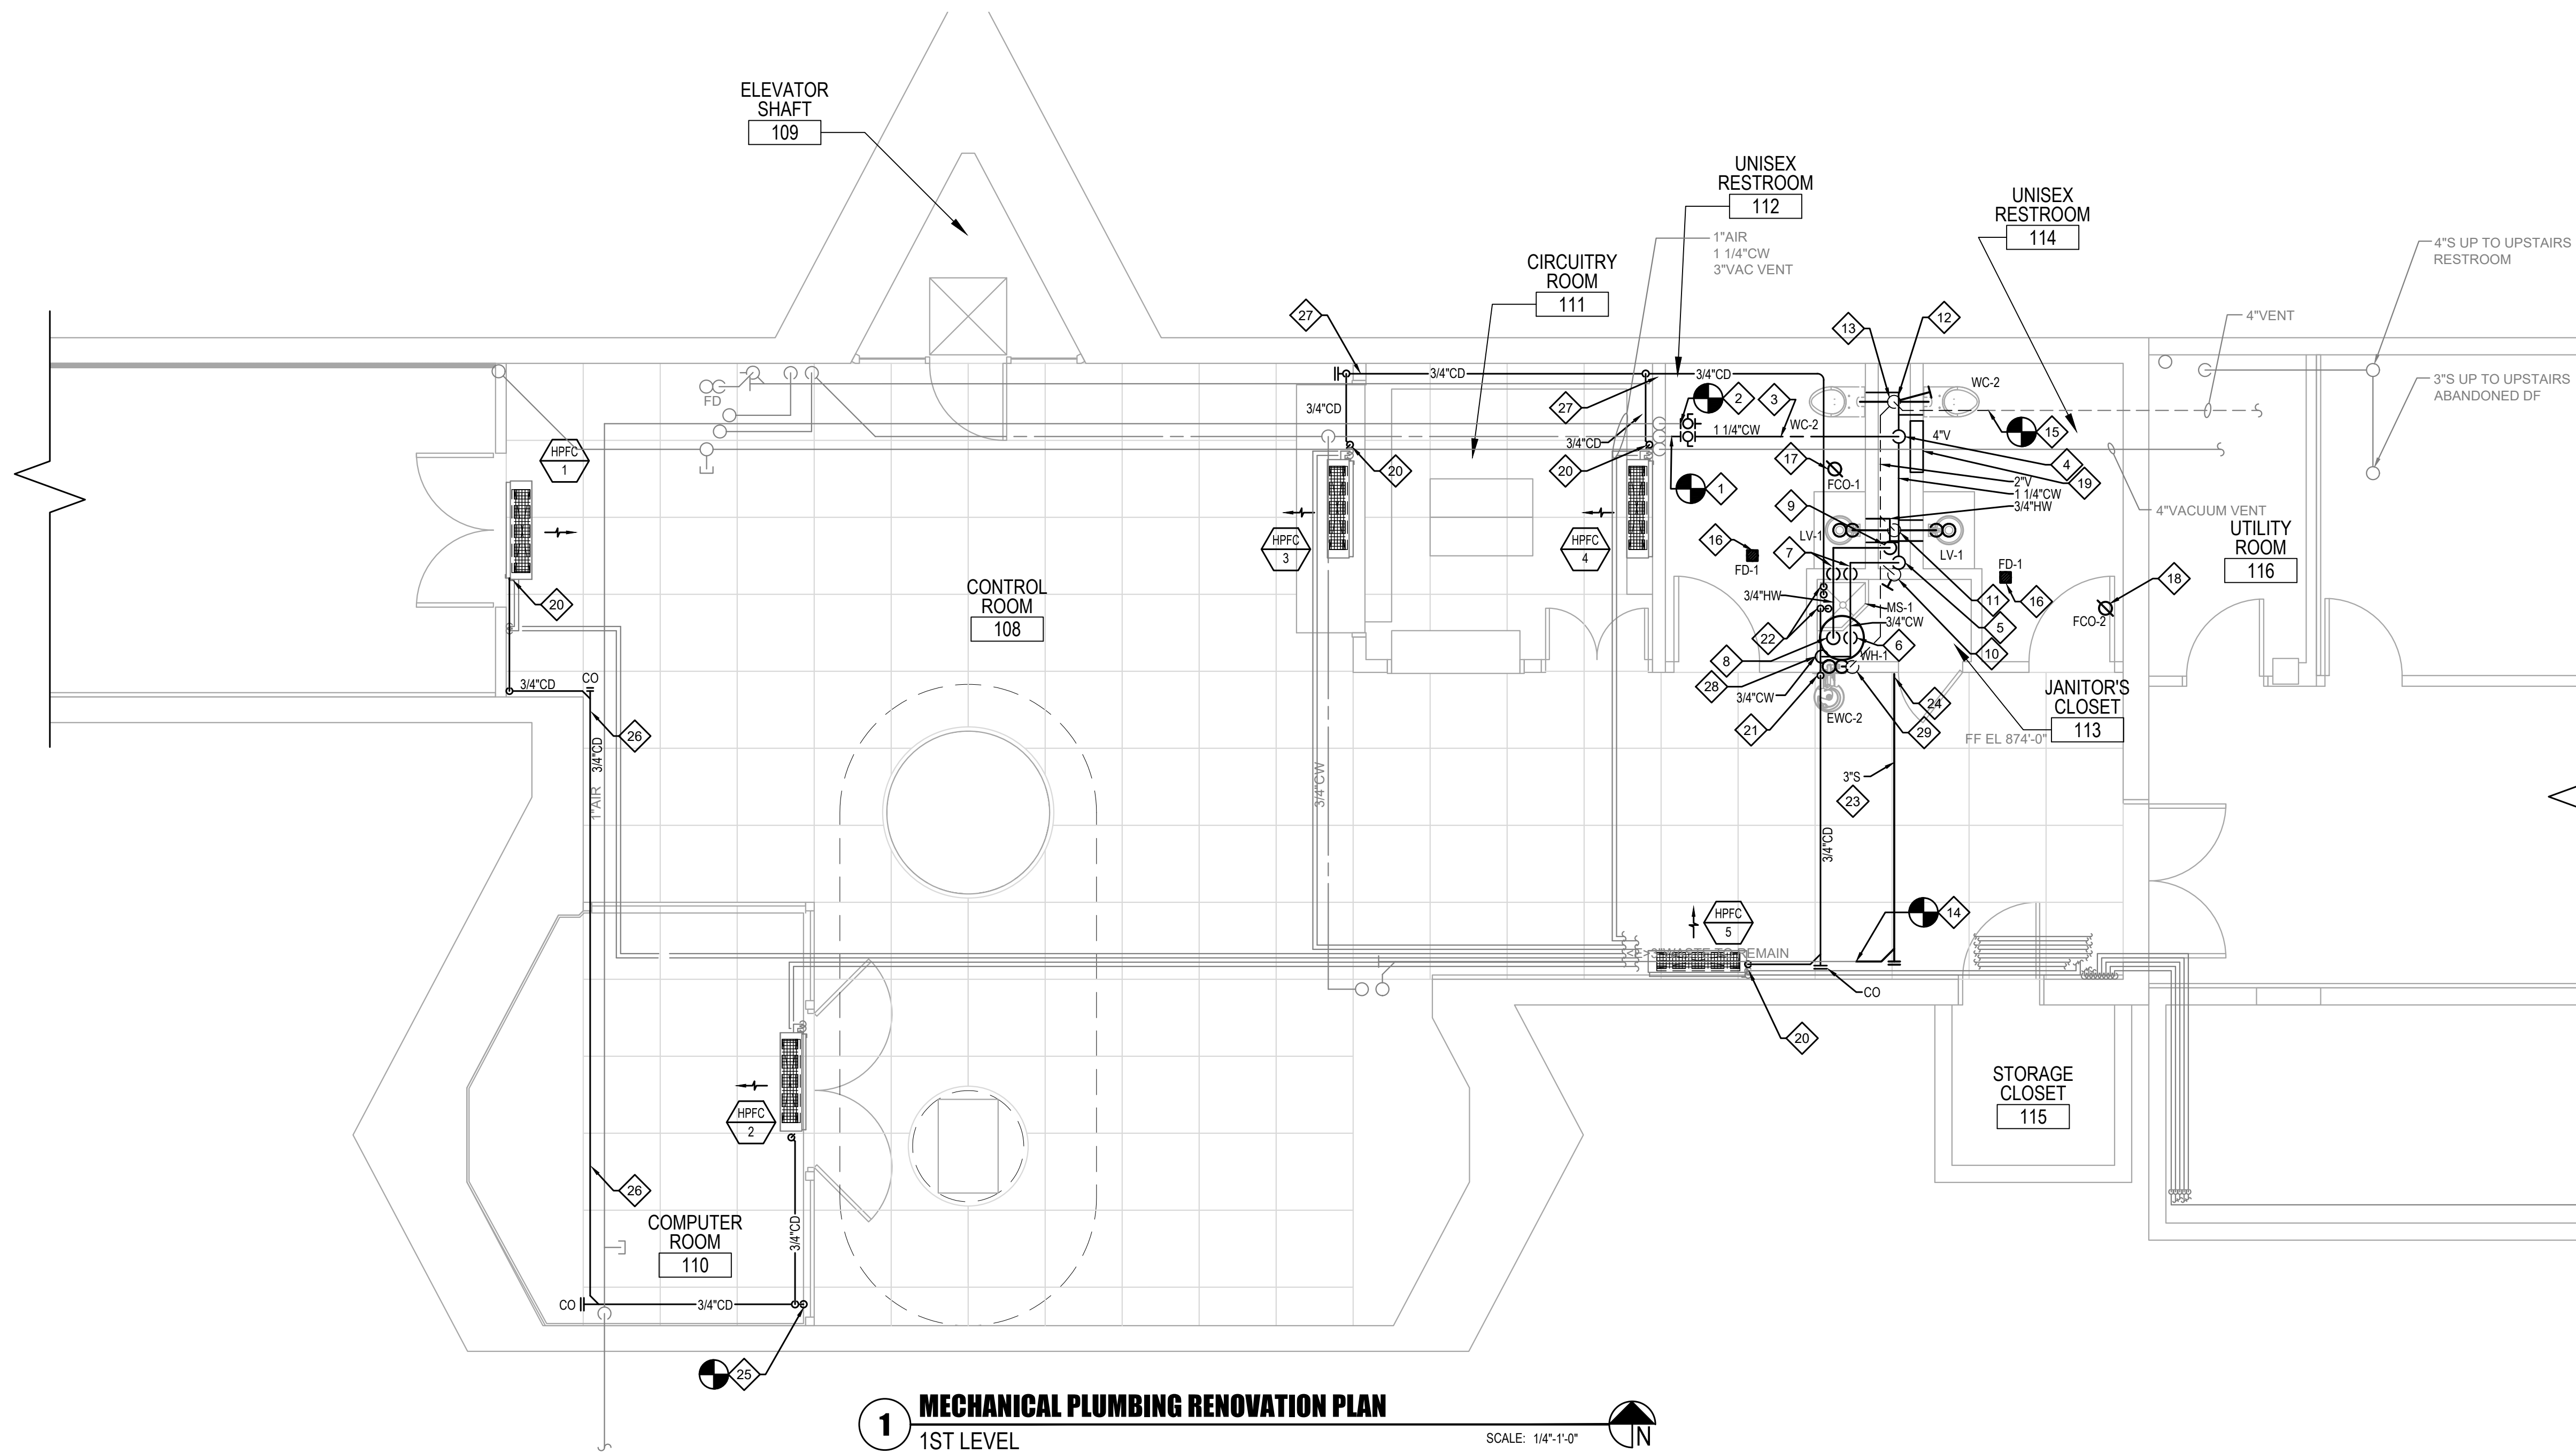
△	DATE	DESCRIPTION
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PROJECT NUMBER: 11904.00
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MECHANICAL
 PLUMBING
 RENOVATION PLANS

M3.4





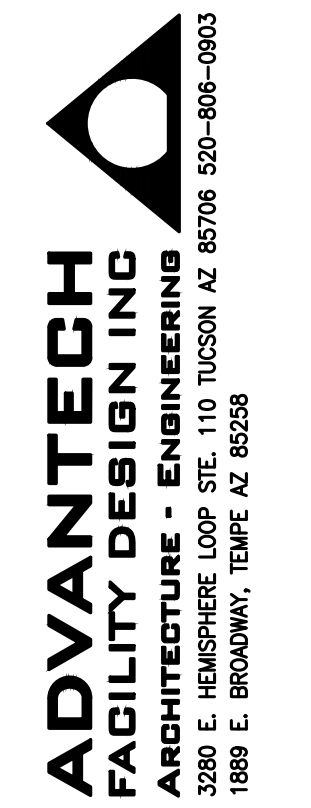
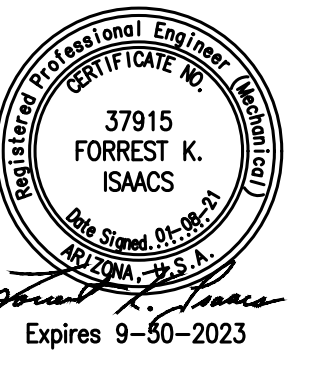
1 MECHANICAL PLUMBING RENOVATION PLAN
 1ST LEVEL
 SCALE: 1/4"=1'-0"

GENERAL NOTES:


REFER TO SHEET M0.0 AND THE ENTIRE SET FOR ADDITIONAL INFORMATION AND REQUIREMENTS.

KEYNOTES:

1. POINT OF CONNECTION: CONNECT 1 1/4" CW TO EXISTING 1 1/4" CW. PROVIDE WITH LINE SIZE ISOLATION BALL VALVE AT POINT OF CONNECTION.
2. CONNECT 1" ISOLATION VALVE AND FIELD ROUTE AND CONNECT TO REMAINING ACTIVE LINES. COORDINATE WITH OWNER FOR SYSTEMS THAT SHALL REMAIN ACTIVE AND ROUTE AS REQUIRED. REFER TO DEMO PLANS FOR PIPING THAT WAS REMOVED.
3. 1 1/4" CW ROUTED OVERHEAD TO CHASE.
4. 1 1/4" CW FROM OVERHEAD. DROP DOWN INTO CHASE TO SUPPLY FIXTURES.
5. 1" CW UP IN CHASE TO OVERHEAD AND ROUTE WEST IN OVERHEAD TO SUPPLY MS-1 AND WH-1.
6. 3/4" CW ROUTED TO WH-1. REFER TO M9.1 SHEET FOR WH-1 INFORMATION.
7. 3/4" CW AND 3/4" HW DOWN IN WALL FOR CONNECTION TO MS-1. REFER TO M9.1 SHEET FOR FIXTURE INFORMATION.
8. 3/4" HW FROM WH-1 TO DISTRIBUTION.
9. 3/4" HW FROM 3/4" HW DISTRIBUTION ROUTED IN OVERHEAD TO CHASE TO SUPPLY LV-1 FIXTURES IN RESTROOMS.
10. 3" S UP FROM UNDERGROUND. INSTALL 3" WCO AND TRANSITION TO 1 1/2" V. ROUTE VENT UP IN WALL TO OVERHEAD.
11. 2" S UP FROM UNDERGROUND. INSTALL 2" WCO AND TRANSITION TO 1 1/2" V. ROUTE VENT UP IN WALL TO OVERHEAD.
12. 4" S UP FROM UNDERGROUND. ROUTE TO MAIN AND CONNECT.
13. 4" S UP FROM UNDERGROUND IN CHASE.
14. POINT OF CONNECTION, CONNECT NEW 3" S TO EXISTING 3" S IN RAISED FLOOR PLENUM.
15. POINT OF CONNECTION: 4" V FROM FIXTURES. CONNECT TO EXISTING 4" V PIPING IN OVERHEAD.
16. INSTALL FD-1. REFER TO UNDERGROUND SHEET FOR CONTINUATION OF PIPING.
17. INSTALL FCO-1. REFER TO UNDERGROUND SHEET FOR CONTINUATION OF PIPING.
18. INSTALL FCO-2. REFER TO UNDERGROUND SHEET FOR CONTINUATION OF PIPING.
19. 2'-0" SO ACCESS PANEL FOR SOV AND WHA. REFER TO M6 SHEET FOR DETAIL. REFER TO M8.1 SHEET FOR APPROX LOCATION.
20. PROVIDE WITH SAUERMANN SI-30-208 CONDENSATE PUMP. PUMP CONDENSATE FROM UNIT UP AND ROUTE HORIZONTALLY WITH A MINIMUM 1/8" PER FOOT SLOPE AS SHOWN.
21. DROP 3/4" CD DOWN TO BELOW MAIN BEAM AND ELBOW INTO THE JANITORS ROOM.
22. 3/4" CD DROP DOWN EXPOSED ON WALL AND ELBOW AND TERMINATE ABOVE MOP SINK MS-1.
23. 3" S ROUTED UNDER RAISED FLOOR.
24. 3" S UNDER RAISED FLOOR AND TO UNDERGROUND, FOR CONTINUATION SEE M3.3.
25. 3/4" CD DOWN ON WALL TO BELOW RAISED FLOOR. CONNECT TO THE EXISTING 3/4" CONDENSATE ROUTED TO PIT BELOW.
26. ROUTE 3/4" CONDENSATE AS HIGH AS POSSIBLE AND ROUTE ALONG WALL AND OVER TO ABOVE SERVER CLOSET. ROUTE ABOVE SERVER CLOSET CEILING AS SHOWN.
27. ROUTE 3/4" CONDENSATE THOROUGH EXISTING WALL PENETRATIONS. ROUTE TO AVOID CONFLICT WITH EXISTING PIPING.
28. 3/4" CW DOWN ON WALL TO FILTER PROVIDED WITH WATER DISPENSER EWC-2. PROVIDE ISOLATION VALVE UPSTREAM AND DOWN STREAM OF FILTER. MOUNT FILTER ON WALL AND PIPE FROM FILTER TO WATER DISPENSER.
29. 1-1/2" VENT FROM WATER COOLER TO ABOVE.



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 OUTREACH

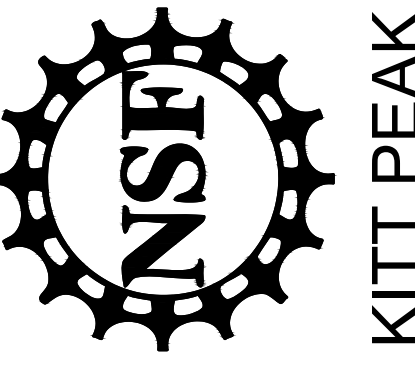


KITT PEAK - Sells, AZ 85634

△	DATE	DESCRIPTION
0	01/08/21	I.F.C.

PROJECT NUMBER: 11904.00
 DRAWN BY: FI
 CHECKED BY: FI
 CAD FILE: 11904.00-M3.5
 SCALE: AS SHOWN

MECHANICAL
 PLUMBING
 RENOVATION PLANS

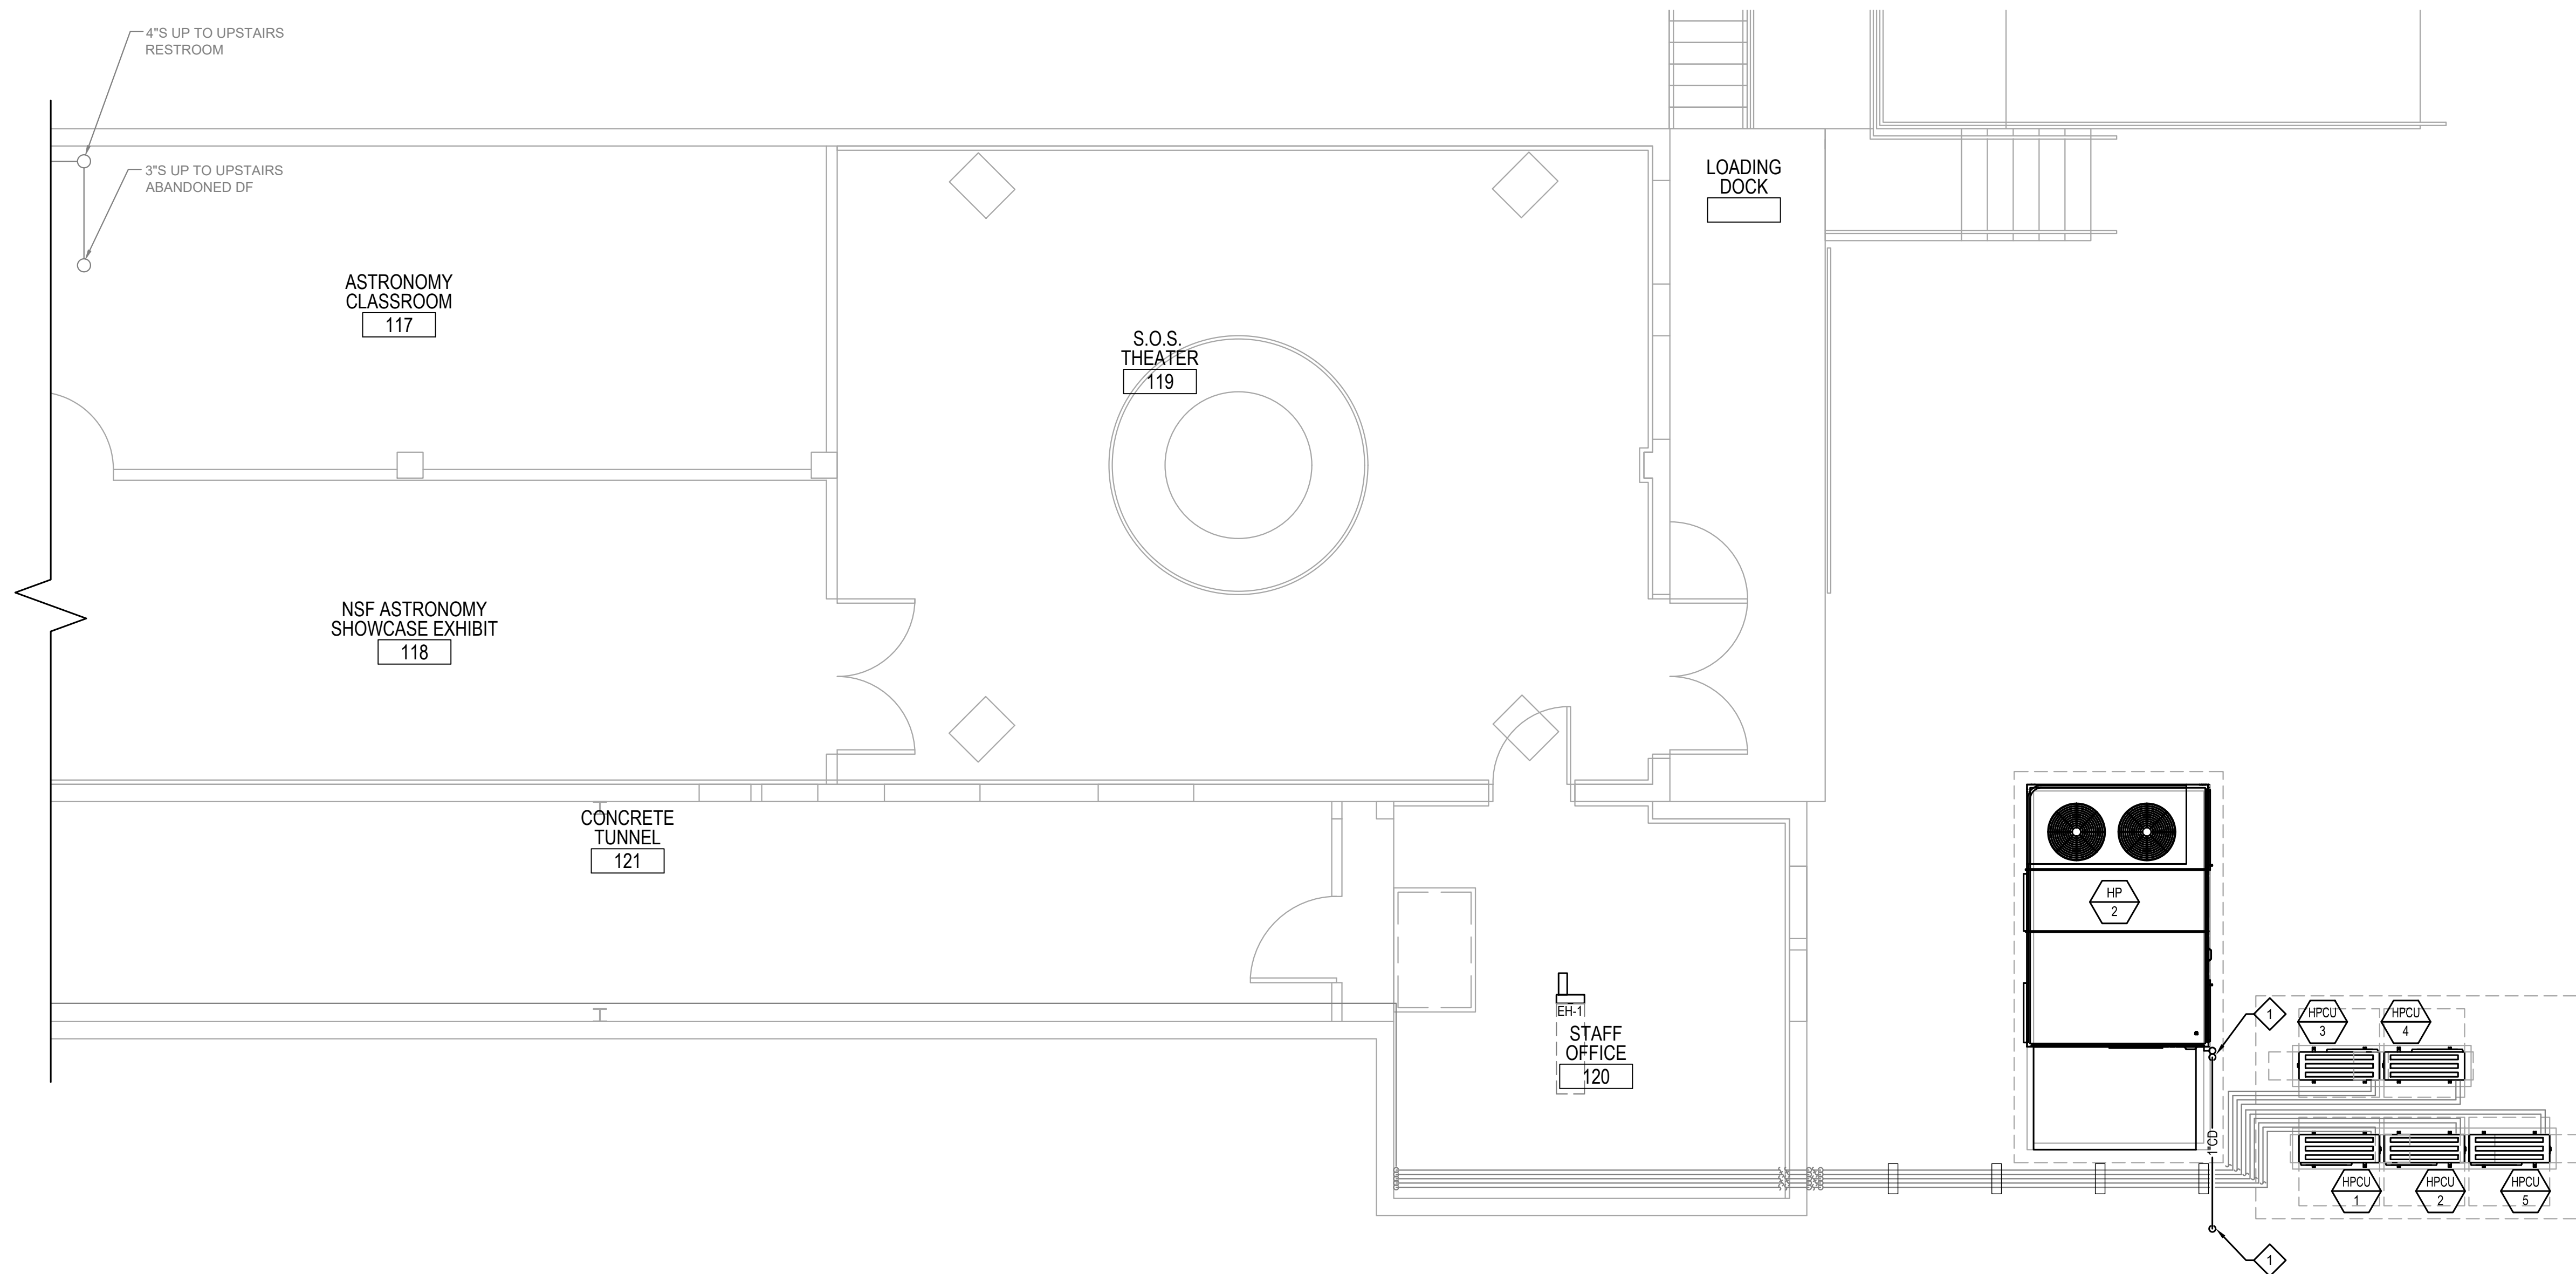M3.5





1 MECHANICAL PLUMBING RENOVATION PLAN
 1ST LEVEL
 SCALE: 1/4"=1'-0"

GENERAL NOTES:


- A. REFER TO SHEET M0.0 AND THE ENTIRE SET FOR ADDITIONAL INFORMATION AND REQUIREMENTS.
- B. PROVIDE REFRIGERANT CHARGE AS REQUIRED FOR TUBING LENGTHS INSTALLED PER MANUFACTURER'S REQUIREMENTS.
- C. HANG NEW PIPING PER DETAIL 6M6.1 AND THE SPECIFICATIONS.
- D. INSULATE REFRIGERANT LINES PER SPECIFICATIONS. INSULATION ON EXTERIOR OF BUILDING TO BE JACKETED PER SPECIFICATIONS.
- E. SUPPORT PIPING AT GRADE PER DETAIL 7M6.1 AND SPECIFICATIONS

KEYNOTES:

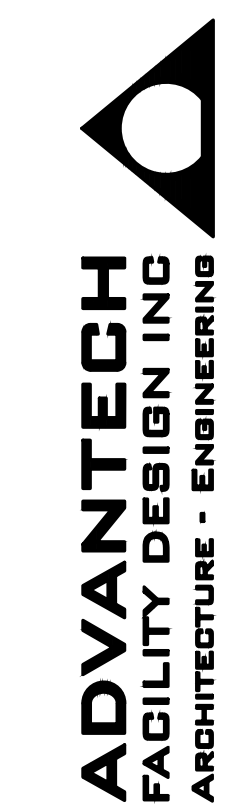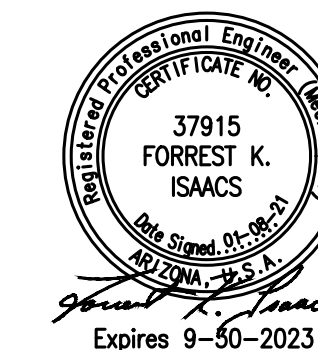- 1. 1"CONDENSATE FROM OUTDOOR HEAT PUMP UNIT. FIELD ROUTE AT GRADE AND ELBOW DOWN TO TERMINATE ABOVE THE DIRT AREA.



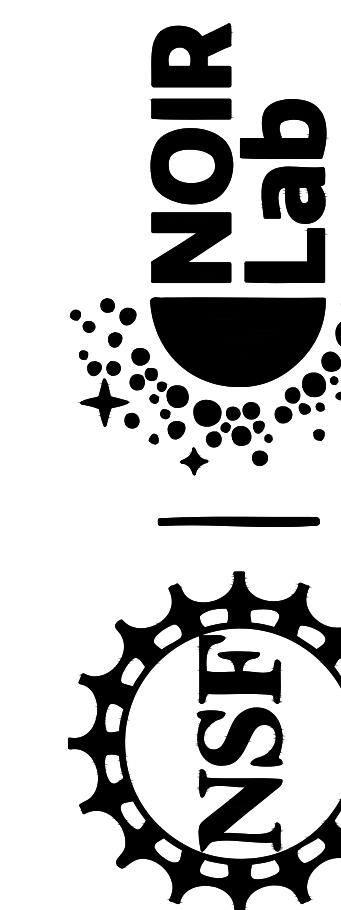WINDOWS ON
 THE UNIVERSE
 CENTER FOR
 ASTRONOMY
 OUTREACH




KITT PEAK - Sells, AZ 85634
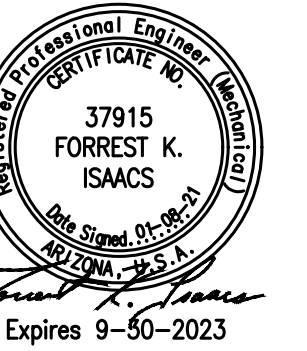
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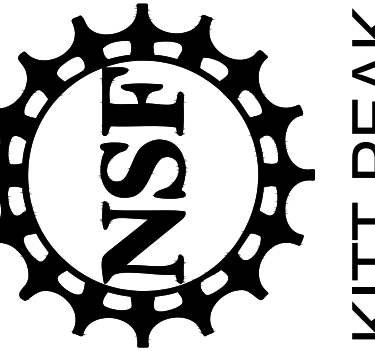
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MECHANICAL
 PLUMBING
 RENOVATION PLANS













M3.6



WINDOWS ON
THE UNIVERSE
CENTER FOR
ASTRONOMY
OUTREACH



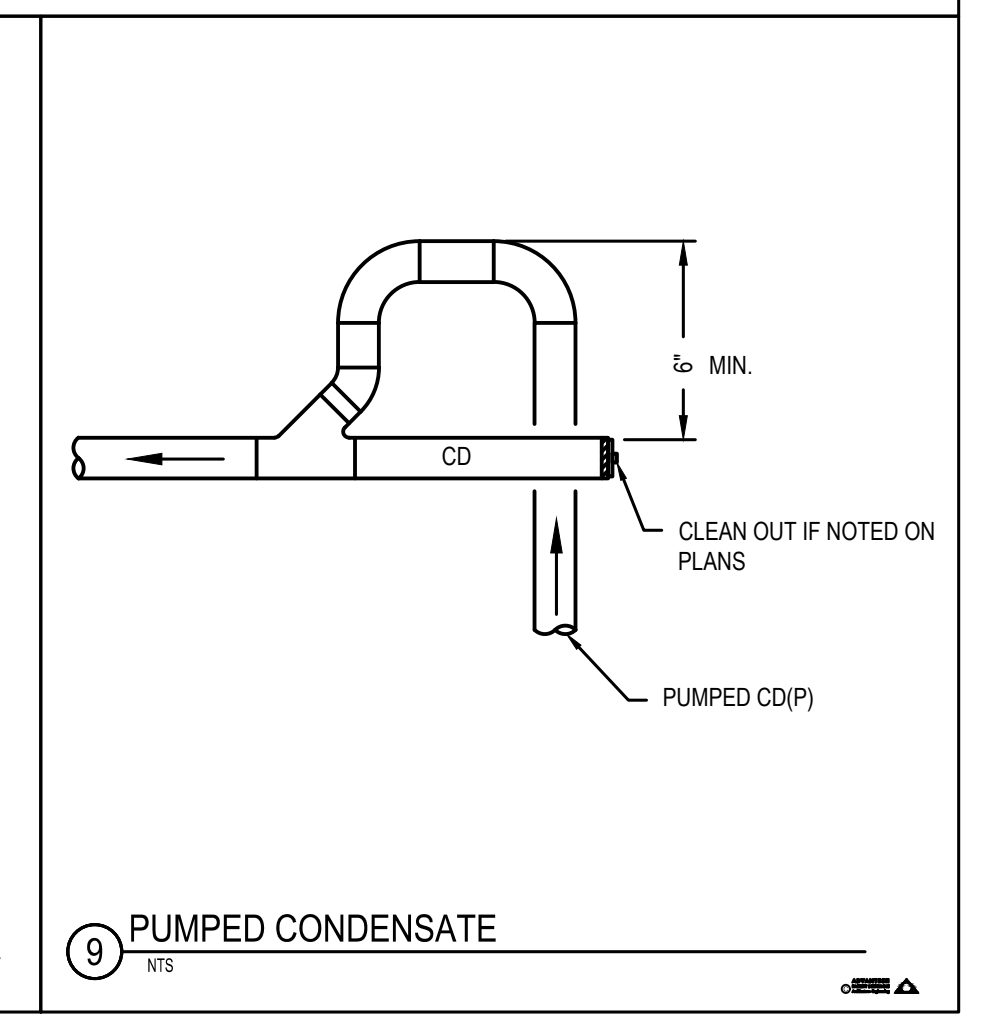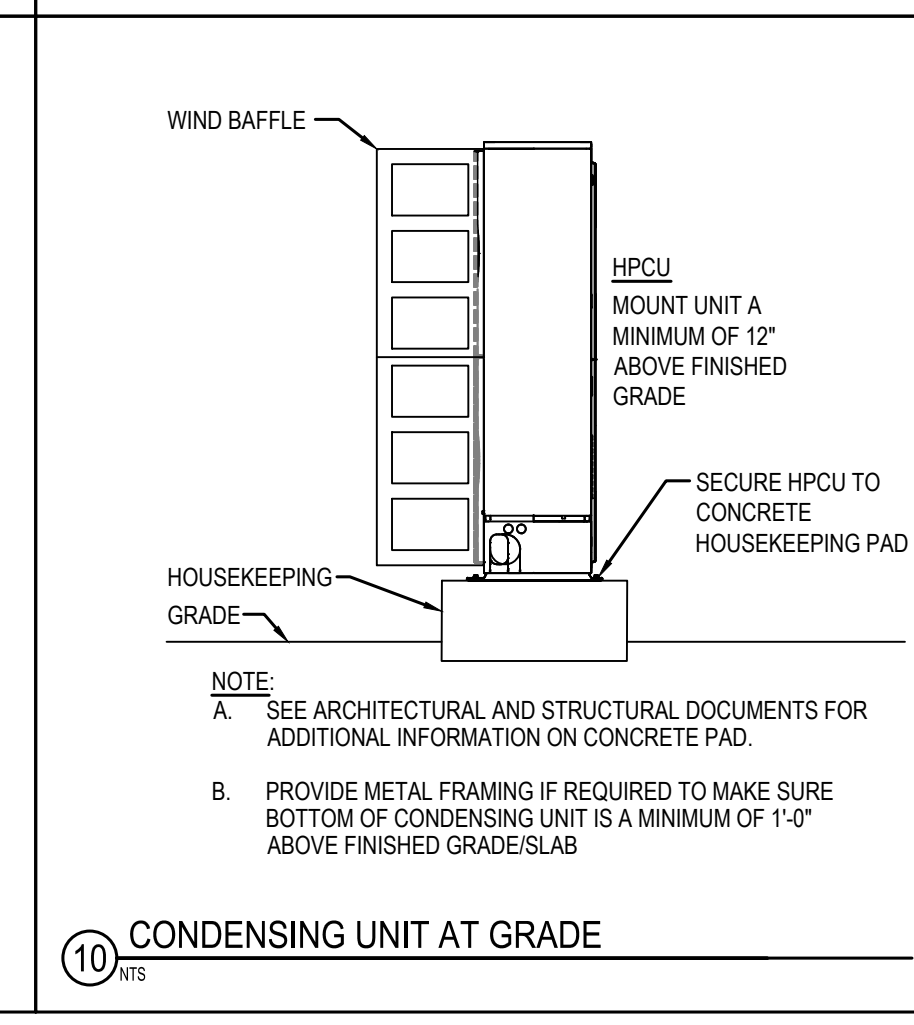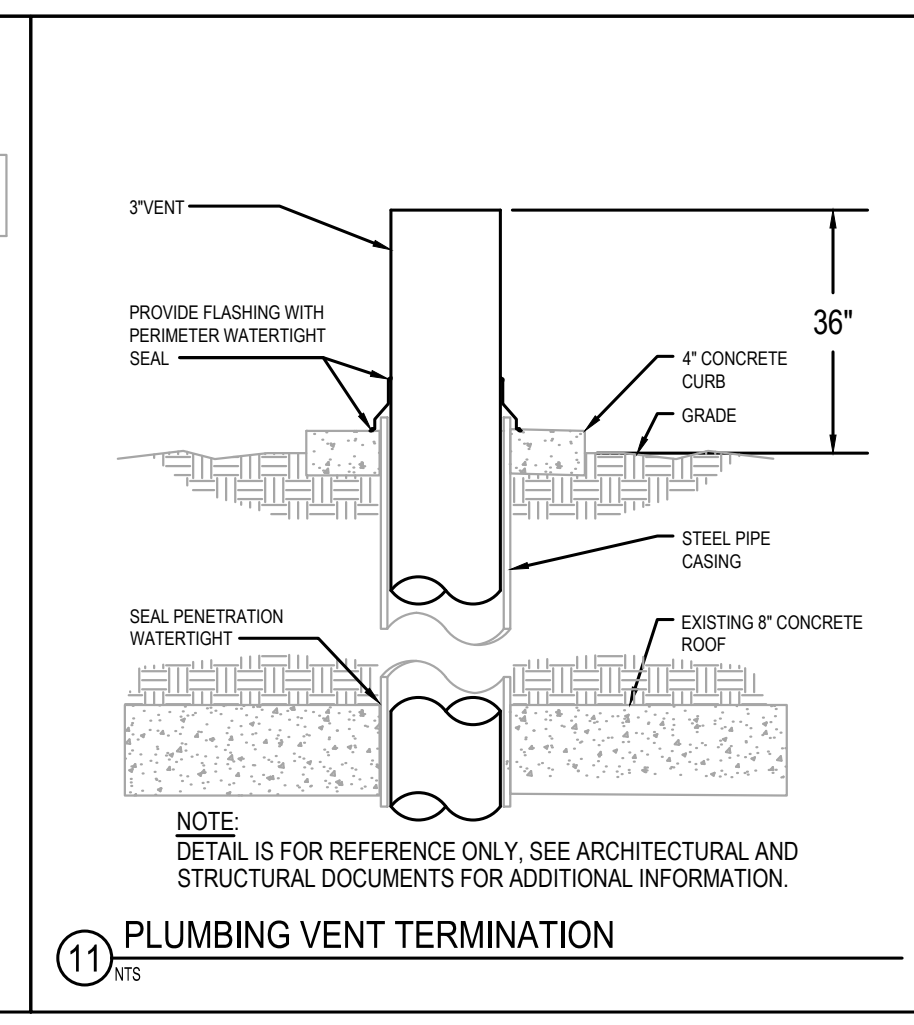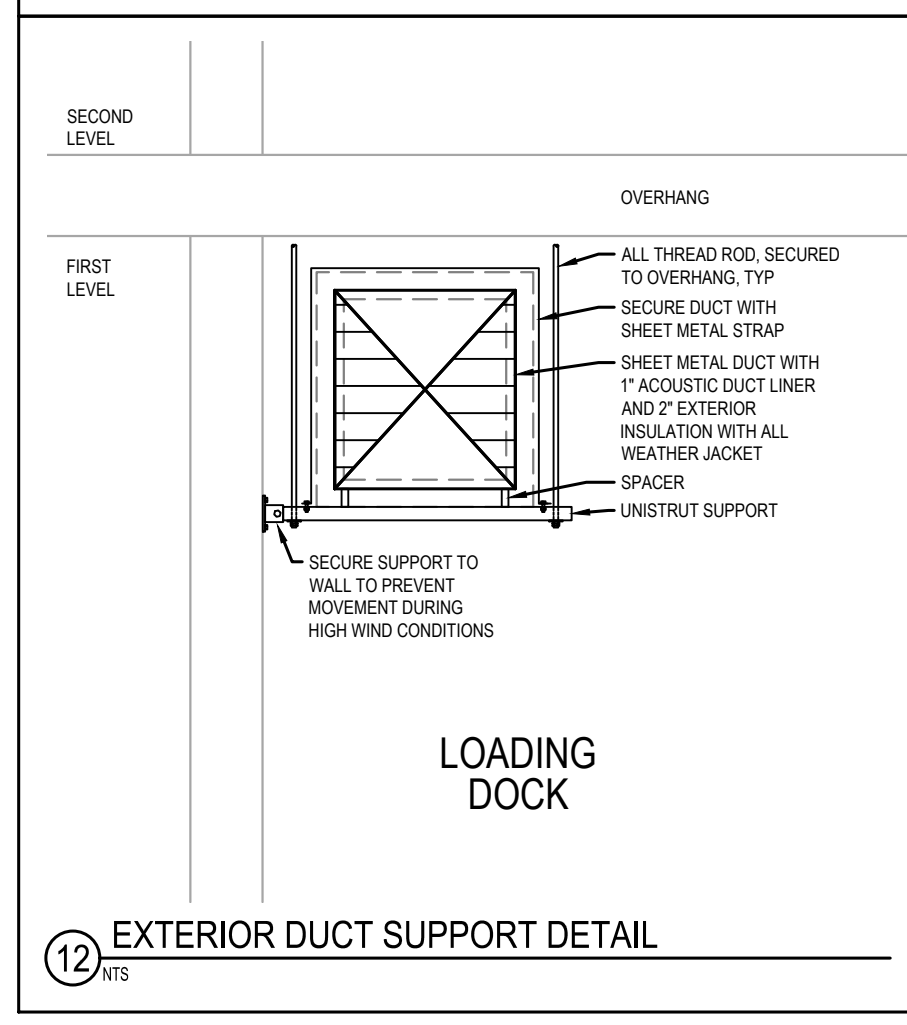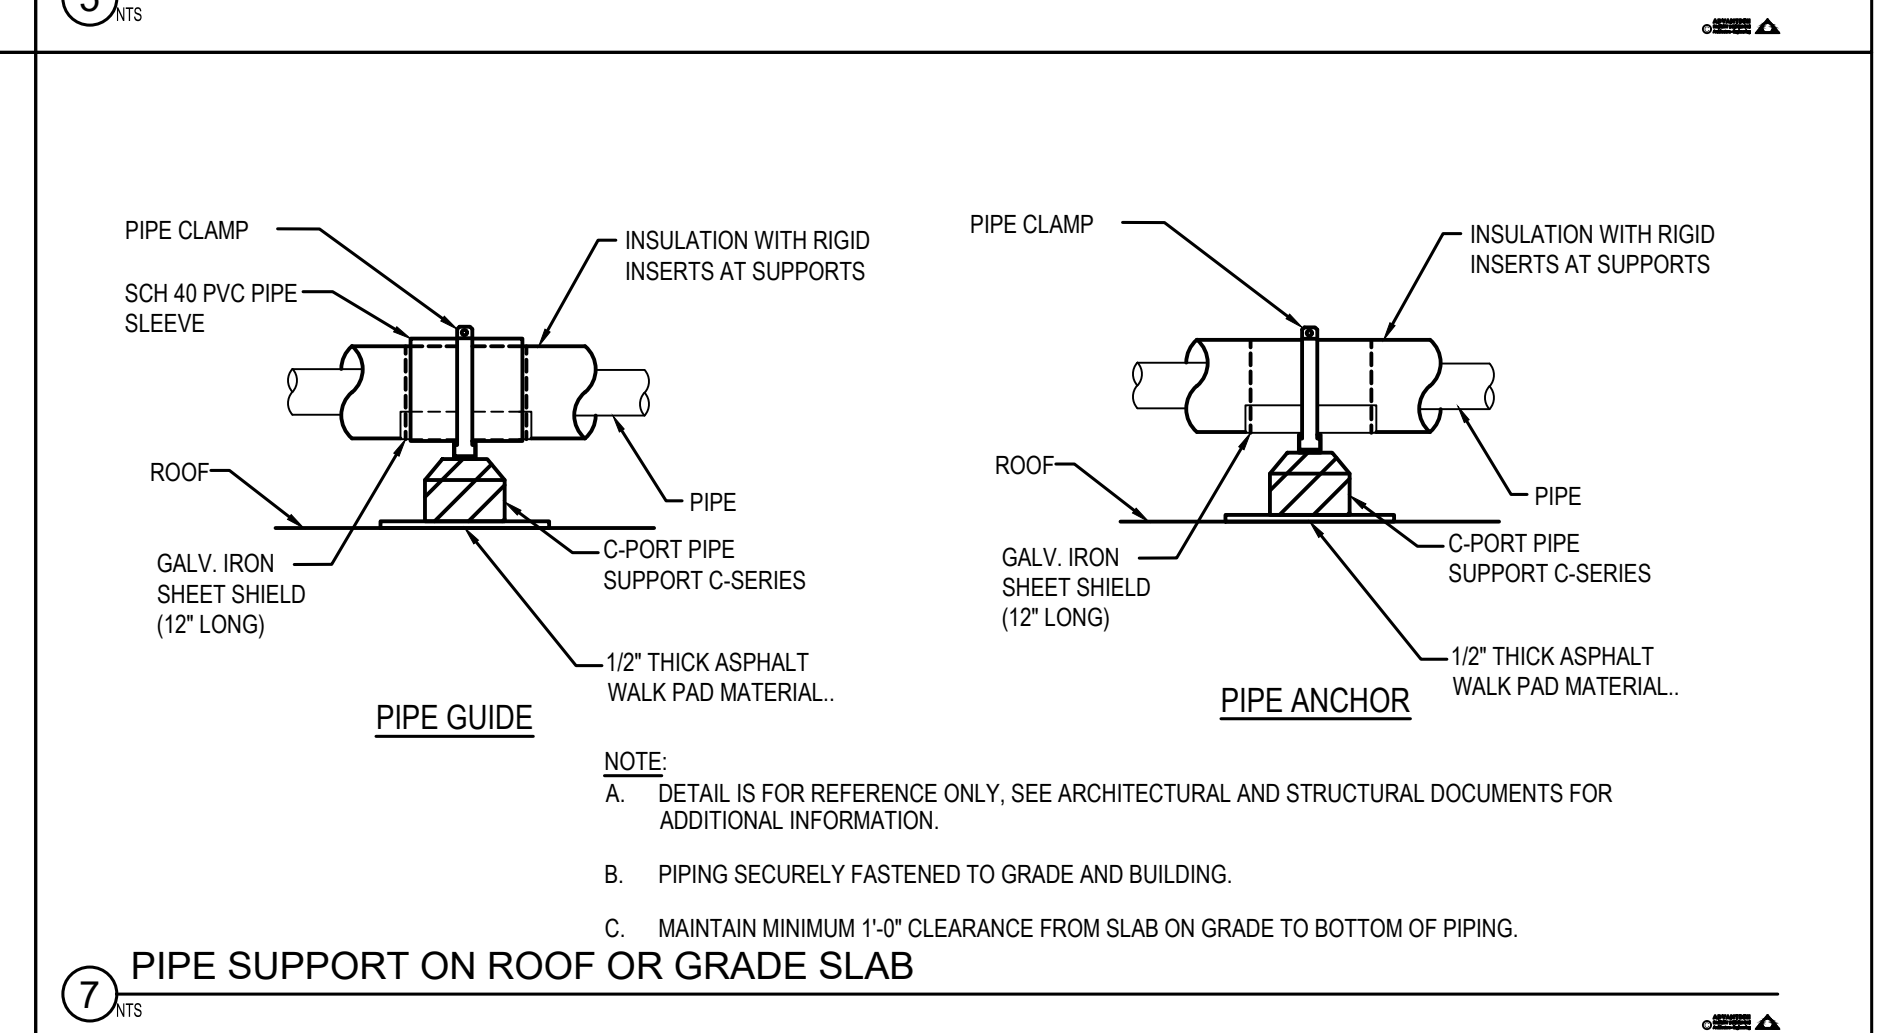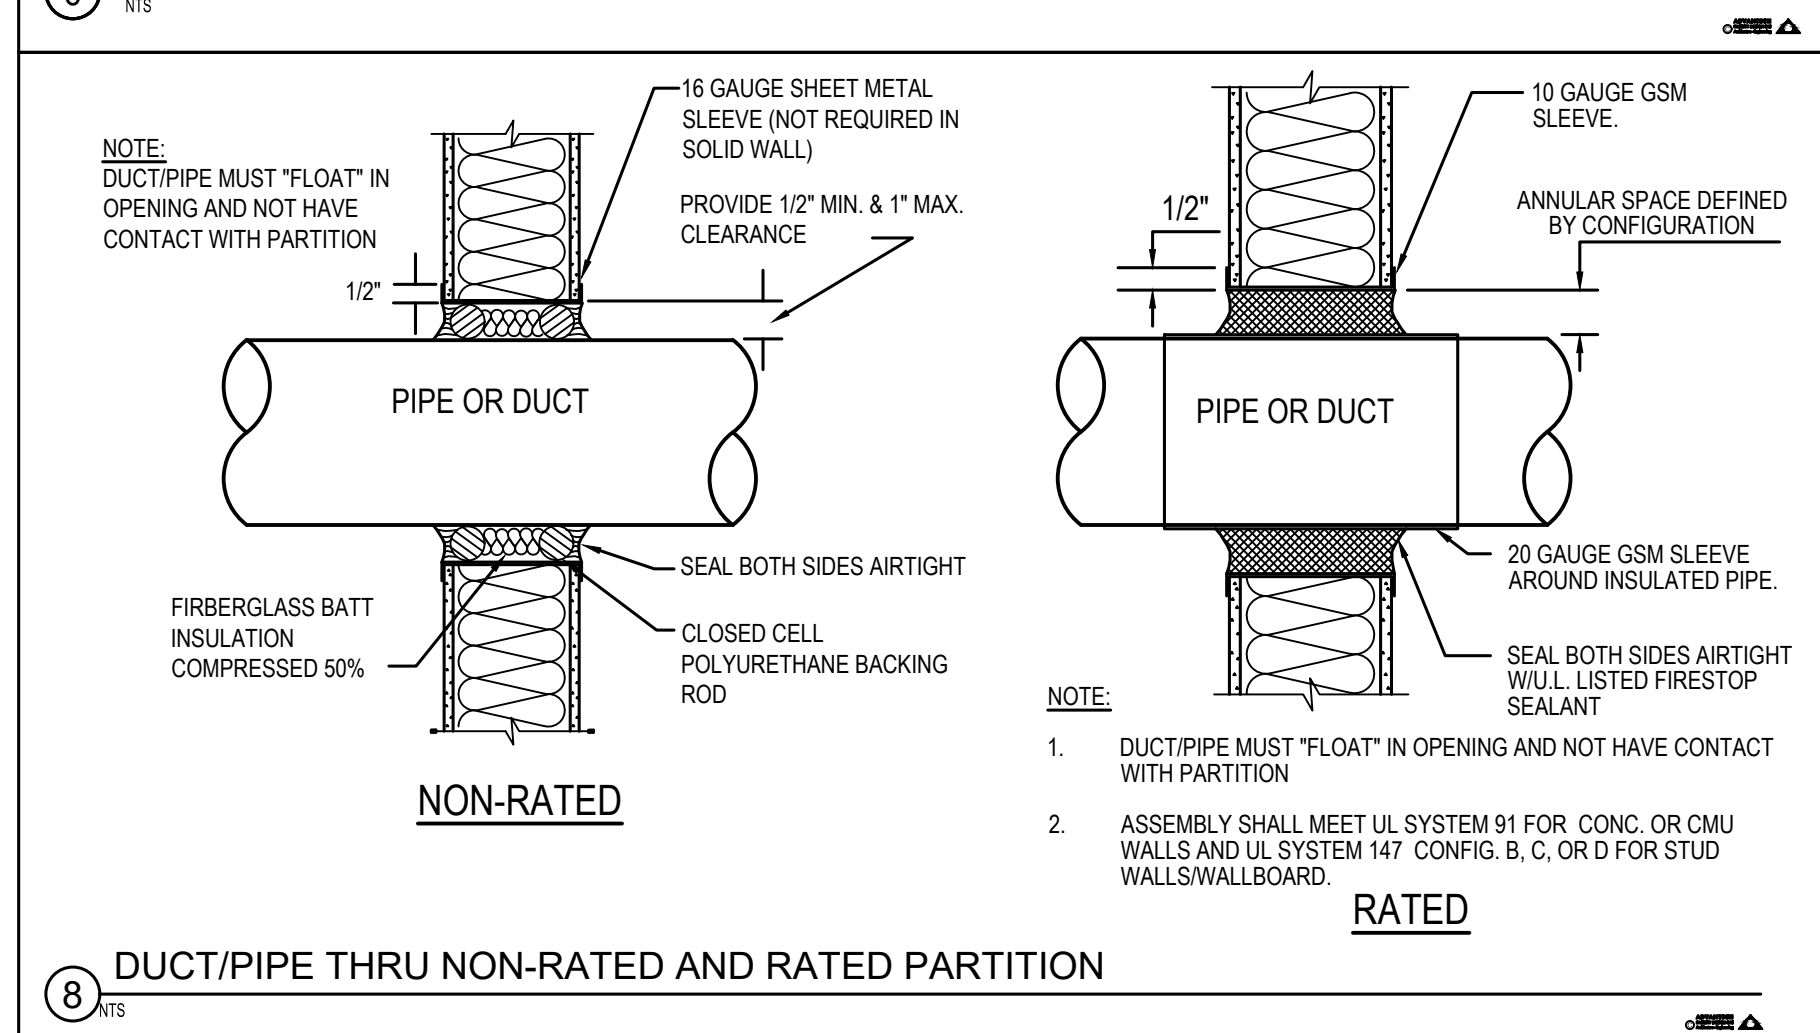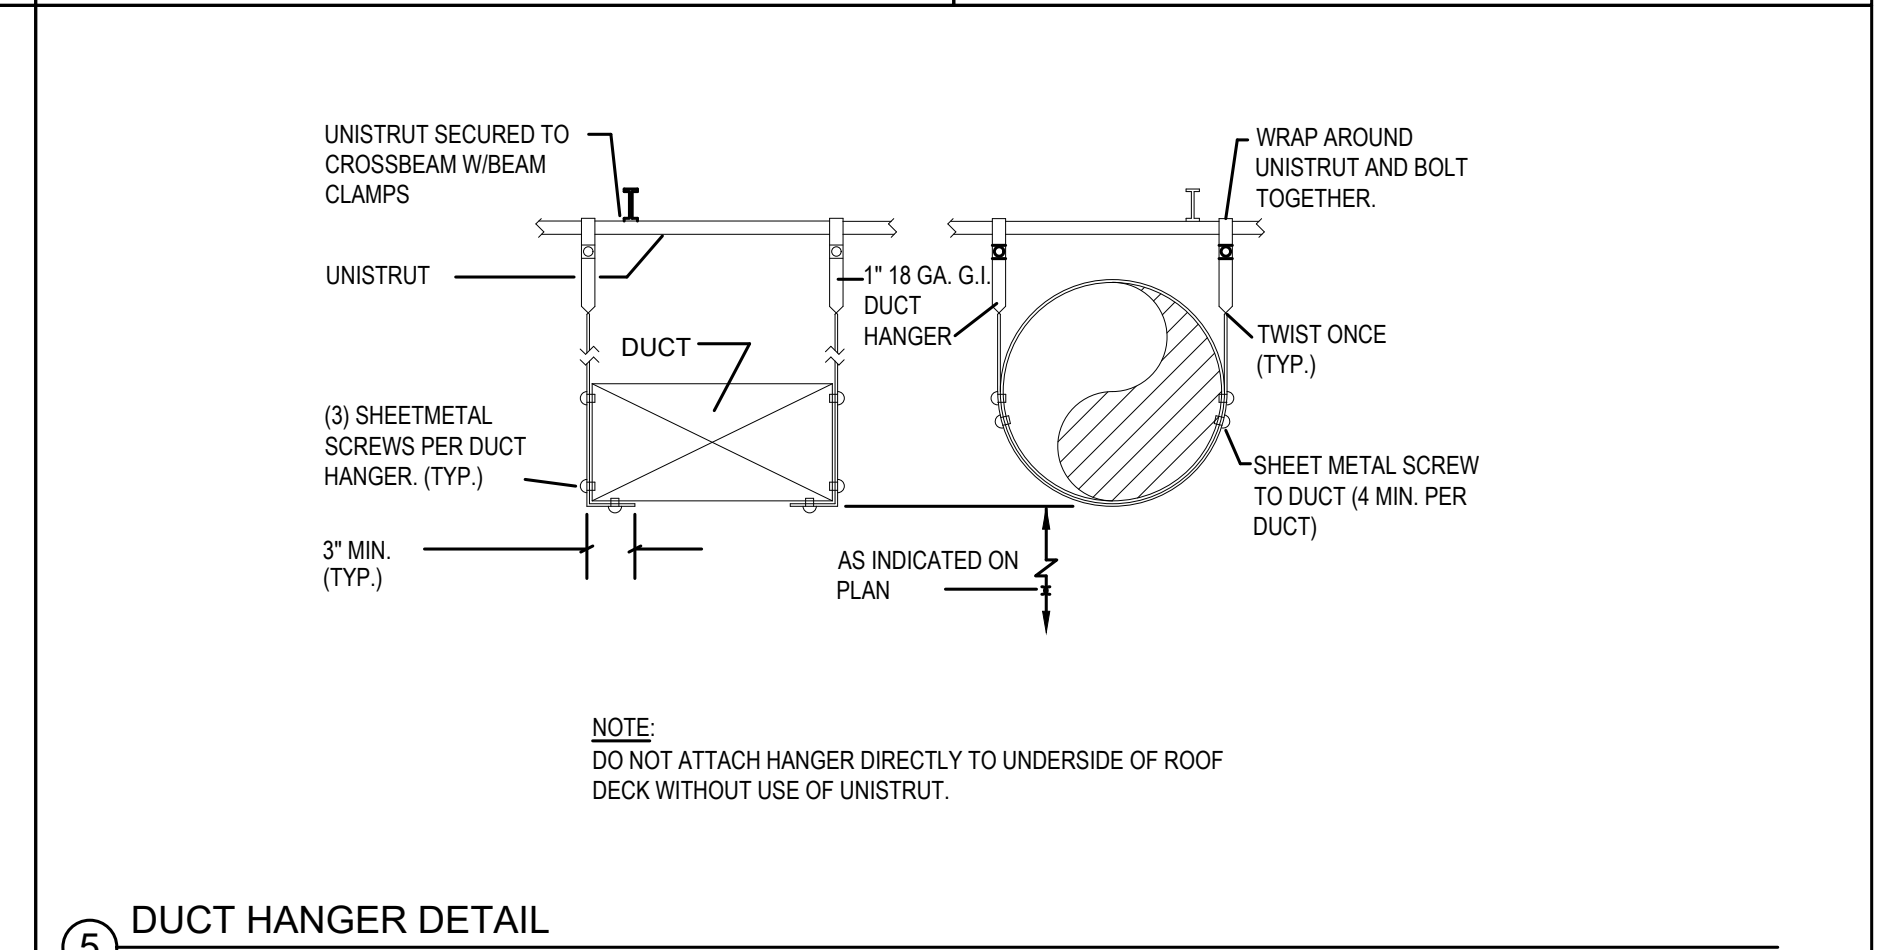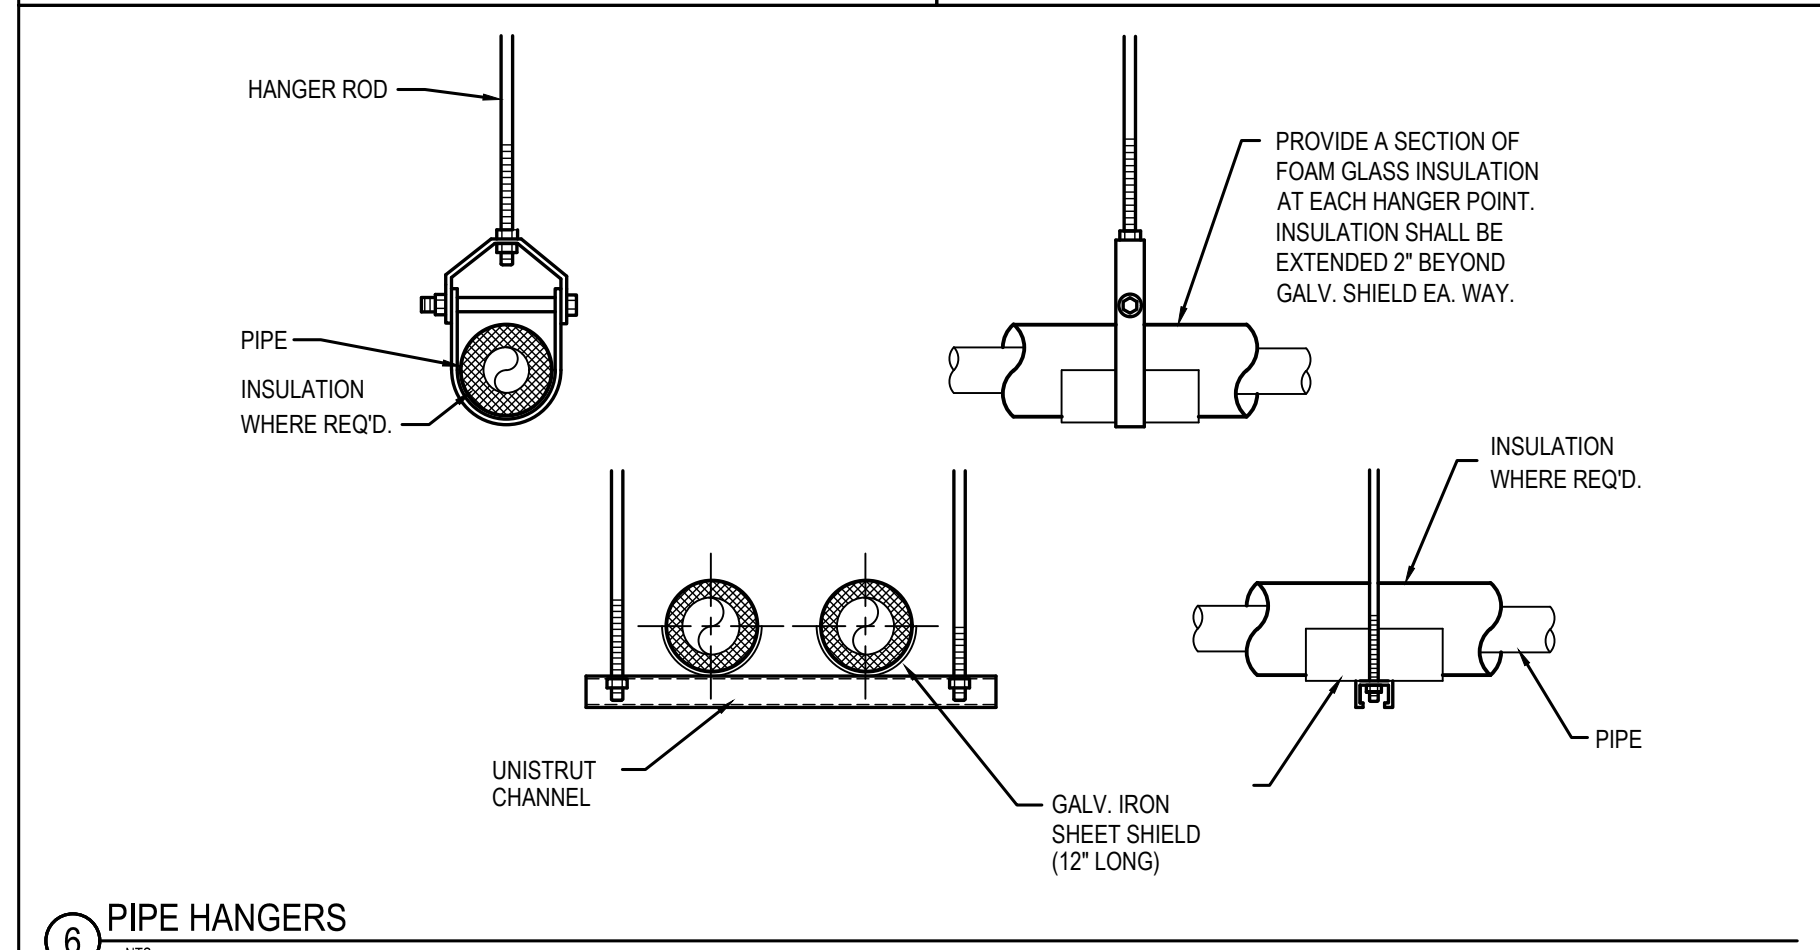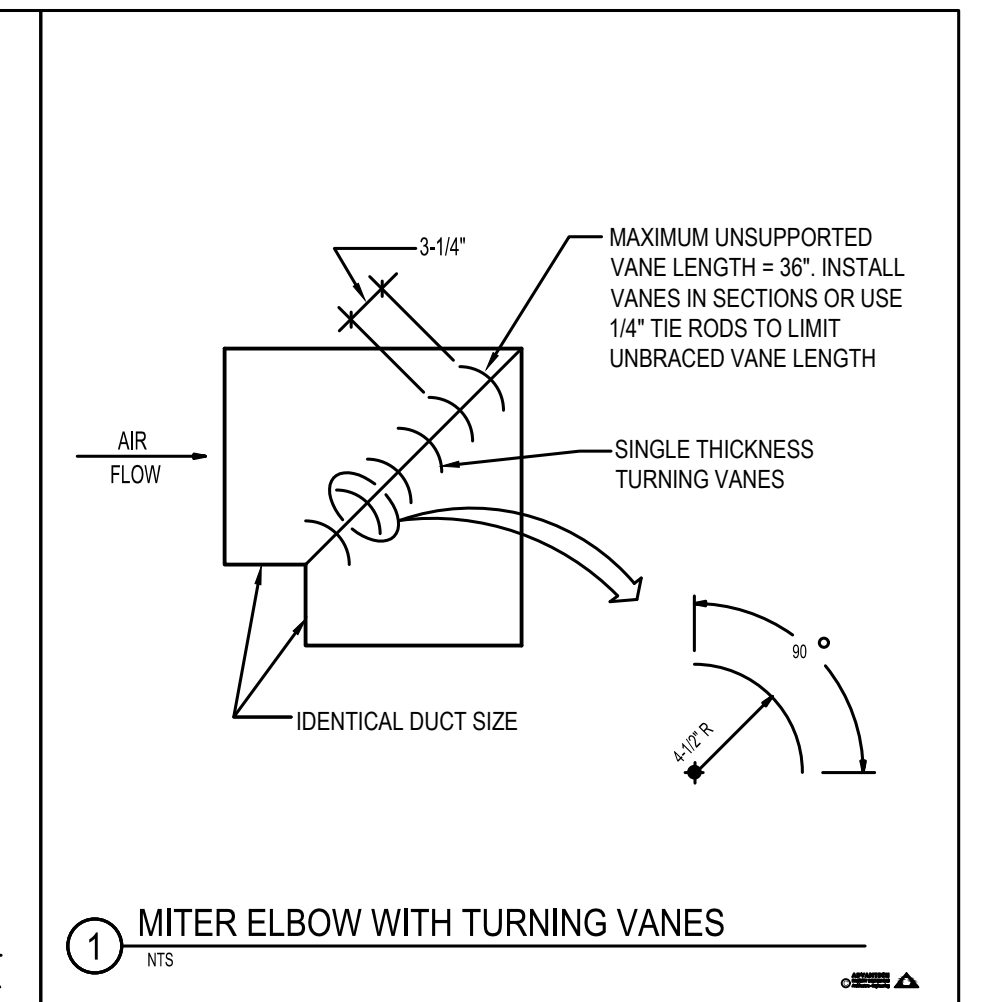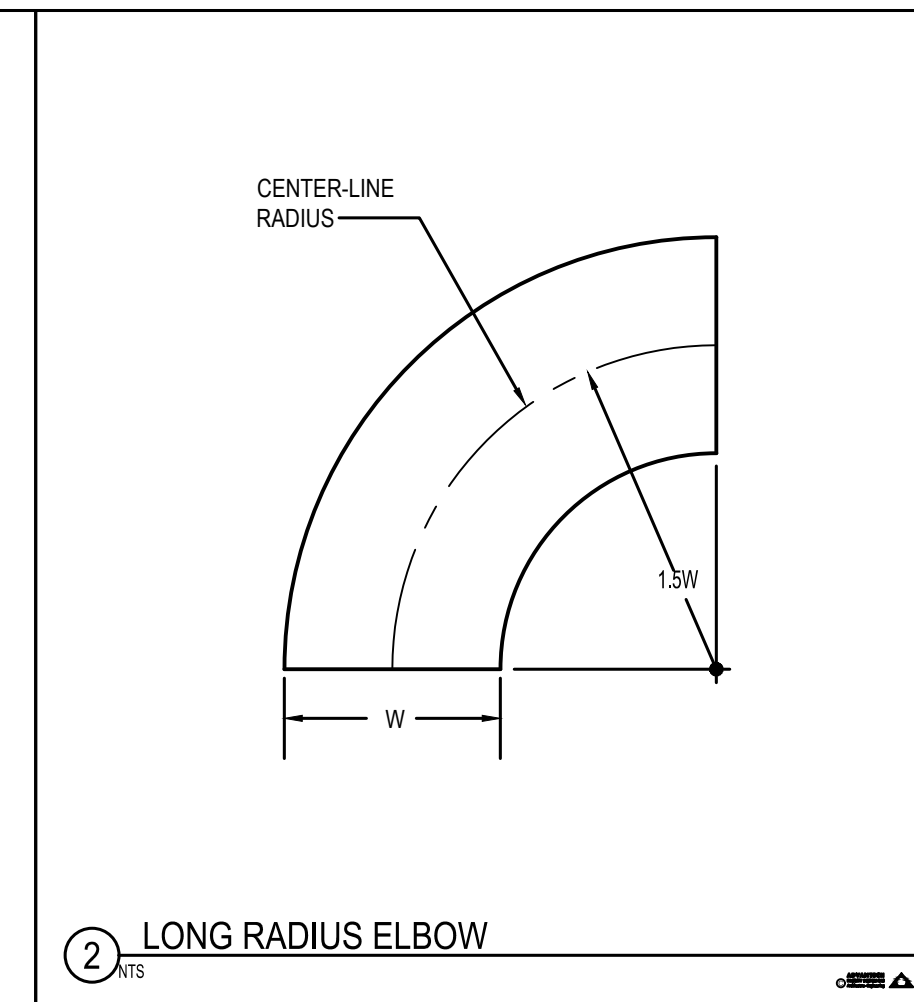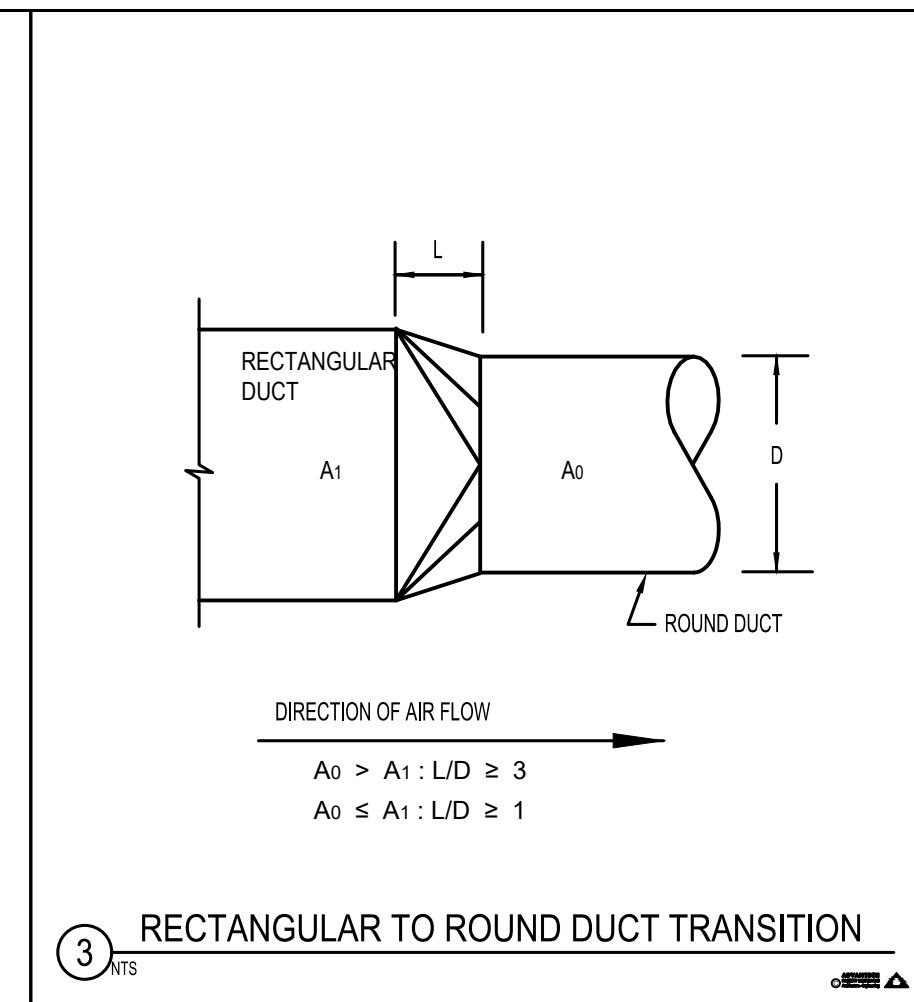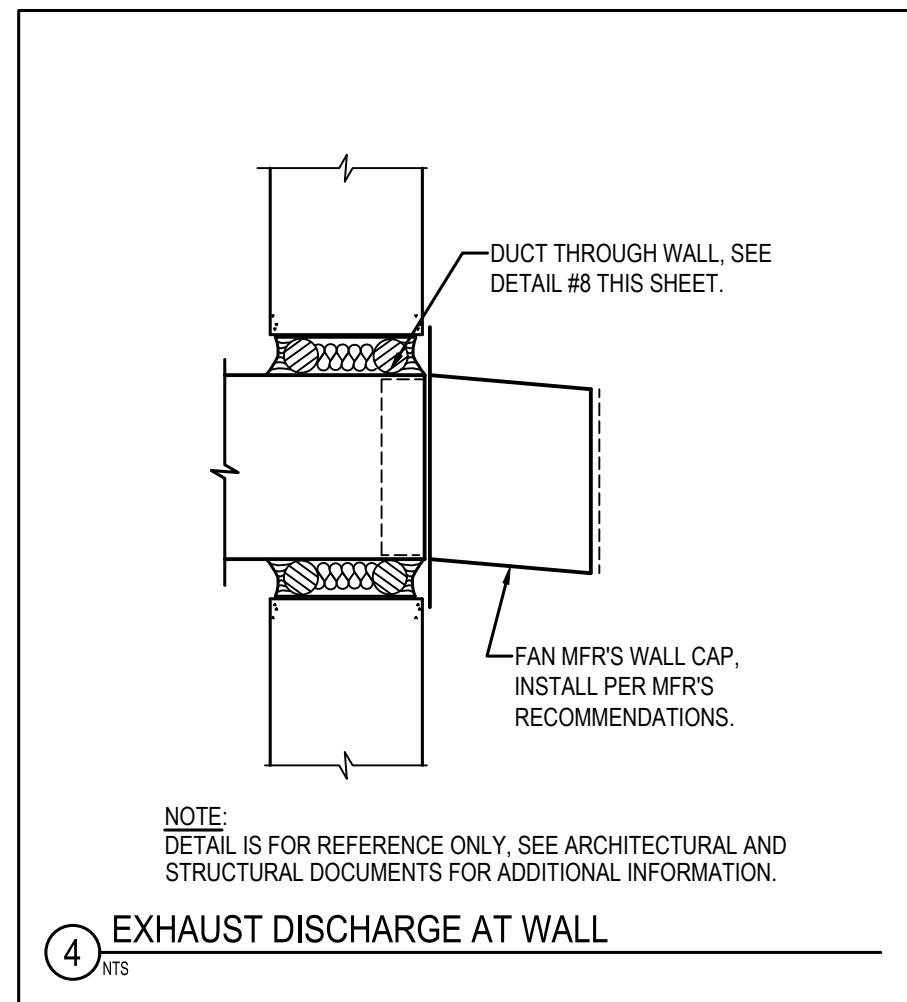KITT PEAK - Sells, AZ 85634




△	DATE	DESCRIPTION
0	01/08/21	I.F.C.

PROJECT NUMBER: 11904.00
DRAWN BY: FI
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CAD FILE: 11904.00-M6.1
SCALE: NONE

MECHANICAL
DETAILS

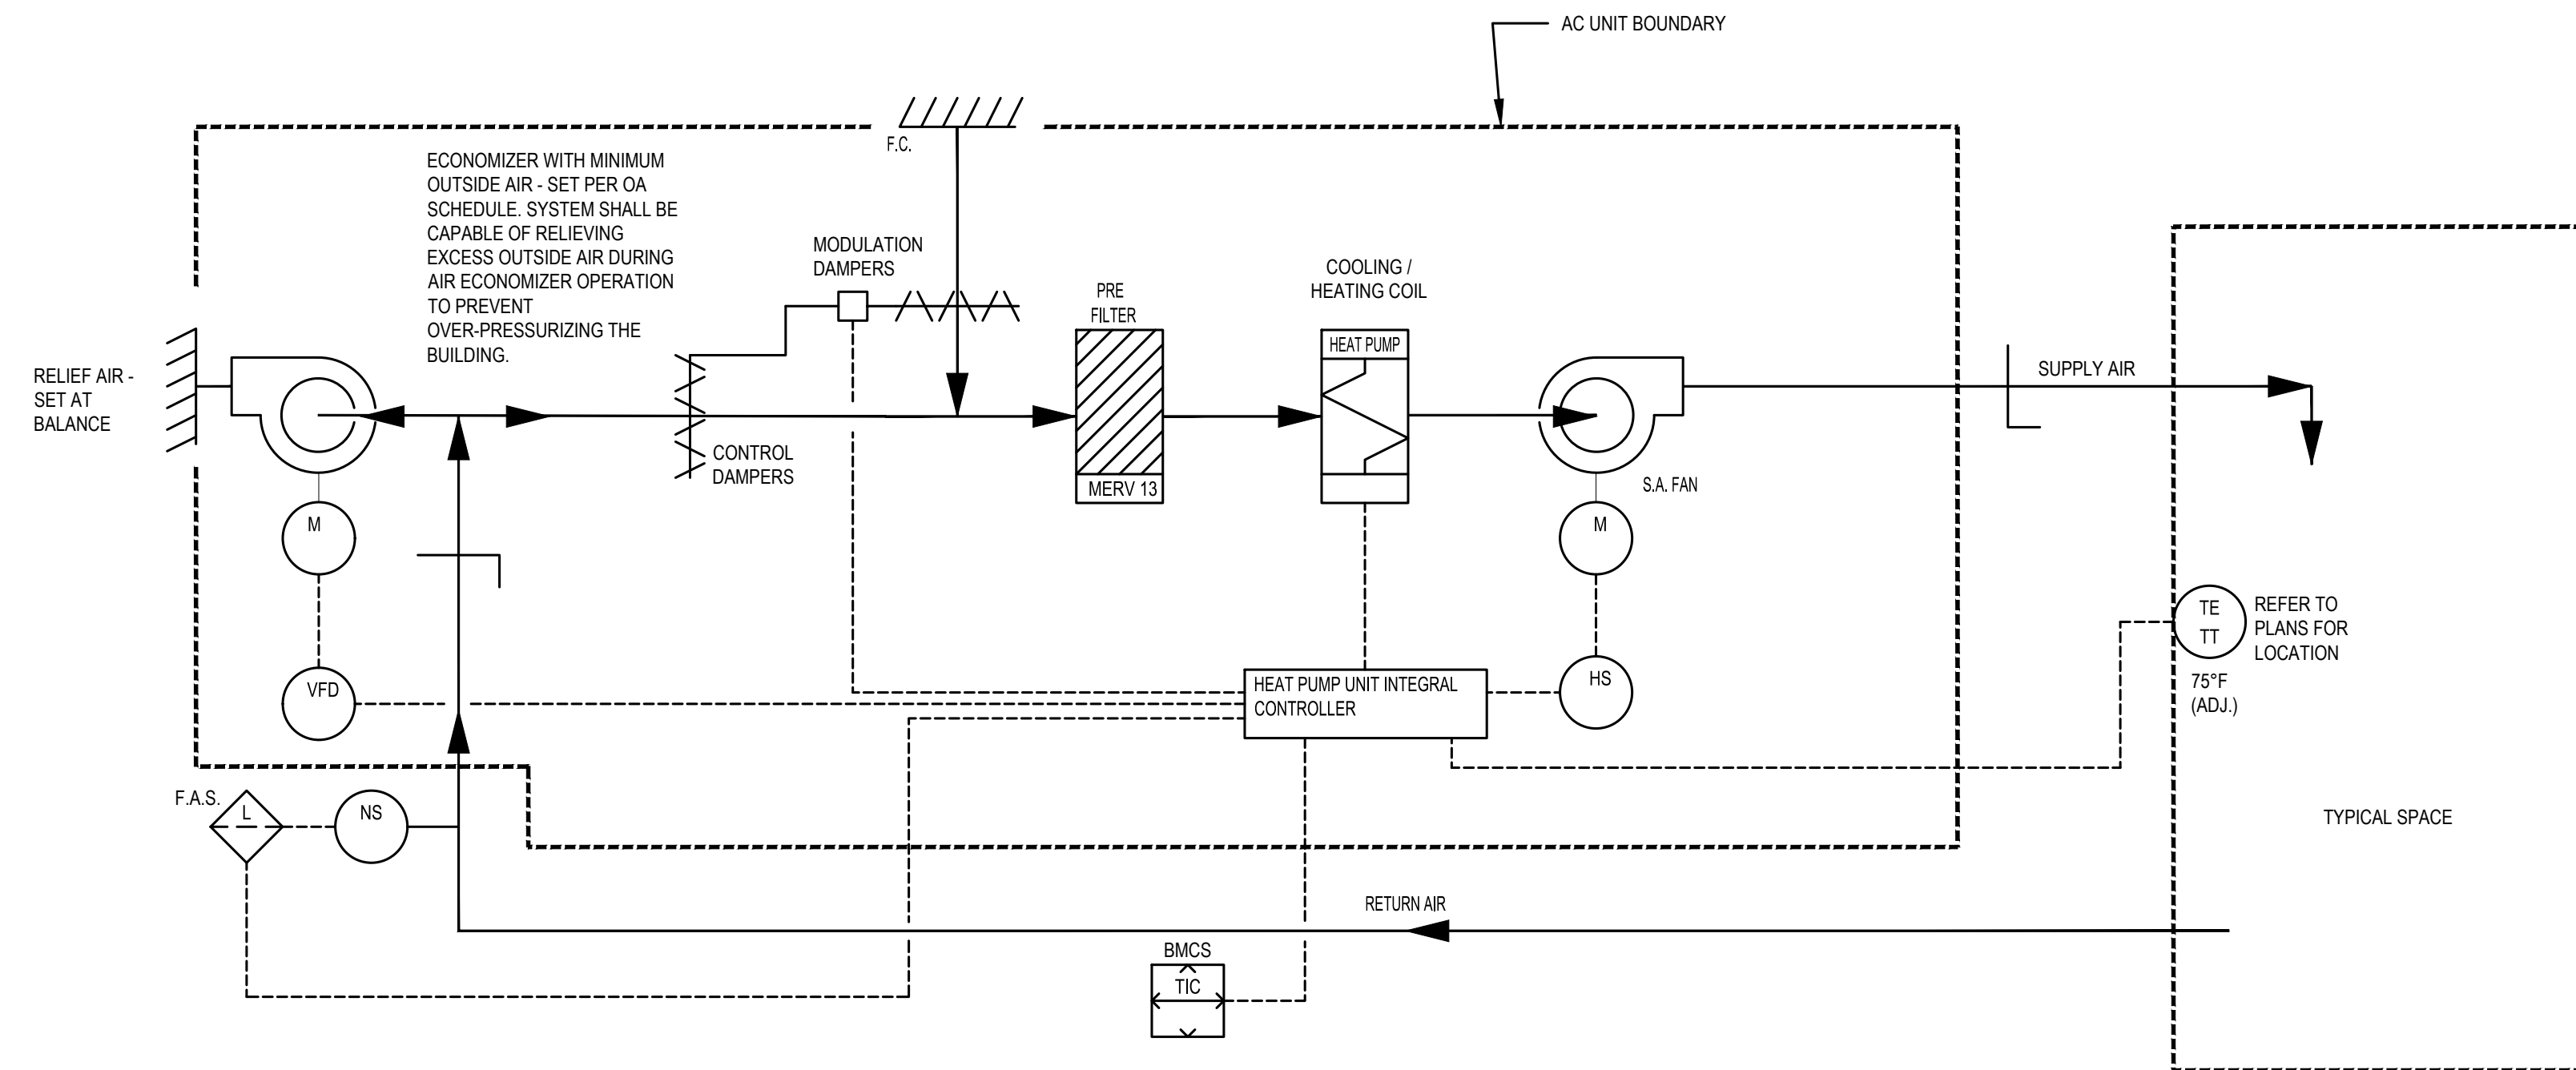
M6.1



SEQUENCE OF OPERATION - HEAT PUMP:

- A. INTERLOCKS: UNIT HAS THE FOLLOWING INTERLOCKS:
(1) FIRE ALARM SYSTEM (REFER TO ELECTRICAL DOCUMENTS FOR FIRE ALARM SYSTEM).
- B. STARTING THE UNIT: WITH ALL CIRCUIT BREAKERS AND DISCONNECTS IN THE OPERATING POSITION, UNIT MAY BE STARTED FROM THE H.O.A. SWITCH. INITIATING THE START SWITCH (HS) ENERGIZES SUPPLY FAN MOTOR AND HEAT PUMP CONDENSING UNIT.
- C. ROOM TEMPERATURE IS MEASURED BY THE TEMPERATURE TRANSMITTER (TE/TT) LOCATED IN THE SPACE AND CONTROLLED BY THE TEMPERATURE CONTROLLER (TIC) BY MODULATING THE HEAT PUMP. SET POINT IS 75°F (ADJUSTABLE) SUMMER, AND 68°F (ADJUSTABLE) WINTER. THERMOSTATIC CONTROLS SHALL PROVIDE A TEMPERATURE RANGE OR DEADBAND OF AT LEAST 5°F WITHIN WHICH THE SUPPLY OF HEATING AND COOLING ENERGY TO THE ZONE IS CAPABLE OF BEING SHUT OFF OR REDUCED TO A MINIMUM, IN ACCORDANCE WITH C403.2.4.2, IECC 2018.
- D. FIRE ALARM SYSTEM ALARM: UPON DETECTION OF SMOKE AN ALARM SIGNAL WILL BE SENT TO THE FIRE ALARM PANEL (FAP), THE FIRE ALARM SYSTEM WILL SHUT DOWN THE ASSOCIATED AIR HANDLING UNIT. THE FIRE ALARM SYSTEM SHALL SEND A COMMON TROUBLE ALARM ON DETECTION OF SMOKE TO THE BMCS.
- E. SHUTDOWN: UNIT MAY BE SHUT DOWN BY HAND SWITCH (HS).
- F. ECONOMIZER CYCLE: INTEGRAL COMPARATIVE ENTHALPY ECONOMIZER OPERATING THROUGH THE PRIMARY TEMPERATURE CONTROLS TO AUTOMATICALLY UTILIZE OUTDOOR AIR FOR FREE COOLING. AUTOMATICALLY MODULATE RELIEF AIR FAN WITH ADJUSTABLE SETPOINTS TO MAINTAIN DISCHARGE AIR TEMPERATURE AT 55 DEG F (ADJ.)
- G. SCHEDULE: OWNER/USER SHALL PROVIDE 7 DAY SCHEDULE OF OPERATIONS. BASED ON OWNER/USER SCHEDULE, UNIT SHALL SHUTDOWN DURING OFF HOURS AND AUTOMATICALLY RESTART WHEN SCHEDULE INDICATES TO RESUME OPERATIONS AS NOTED ABOVE.

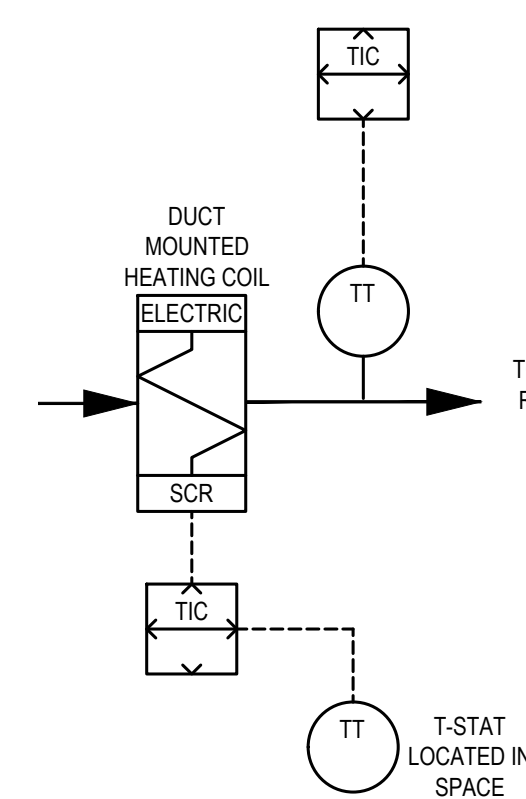
1 HEAT PUMP UNIT DIAGRAM
HP-1 AND HP-2



SEQUENCE OF OPERATION - EXHAUST FAN(S):

- A. INTERLOCKS: UNIT HAS THE FOLLOWING INTERLOCKS:
(1) ASSOCIATED EXISTING HEAT PUMP UNIT HP-2
- B. UNIT START: HEATER SHALL BE ENABLED WHEN ASSOCIATED HEAT PUMP UNIT IS ENABLED. DUCT HEATER SHALL MODULATE TO MAINTAIN SPACE TEMPERATURES OF 70°F (ADJUSTABLE).
- C. DISCHARGE COIL TEMPERATURE SHALL BE MONITORED AT THE BMCS.
- D. EMERGENCY POWER: UNIT IS NOT ON EMERGENCY POWER.

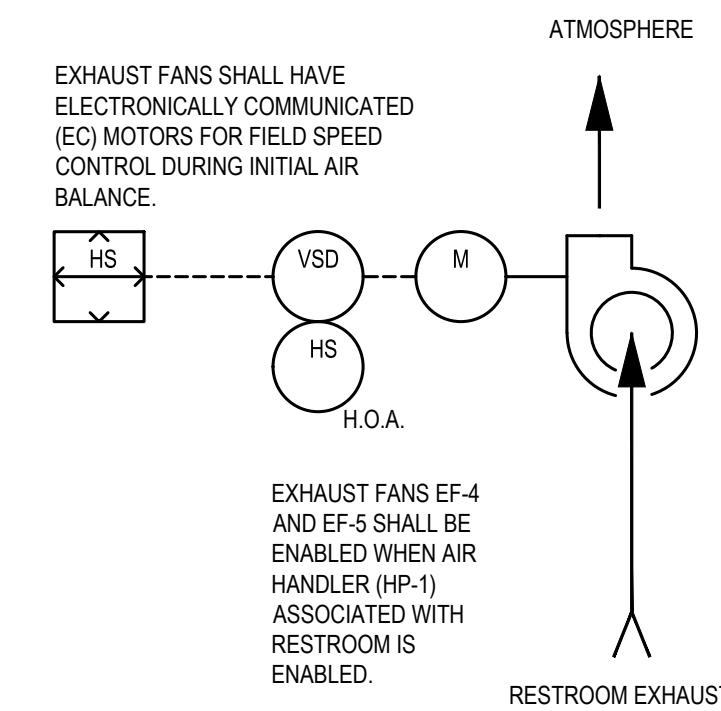3 ELECTRIC COIL DIAGRAM
DUCT MOUNTED




SEQUENCE OF OPERATION - RESTROOM EXHAUST FAN(S):

- A. EXHAUST FANS EF-4 AND EF-5 SHALL BE INTERLOCKED WITH ASSOCIATED AIR HANDLER SERVING RESTROOM(S) HP-1. EXHAUST FANS SHALL RUN WHENEVER ASSOCIATED AIR HANDLER IS ENABLED.
- B. EXHAUST FANS EF-1, EF-2, AND EF-3 SHALL BE ENABLED FROM WALL SWITCH LOCATED IN THE ADJACENT UTILITY ROOM AND SHALL RUN CONTINUOUSLY WHEN BUILDING IS OCCUPIED.
- C. ALL EXHAUST FANS SHALL BE CONNECTED TO THE EMCS VIA BACNET.
- D. EC MOTORS SHALL BE USED FOR INITIAL AIR BALANCE.

3 EXHAUST FAN DIAGRAM

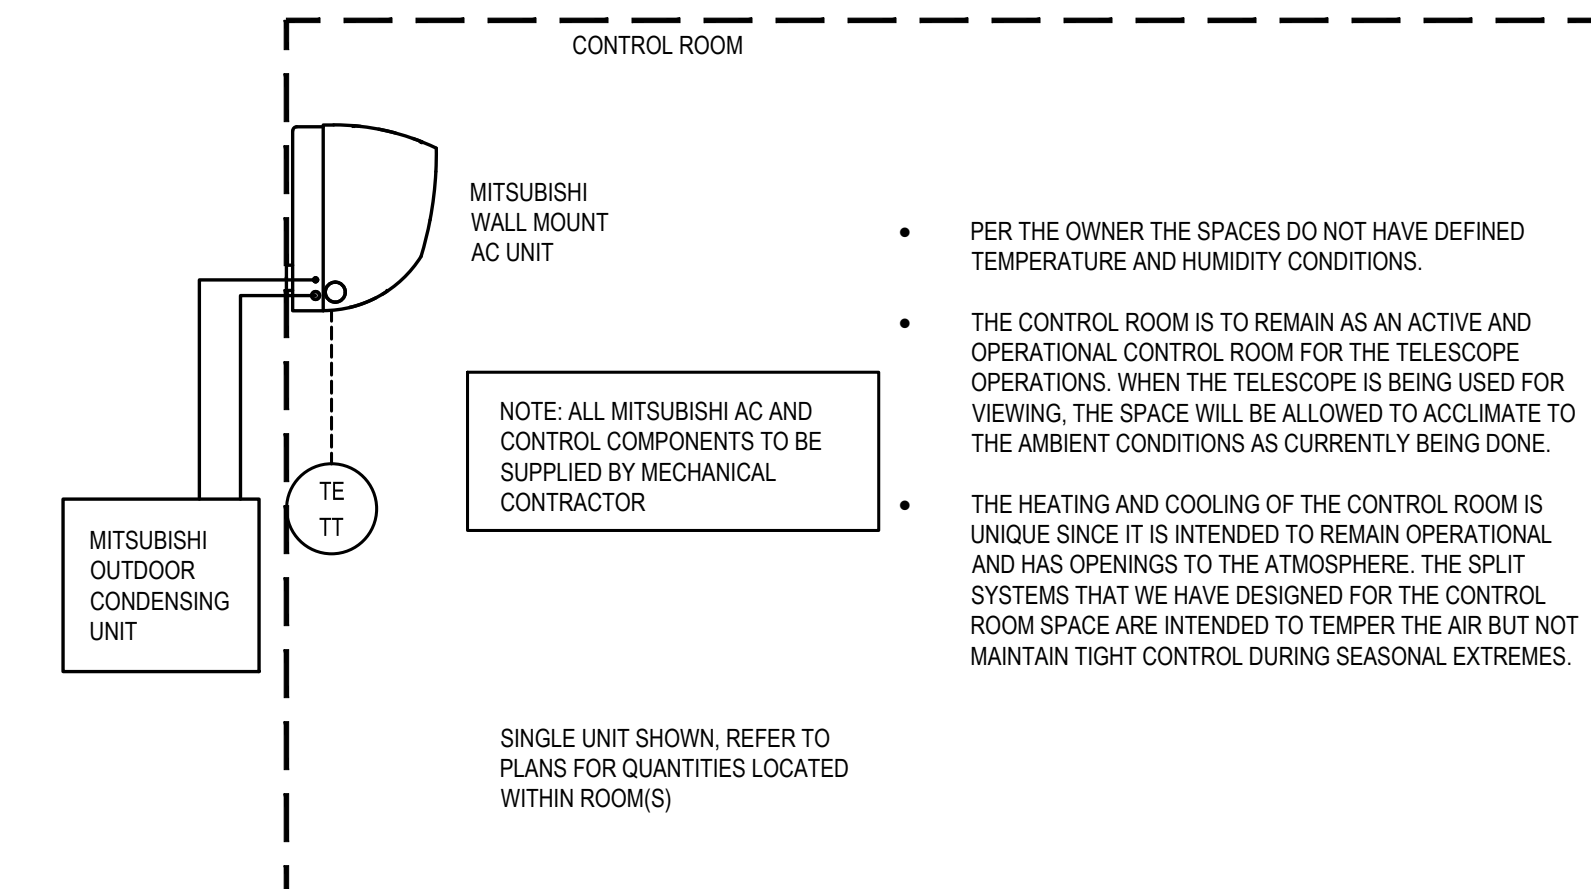2 DUCTLESS SPLIT UNIT P&ID
COOLING AND HEATING HEAT PUMP UNIT





SEQUENCE OF OPERATION - HEATING & COOLING:

- A. INTERLOCKS: UNIT HAS THE FOLLOWING INTERLOCKS:
NONE
- B. STARTING THE UNIT: WITH ALL CIRCUIT BREAKERS AND DISCONNECTS IN THE OPERATING POSITION, UNIT MAY BE STARTED FROM THE H.O.A. SWITCH. INITIATING THE START SWITCH (HS) ENERGIZES AC UNIT AND CONDENSING UNIT.
- C. SUPPLY AIR DRY BULB TEMPERATURE: SUPPLY AIR IS MEASURED BY THE TEMPERATURE TRANSMITTER (TE/TT) LOCATED IN THE SPACE TO CONTROL THE HP UNIT.
- D. SHUTDOWN: UNIT MAY BE SHUT DOWN BY HAND SWITCH (HS).



2 DUCTLESS SPLIT UNIT P&ID
COOLING AND HEATING HEAT PUMP UNIT

GENERAL NOTES:

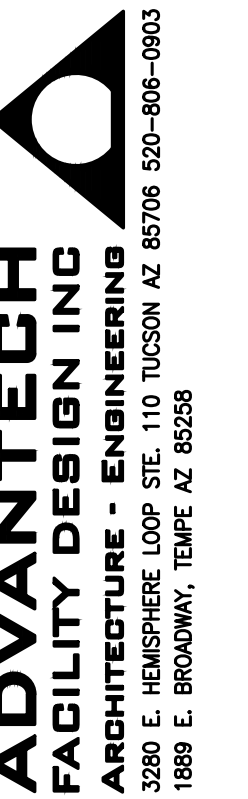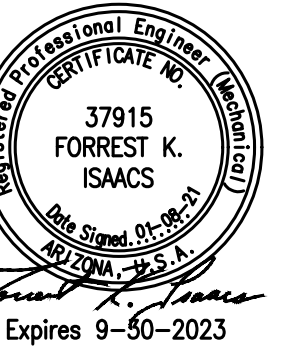- A. ALL EQUIPMENT SHALL BE PROVIDED WITH BACNET CARDS AND SHALL BE CONNECTED TO THE SITE BMCS.
- B. SITE BMCS SHALL BE CAPABLE OF MONITORING OF SYSTEM AND RESETTING OF TEMPERATURES BY CONTROLS CONTRACTOR.
- C. CONTRACTOR SHALL CONNECT TO THE EXISTING ALERTON CONTROL PANEL WITH BACNET MST/PIP AND INTEGRATE ALL NEW CONTROLS INTO THIS.
- D. PROVIDE BID ALTERNATE FOR PROVIDING A NEW ALERTON CONTROL PANEL AND INTEGRATION INTO THE SITE BMCS.



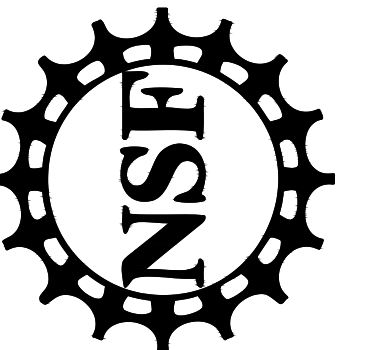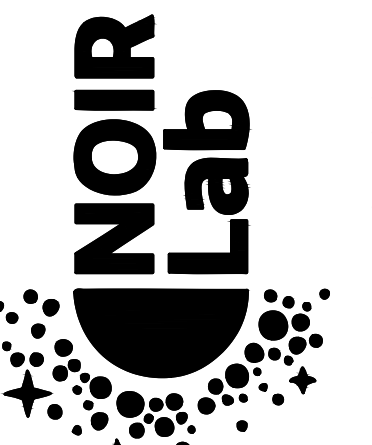WINDOWS ON THE UNIVERSE CENTER FOR ASTRONOMY OUTREACH





KITT PEAK - Sells, AZ 85634

DATE	DESCRIPTION
0 01/08/21	I.F.C.

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CHECKED BY:	FI
CAD FILE:	11904.00-M7.1
SCALE:	NONE



MECHANICAL P&ID'S

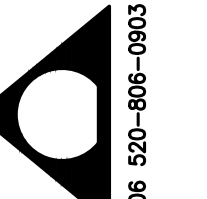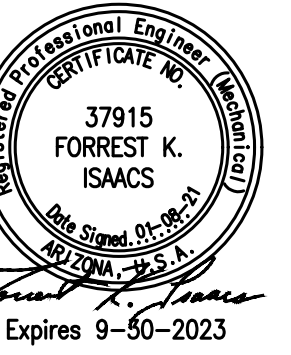M7.1



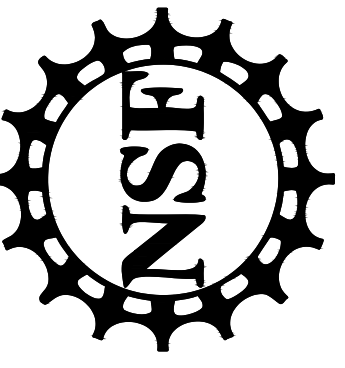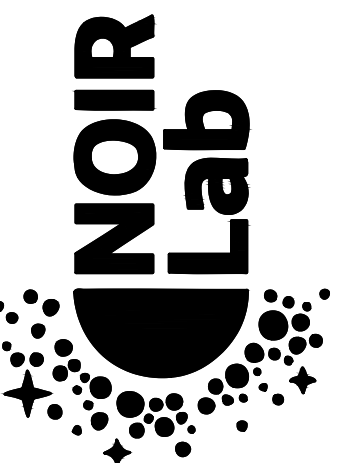ADVANTECH
 FACILITY DESIGN INC
 ARCHITECTURE - ENGINEERING
 3280 E. HEMISPHERE LOOP STE. 110 TUCSON AZ 85706 520-806-0903
 1889 E. BROADWAY, TEMPE, AZ 85288

WINDOWS ON
 THE UNIVERSE
 CENTER FOR
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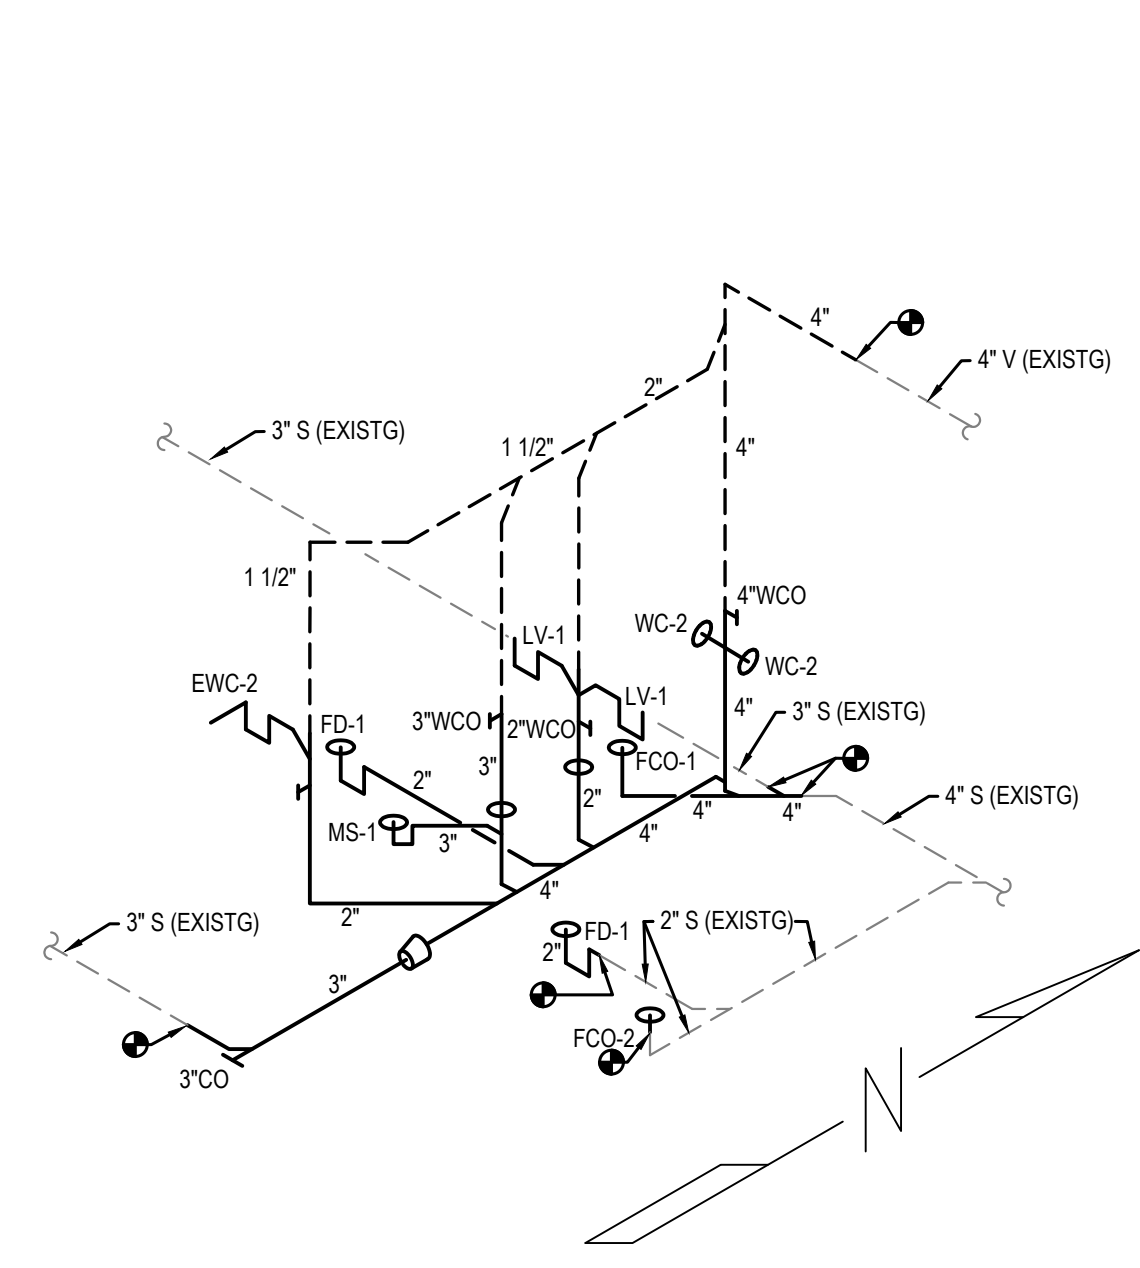
KITT PEAK - Sells, AZ 85634

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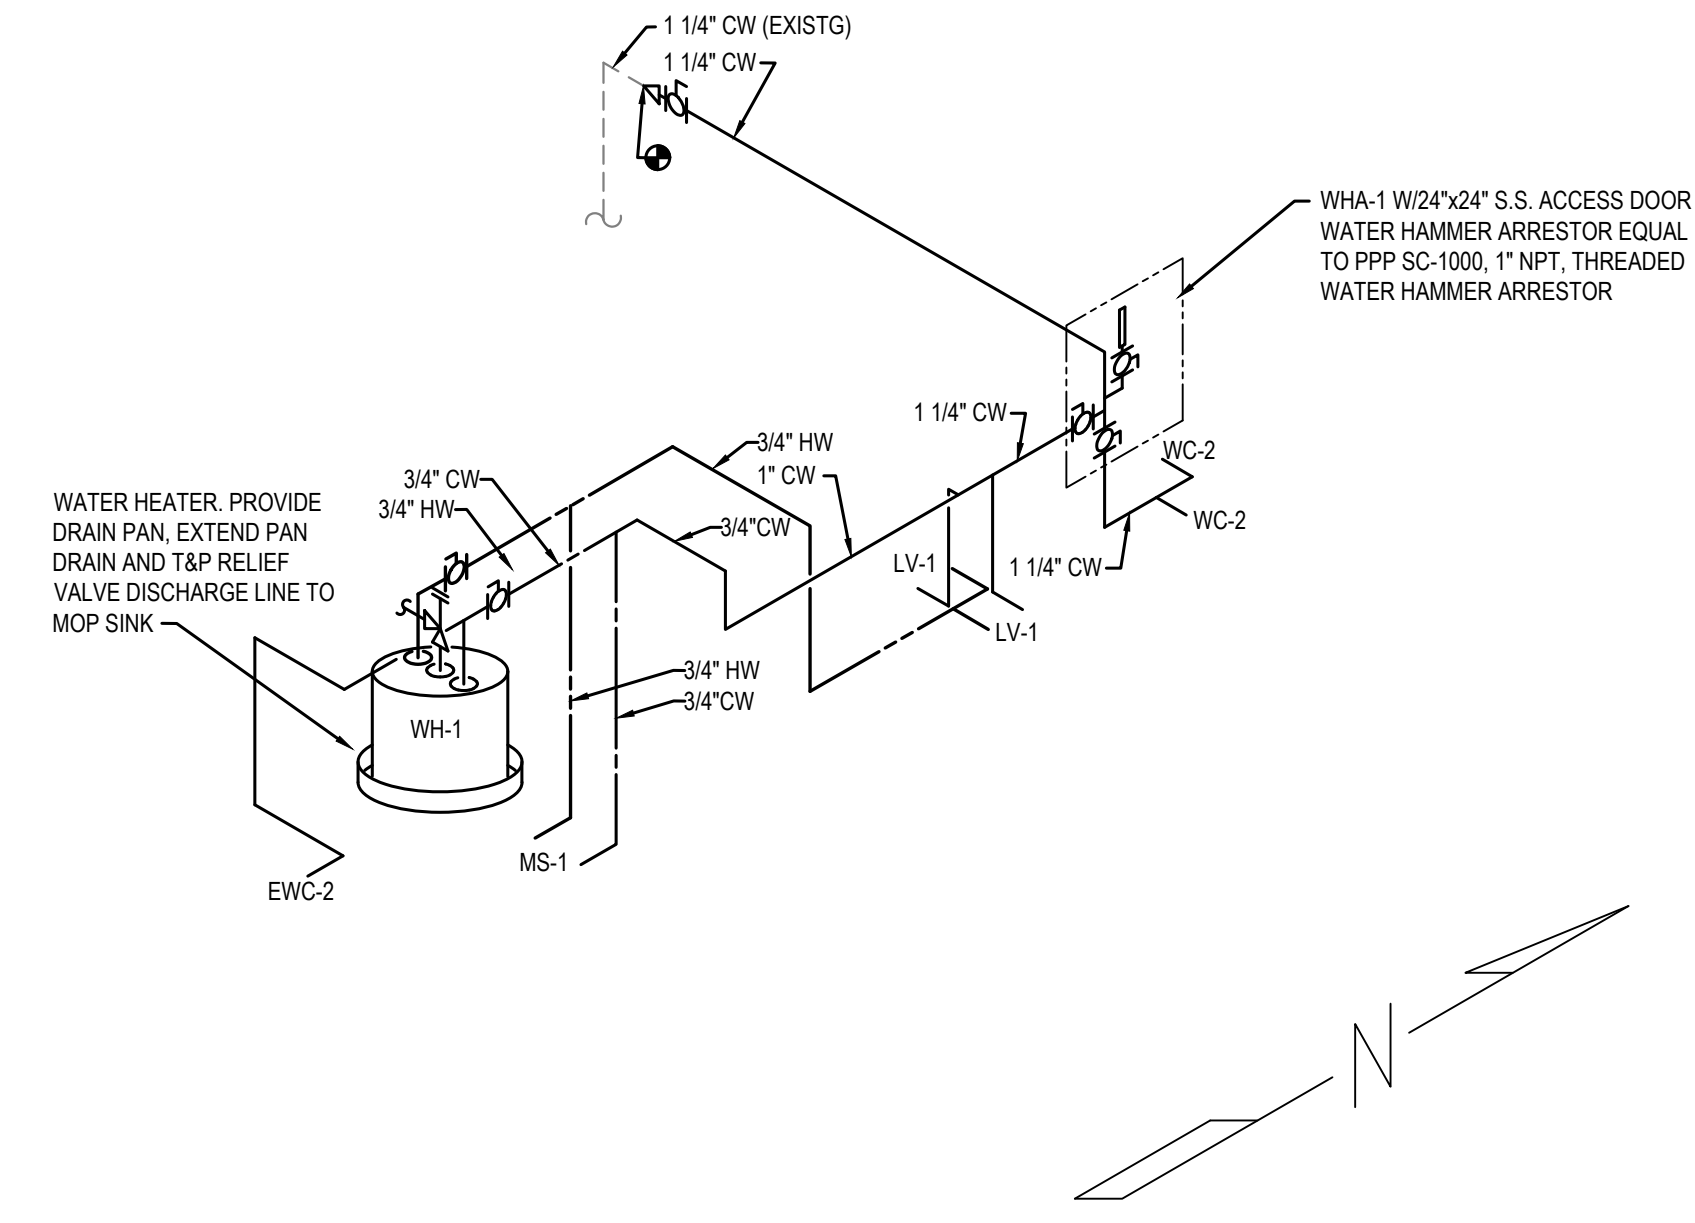
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 CHECKED BY: FI
 CAD FILE: 11904.00-M8.1
 SCALE: NONE

MECHANICAL
 RISER
 DIAGRAMS

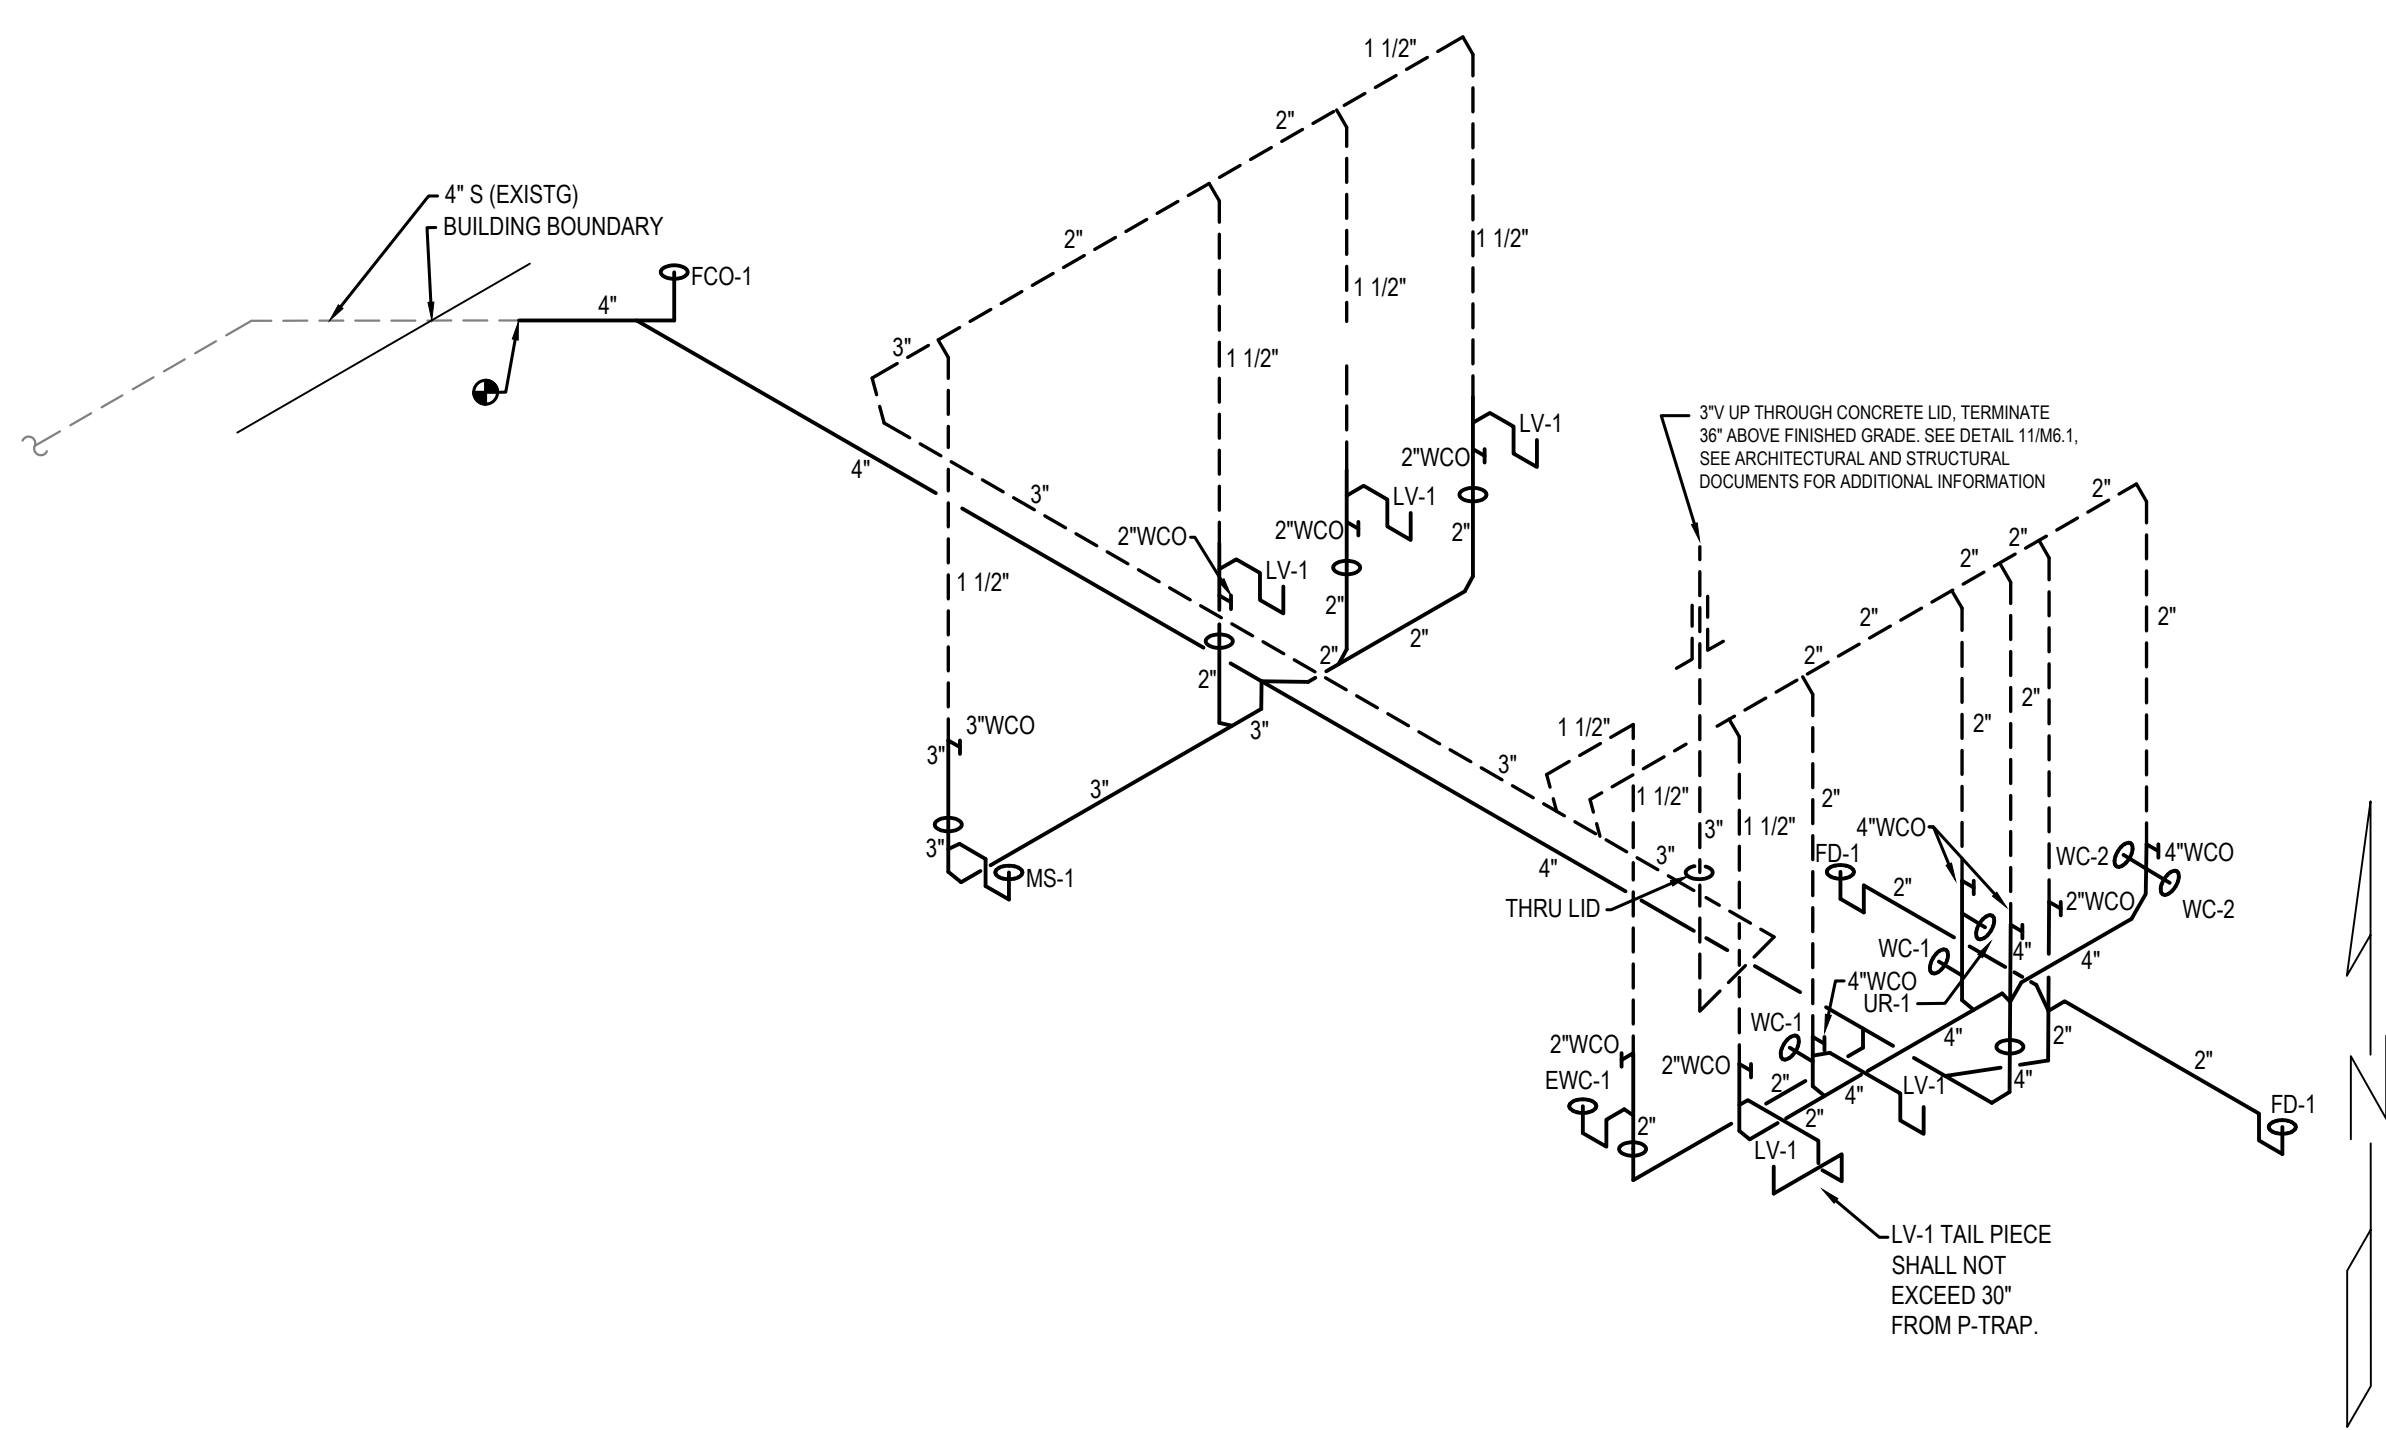
M8.1




1 PLUMBING RISER - DRAIN AND VENT
 EAST RESTROOM SCALE: NONE



2 PLUMBING RISER - WATER
 EAST RESTROOM SCALE: NONE



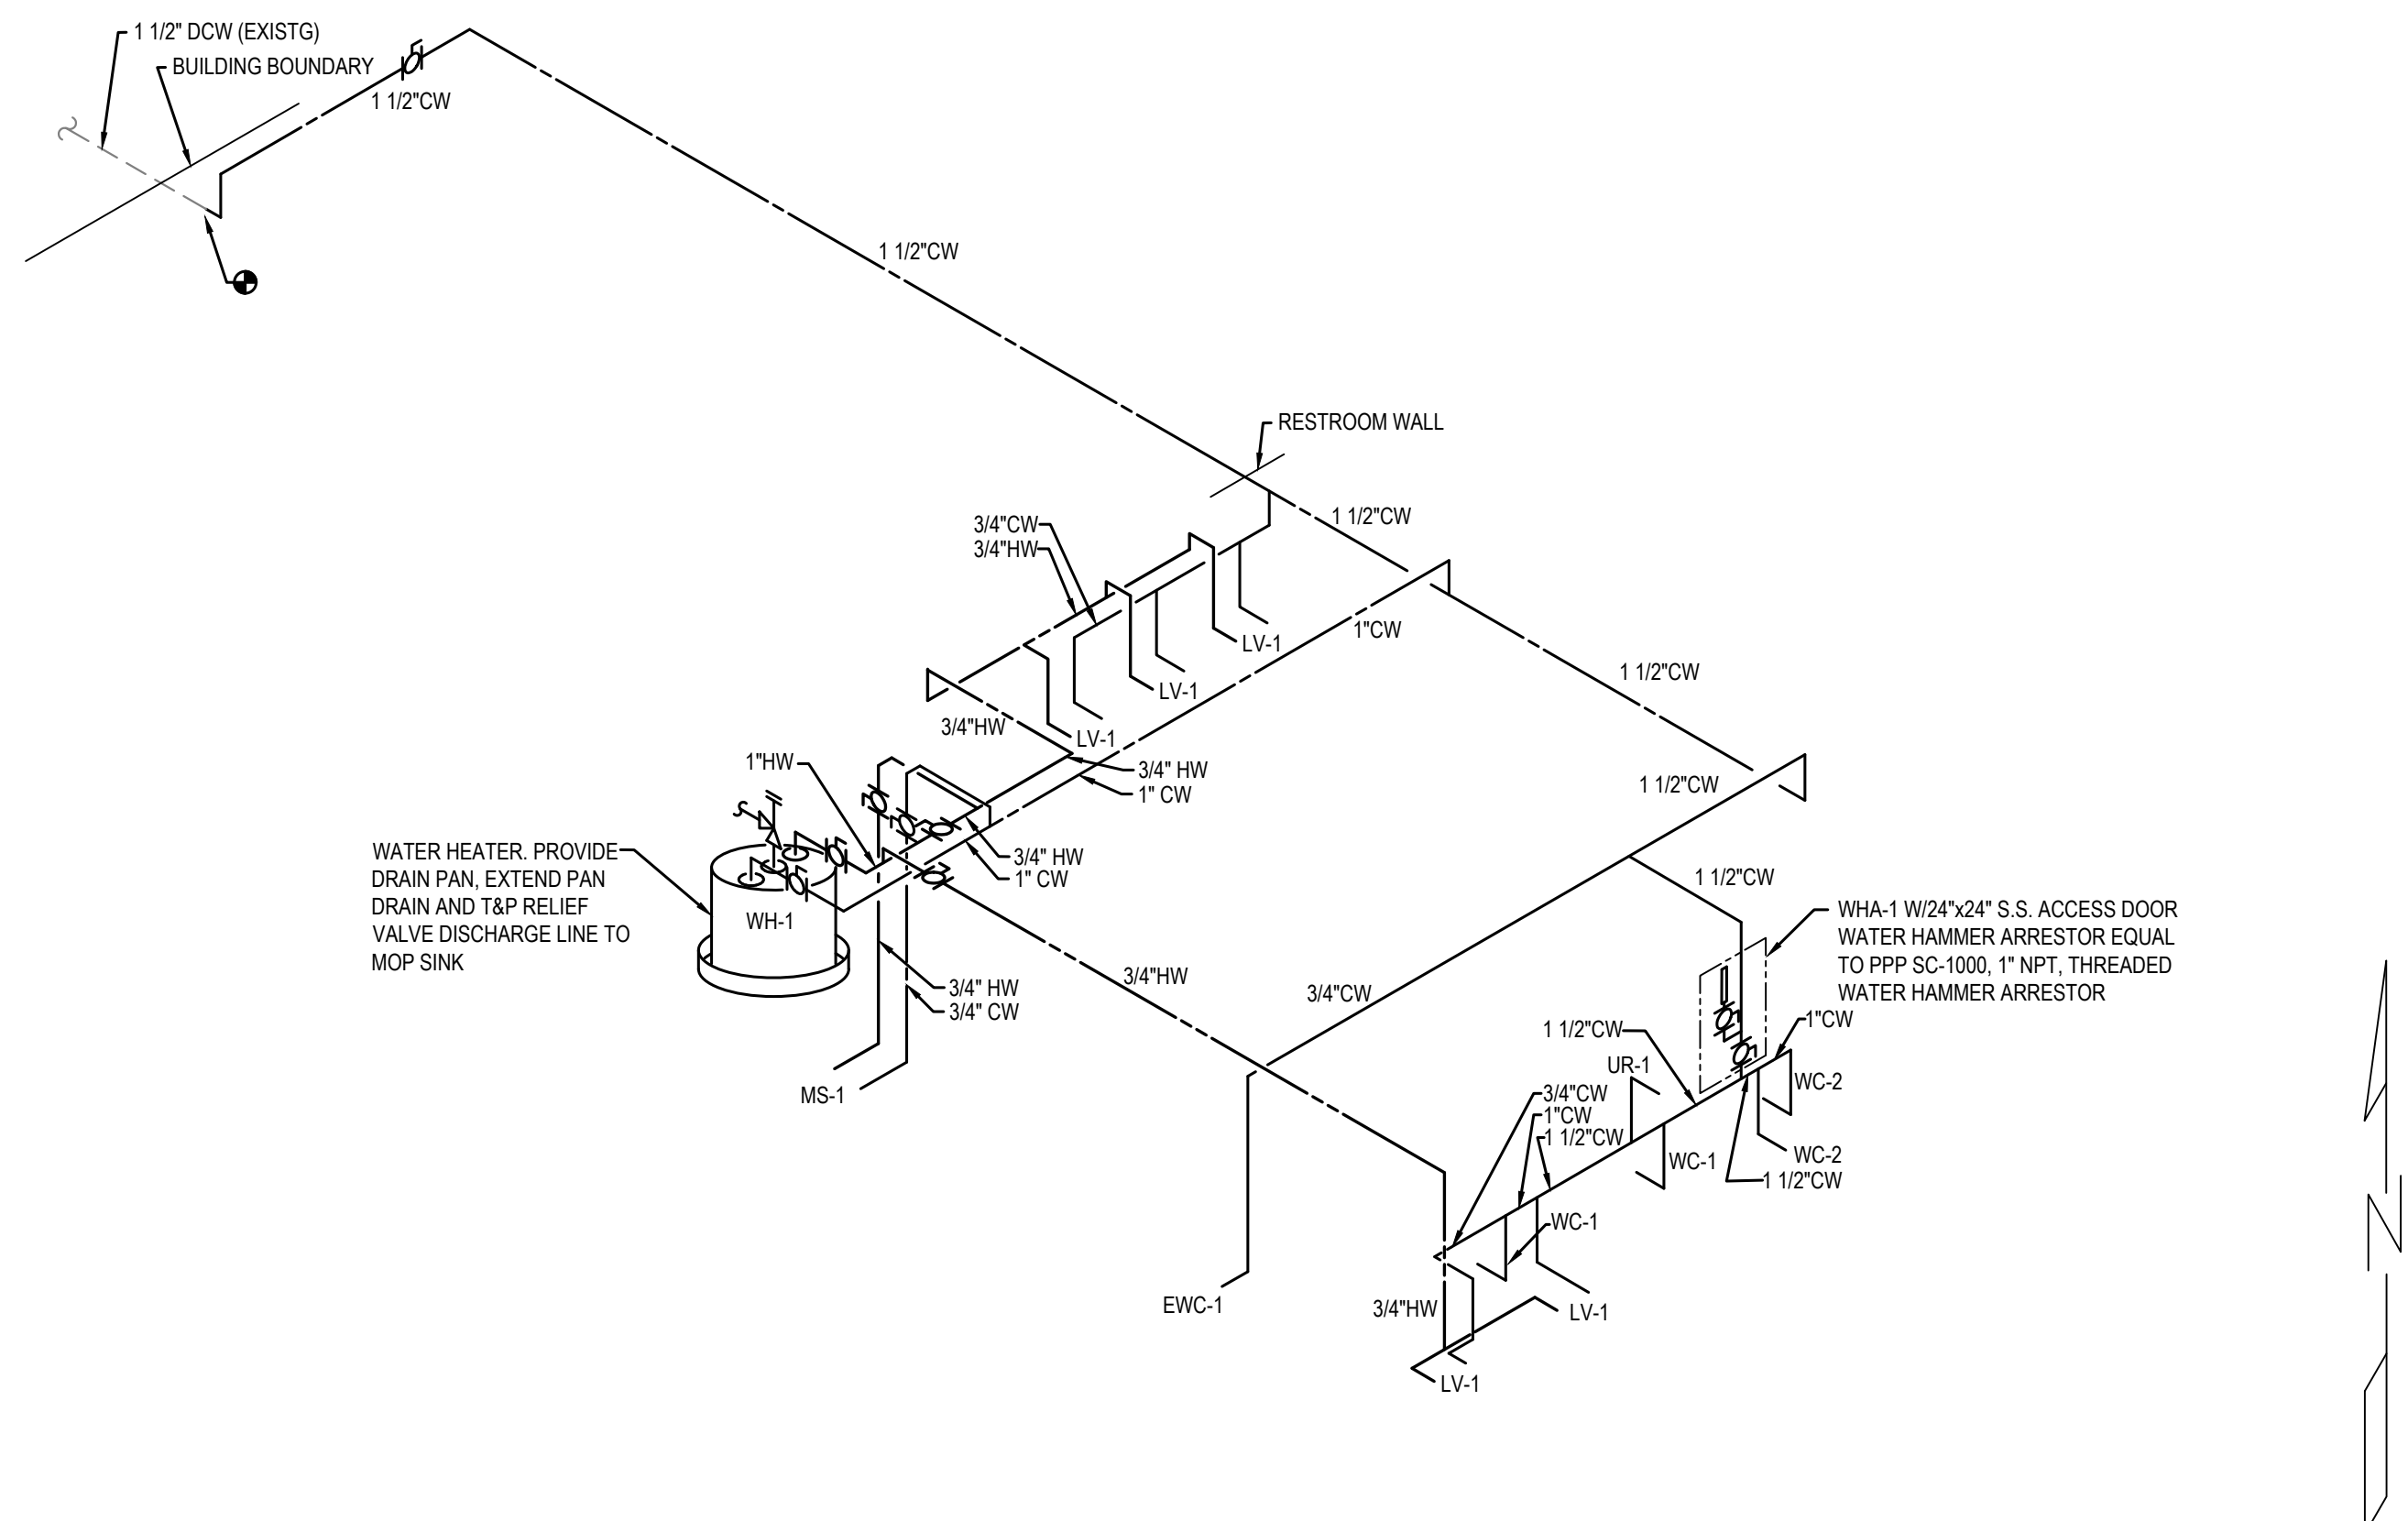3 PLUMBING RISER - DRAIN AND VENT
 WEST RESTROOM SCALE: NONE



4 PLUMBING RISER - WATER
 WEST RESTROOM SCALE: NONE

SECTION 15860 DUCT ACCESSORIES

PART 1 - GENERAL

1.1 SUBMITTALS

- A. SUBMIT IN ACCORDANCE WITH DIVISION 1.
- B. SUBMIT DAMPER MANUFACTURER'S PRINTED INSTRUCTIONS FOR METAL STUD FRAMING FOR FIRE DAMPERS IN FIRE RATED DRYWALL PARTITIONS.
- C. FOR EACH TYPE OF FIRE DAMPER AND COMBINATION FIRE-SMOKE DAMPER, PROVIDE A FIELD MOCK-UP INSTALLATION ASSEMBLY COMPLETE WITH WALL FRAMING, WALL BOARD, WALL OPENING FILLER PIECES, PERIMETER MOUNTING ANGLES, SLEEVE, BREAKAWAY DUCT CONNECTIONS, AND ACCESS DOOR. OBTAIN ARCHITECT'S APPROVAL OF MOCK-UP PRIOR TO STARTING DAMPER INSTALLATION.
- D. PROVIDE A FIELD MOCK-UP SMOKE DAMPER INSTALLATION COMPLETE WITH DAMPER OPERATOR, LINKAGE, LIMIT SWITCH, AND ACCESS DOOR. OBTAIN ARCHITECT'S APPROVAL OF MOCK-UP PRIOR TO STARTING SMOKE DAMPER INSTALLATION.

1.2 QUALITY ASSURANCE

- A. CONSTRUCT AND TEST FIRE DAMPERS IN ACCORDANCE WITH UL STANDARD 555. EACH FIRE DAMPER SHALL HAVE A 1, 1/2 OR 3 HOUR UL FIRE PROTECTION RATING, AS REQUIRED, AND SHALL INCLUDE A UL LABEL IN ACCORDANCE WITH ESTABLISHED UL LABELING PROCEDURES.
- B. CONSTRUCT FIRE DAMPER FUSIBLE LINKS TO UL STANDARD 33, FUSIBLE LINKS FOR FIRE PROTECTION SERVICE, FOR SERVICE INTENDED.
- C. DEMONSTRATE RESETTING OF FIRE DAMPERS TO AUTHORITIES HAVING JURISDICTION AND OWNER'S REPRESENTATIVE.
- D. SMOKE DAMPERS SHALL BE CLASSIFIED BY UL AS A LEAKAGE RATED DAMPER FOR USE IN SMOKE CONTROL SYSTEMS, UNDER UL 555 S, AND SHALL BEAR A UL LABEL ATTESTING TO SAME.
- E. THE OWNER RESERVES THE RIGHT TO TEST ALL CONSTANT VOLUME VALVES FOR PERFORMANCE. IF THEY DO NOT MEET SPECIFICATIONS, THE VALVES SHALL BE SENT BACK TO THE MANUFACTURER AND REPLACED AT THE MANUFACTURER'S EXPENSE.

1.3 REFERENCES

- A. ACCESSORIES SHALL MEET THE REQUIREMENTS OF NFPA 90 A AND NFPA 101, AS APPLICABLE.
- B. FABRICATE IN ACCORDANCE WITH ASHRAE HANDBOOKS AND SMACNA DUCT MANUALS.

PART 2 - PRODUCTS

2.1 ACCEPTABLE MANUFACTURERS

- A. CONTROL DAMPERS:
 1. JOHNSON CONTROLS
 2. GREENHICK
 3. RUSKIN
- B. BALANCING DAMPERS:
 1. AIR BALANCE
 2. GREENHECK
 3. RUSKIN
 4. CONTRACTOR FABRICATED
- C. ACCESS DOORS - DUCTWORK:
 1. DUCTMATE
 2. MILCOR
 3. RUSKIN
 4. CONTRACTOR FABRICATED

2.2 CONTROL DAMPERS

- A. GENERAL:
 1. PROVIDE CONTROL DAMPERS WITH OPPOSED BLADES TO SUIT APPLICATION.
 2. PROVIDE QUARTER TURN ELECTRIC ACTUATOR, 4 TO 20 MADC INPUT, AS MANUFACTURED BY HY-TORQ/E.S.M.E. COORDINATE WITH CONTROL SUBCONTRACTOR FOR OPERATORS, CONTROL ACCESSORIES, AND SEQUENCE OF OPERATION.
- B. RECTANGULAR DAMPERS:
 1. PROVIDE AIRFOIL-SHAPED, DOUBLE SKIN BLADES, WITH 14 GAUGE EQUIVALENT THICKNESS, MAXIMUM 6 INCHES WIDE, HAVING SHAFTS/BEARINGS DESIGNED TO MEET TEMPERATURE AND MAXIMUM VELOCITY (3500 FPM) REQUIREMENTS. PROVIDE MINIMUM 3/12 INCHES BY 1/8 GAUGE GALVANIZED CHANNEL FRAME. SEAL BLADE EDGES WITH EXTRUDED VINYL AND JAMB WITH FLEXIBLE METAL COMPRESSION.
 2. THE PRESSURE DROP FOR A 24 INCHES BY 24 INCHES DAMPER HANDLING 8500 CFM SHALL BE 0.08 INCH WG OR LESS UNDER STANDARD AIR CONDITIONS.
 3. DAMPERS SHALL BE RUSKIN CD60 WITH FUSIBLE LINK.
- C. ROUND DAMPERS:
 1. CONSTRUCT BLADES WITH 2 LAYERS GALVANIZED STEEL 14 GAUGE EQUIVALENT THICKNESS, NEOPRENE SEALS SANDWICHED BETWEEN BLADE SHEETS, AND SHAFTS/BEARINGS DESIGNED TO MEET DYNAMIC AND TEMPERATURE REQUIREMENTS. PROVIDE 12 GAUGE REINFORCED GALVANIZED STEEL FRAME, NEOPRENE SANDWICHED BETWEEN BLADE SHEETS.
 2. PRESSURE DROP FOR A 12 INCHES DIAMETER DAMPER HANDLING 2500 CFM SHALL BE 0.10 INCH WG OR LESS UNDER STANDARD AIR CONDITIONS.
 3. DAMPERS SHALL BE RUSKIN CDRS_25.

2.3 BALANCING DAMPERS

- A. GENERAL:
 1. PROVIDE DAMPERS THROUGHOUT THE DUCT SYSTEMS TO FACILITATE COMPLETE BALANCING.
 2. DAMPERS MAY BE VENDOR PURCHASED OR CONTRACTOR FABRICATED.
- B. RECTANGULAR DAMPERS WITH EITHER WIDTH OR HEIGHT DIMENSION LESS THAN 24 INCHES:
 1. BUTTERFLY TYPE DAMPERS WITH 18 GAUGE GALVANIZED STEEL OR DUCT CASING ANGLE REINFORCED AS REQUIRED.
 2. PROVIDE SINGLE THICKNESS 16 GAUGE MINIMUM, GALVANIZED STEEL BLADES, WELDED OR BOLTED TO 1/2 INCH MINIMUM DIAMETER THROUGH SHAFT. PERMANENTLY MARK END OF SHAFT TO INDICATE BLADE POSITION AND FIT WITH A LOCKING QUADRANT MOUNTED ON OUTSIDE OF FRAME. BEARINGS SHALL BE PRESSED INTO FRAME AND DESIGNED FOR DYNAMIC REQUIREMENTS.
- C. RECTANGULAR DAMPERS WITH BOTH WIDTH AND HEIGHT DIMENSIONS GREATER THAN 24 INCHES:
 1. FRAME, 5 INCHES BY 1 INCH, 16 GAUGE GALVANIZED STEEL CHANNEL. BLADES, 8 INCHES MAXIMUM WIDTH, 16 GAUGE GALVANIZED STEEL, OPPOSED BLADE, HAVING SHAFTS/BEARINGS DESIGNED TO MEET DYNAMIC REQUIREMENTS, POSITIVELY LOCKED TO SHAFTS.
 2. CONTROL SHAFT SHALL BE 3/8 INCH SQUARE, PLATED STEEL, PERMANENTLY MARKED TO INDICATE BLADE POSITION, AND FITTED WITH LOCKING QUADRANT MOUNTED ON OUTSIDE OF FRAME.
 3. PRESSURE DROP FOR A 28 INCHES BY 28 INCHES DAMPER HANDLING 7600 CFM SHALL BE 0.05 INCH WG OR LESS UNDER STANDARD AIR CONDITIONS.
 4. DAMPERS SHALL BE RUSKIN MD_35.
- D. ROUND DAMPERS UP TO 24 INCHES DIAMETER:
 1. FRAME SHALL BE 18 GAUGE GALVANIZED STEEL, OR DUCT CASING REINFORCED.
 2. PROVIDE SINGLE THICKNESS 16 GAUGE GALVANIZED STEEL BLADES, WELDED OR PERMANENTLY BOLTED TO 1/2 INCH MINIMUM DIAMETER THROUGH SHAFT. PERMANENTLY MARK END OF SHAFT TO INDICATE BLADE POSITION AND FIT WITH A LOCKING QUADRANT MOUNTED ON OUTSIDE OF FRAME. BEARINGS SHALL BE PRESSED INTO FRAME AND DESIGNED FOR DYNAMIC REQUIREMENTS.
- E. IDENTIFICATION: PROVIDE 1 INCH WIDE NYLON RIBBON FOR EACH DAMPER, COLOR AS FOLLOWS: SUPPLY AIR, RED; RETURN AIR, BLUE; EXHAUST AIR, YELLOW. TIE THROUGH HOLE AT END OF DAMPER QUADRANT, LEAVING AT LEAST 12 INCHES OF RIBBON HANGING FREE. ATTACH RIBBONS AT THE TIME EACH DAMPER IS INSTALLED.

2.4 ACCESS DOORS - DUCTWORK

- A. CONSTRUCTION: CLOSE FITTING RIGID GALVANIZED STEEL ASSEMBLIES WITH SEALING GASKETS AND QUICK FASTENING LOCKING DEVICES. FOR INSULATED DUCTWORK, INSTALL MINIMUM 1 INCH THICK INSULATION WITH SHEET METAL COVER.
- B. LOCKING DEVICES: PROVIDE 2 HINGES AND 2 SASH LOCKS OR 2 SPRING LOADED THREADED KNOBS AND BOLTS FOR SIZES UP TO 18 INCHES SQUARE; 2 HINGES AND 2 COMPRESSION LATCHES WITH OUTSIDE AND INSIDE HANDLES FOR SIZES UP TO 24 INCHES BY 48 INCHES. PROVIDE AN ADDITIONAL HINGE FOR LARGER SIZES.
- C. OPTION: DOORS MAY BE VENDOR PURCHASED OR CONTRACTOR FABRICATED.

2.5 FLEXIBLE CONNECTIONS

- A. FABRICATE OF NEOPRENE COATED FLAMEPROOF FABRIC TIGHTLY CRIMPED INTO METAL EDGING STRIP AND ATTACH TO DUCTING AND EQUIPMENT BY SCREWS OR BOLTS AT 8 INCH INTERVALS. FLEXIBLE DUCT CONNECTIONS SHALL BE PROVIDED WITH A SUFFICIENT MATERIAL WIDTH TO PREVENT INTERFERENCE WITH FREE OPERATION OF FAN VIBRATION ISOLATION SYSTEMS.

2.6 APPLICATION

- A. ACCESS DOORS: PROVIDE FOR INSPECTION AND CLEANING BEFORE AND AFTER FILTERS, COILS, FANS, AUTOMATIC DAMPERS, AT FIRE DAMPERS, SMOKE DAMPERS, AND COMBINATION FIRE/SMOKE DAMPERS. REVIEW LOCATIONS PRIOR TO FABRICATION. DOORS SHALL BE SQUARE, SIZED TO 3/4 OF THE LARGER OF THE DUCT WIDTH OR HEIGHT, BUT NO SMALLER THAN 8 INCHES BY 8 INCHES NOR NO LARGER THAN 24 INCHES BY 24 INCHES. PROVIDE 4 INCHES BY 4 INCHES QUICK-OPENING DUCT ACCESS DOORS FOR INSPECTION AT BALANCING DAMPERS.
- B. BALANCING DAMPERS, LOW PRESSURE: PROVIDE BALANCING DAMPERS AT ALL POINTS WHERE SUPPLY, RETURN, AND EXHAUST SYSTEM SUBMAINS, BRANCH MAINS AND BRANCHES ARE TAKEN FROM LARGER DUCTS, AND AS SHOWN IN TYPICAL DETAILS.

DRAWINGS, AND DIAGRAMS.



- C. BALANCING DAMPERS, MEDIUM AND HIGH PRESSURE: PROVIDE BALANCING DAMPERS ON SYSTEMS AS SHOWN IN TYPICAL DETAILS, DRAWINGS, AND DIAGRAMS. DO NOT USE SPLITTER DAMPERS EXCEPT WHERE SPECIFICALLY INDICATED ON DRAWINGS.
- D. FLEXIBLE CONNECTIONS: PROVIDE IMMEDIATELY ADJACENT TO EQUIPMENT IN DUCTS ASSOCIATED WITH FANS AND EQUIPMENT SUBJECT TO FORCED VIBRATION. IN ADDITION, PROVIDE FLEXIBLE CONNECTIONS WHERE DUCTWORK CROSSES BUILDING EXPANSION JOINTS AND WHERE DUCTWORK CROSSES SEPARATIONS BETWEEN NEW AND EXISTING CONSTRUCTION.

PART 3 - EXECUTION

3.1 INSTALLATION



- A. INSTALL ITEMS IN ACCORDANCE WITH MANUFACTURER'S PRINTED INSTRUCTIONS AND SMACNA STANDARDS.
- B. FOR CONNECTIONS TO MEDIUM AND HIGH PRESSURE FANS, INSTALL 1/8 INCH THICK NEOPRENE PAD OVER FABRIC AND HOLD IN PLACE WITH ADDITIONAL METAL STRIPS.
- C. LOCATE DUCT ACCESS DOORS FOR EASY ACCESS. LOCATE DOORS ABOVE ACCESSIBLE CEILINGS WHENEVER POSSIBLE. COORDINATE LOCATIONS OF CEILING ACCESS DOORS WITH CEILING INSTALLER AND WITH OTHER TRADES SUCH THAT CONDUIT AND PIPE DOES NOT PREVENT OR INTERFERE WITH ACCESS TO DUCTWORK. REFER TO SECTION 15010 FOR ACCESS DOOR REQUIREMENTS IN CEILINGS AND WALLS.
- D. MOUNT DAMPER OPERATORS, CONTROL DEVICES, THERMOMETERS, AND GAUGES UPON EXTENSION BRACKETS OR DEVICES TO PREVENT INTERFERENCE WITH INSULATION OR VAPOR BARRIER INTEGRITY.

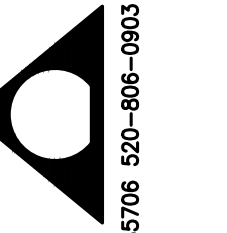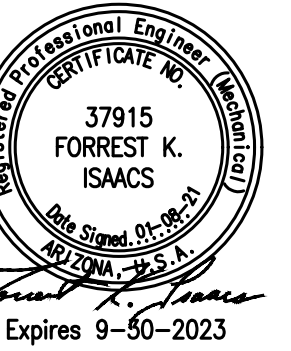END OF SECTION



ADVANTECH
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WINDOWS ON
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OUTREACH

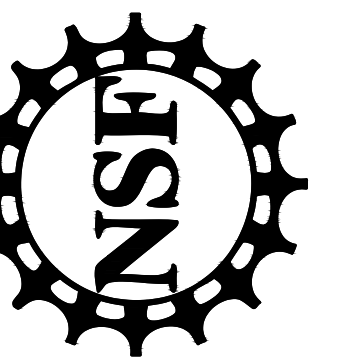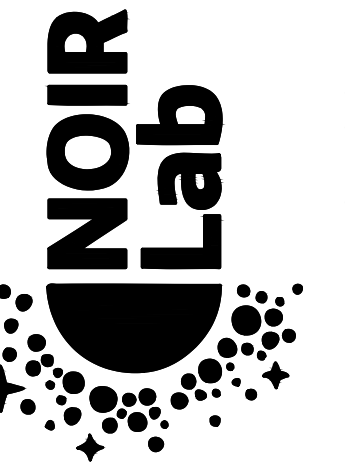

KITT PEAK - Sells, AZ 85634

△	DATE	DESCRIPTION
0	01/08/21	I.F.C.

PROJECT NUMBER: 11904.00

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CHECKED BY: FI

CAD FILE: 11904.00-M9.6

SCALE: NONE

MECHANICAL
SPECIFICATIONS

M9.6

ABBREVIATIONS

Table of abbreviations for electrical symbols, including categories like AMPERES, ALUMINUM, C, CB, CATV, etc., with corresponding symbols and descriptions.

SYMBOL LIST

POWER

Table of symbols for power-related components such as panelboards, grounding points, circuit breakers, junction boxes, conduits, and transformers.

LIGHTING

Table of symbols for lighting fixtures including fluorescent, incandescent, and directional lighting, as well as emergency lighting and photocells.

FIRE ALARM

Table of symbols for fire alarm components such as pull stations, horns, strobes, flow switches, and detectors.

SECURITY

Table of symbols for security components including magnetic swipe readers, door strikes, and CCTV outlets.

TELECOM

Table of symbols for telecommunications components like voice/data outlets and dimmer switches.

AUDIO VISUAL

Table of symbols for audio-visual components such as CATV terminal boards and ground wires.

GENERAL NOTES:

- List of general notes for electrical work, including requirements for workmanship, safety, and coordination with other trades.

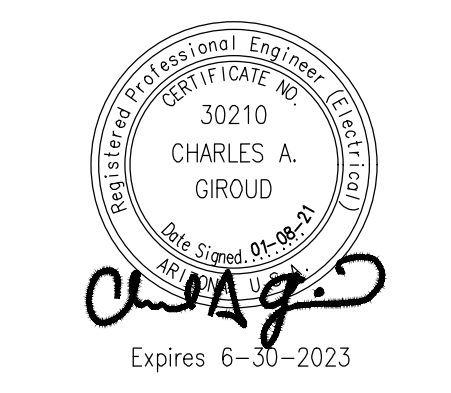
GENERAL DEMOLITION NOTES:

- List of general demolition notes regarding lighting fixtures, fire alarm devices, and other equipment to be removed.

SPECIFICATIONS

Text block containing detailed specifications for materials, equipment, and installation practices, including references to NEC and manufacturer standards.

Text block containing detailed specifications for electrical identification, lighting, fire alarm, emergency lighting, and communications systems.



Vertical text: WINDOWS ON THE UNIVERSE CENTER FOR ASTRONOMY OUTREACH

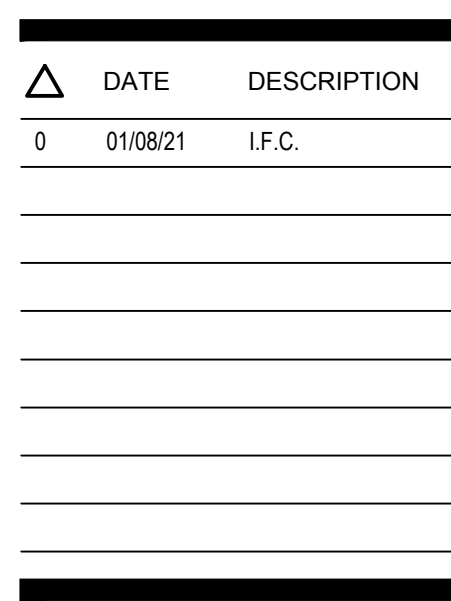
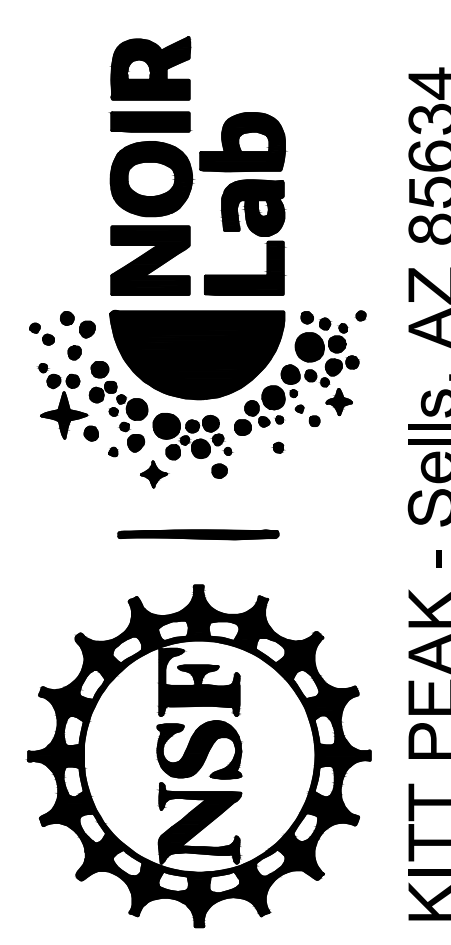


Table with columns for DATE and DESCRIPTION, showing a record for 01/08/21 I.F.C.

PROJECT NUMBER: 11904.00
DRAWN BY: CH
CHECKED BY: CG
CAD FILE: 11904.00-E0.0
SCALE: AS SHOWN

ELECTRICAL SYMBOLS & ABBREVIATIONS

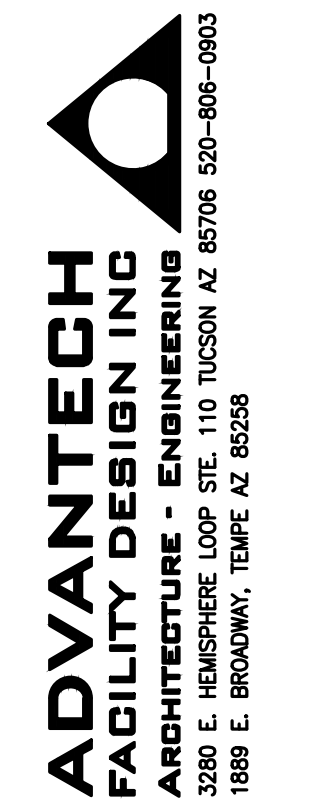
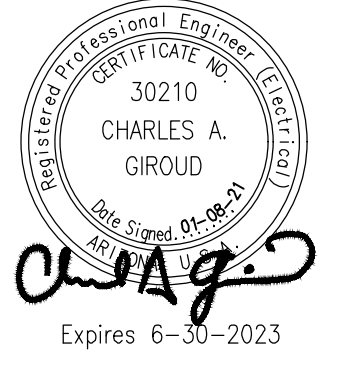
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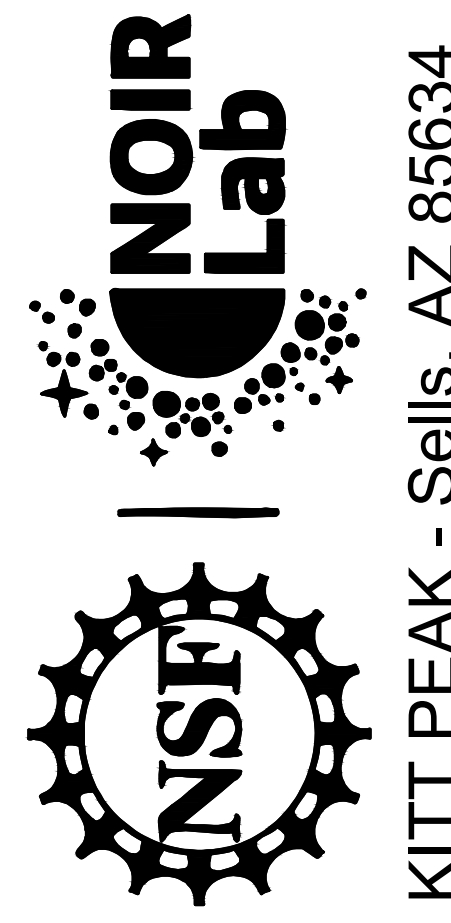
REFER TO SHEET E0.0 AND THE ENTIRE SET FOR ADDITIONAL INFORMATION AND REQUIREMENTS

KEYNOTES:

- EXISTING 480V FEEDER TO REMAIN, RECONNECT TO NEW SERVICE ENTRANCE. SEE SHEETS E1.1 AND E7.0 FOR MORE INFORMATION.
- PROVIDE NEW 480V FEEDER, SUPPORT ALONG TUNNEL WALL USING U-CHANNEL SUPPORTS. PROVIDE PULL BOXES AND OFF-SETS AS REQUIRED TO COORDINATE WITH TUNNEL ARCHITECTURE AND EXISTING EQUIPMENT. SEE SHEETS E1.1 AND E7.0 FOR MORE INFORMATION.
- ROUTE NEW 480V FEEDER TIGHT TO STRUCTURE, PROVIDE PULL BOXES AND OFF-SETS AS REQUIRED TO COORDINATE WITH ARCHITECTURAL CEILING STRUCTURE AND PLUMB/HVAC EQUIPMENT.



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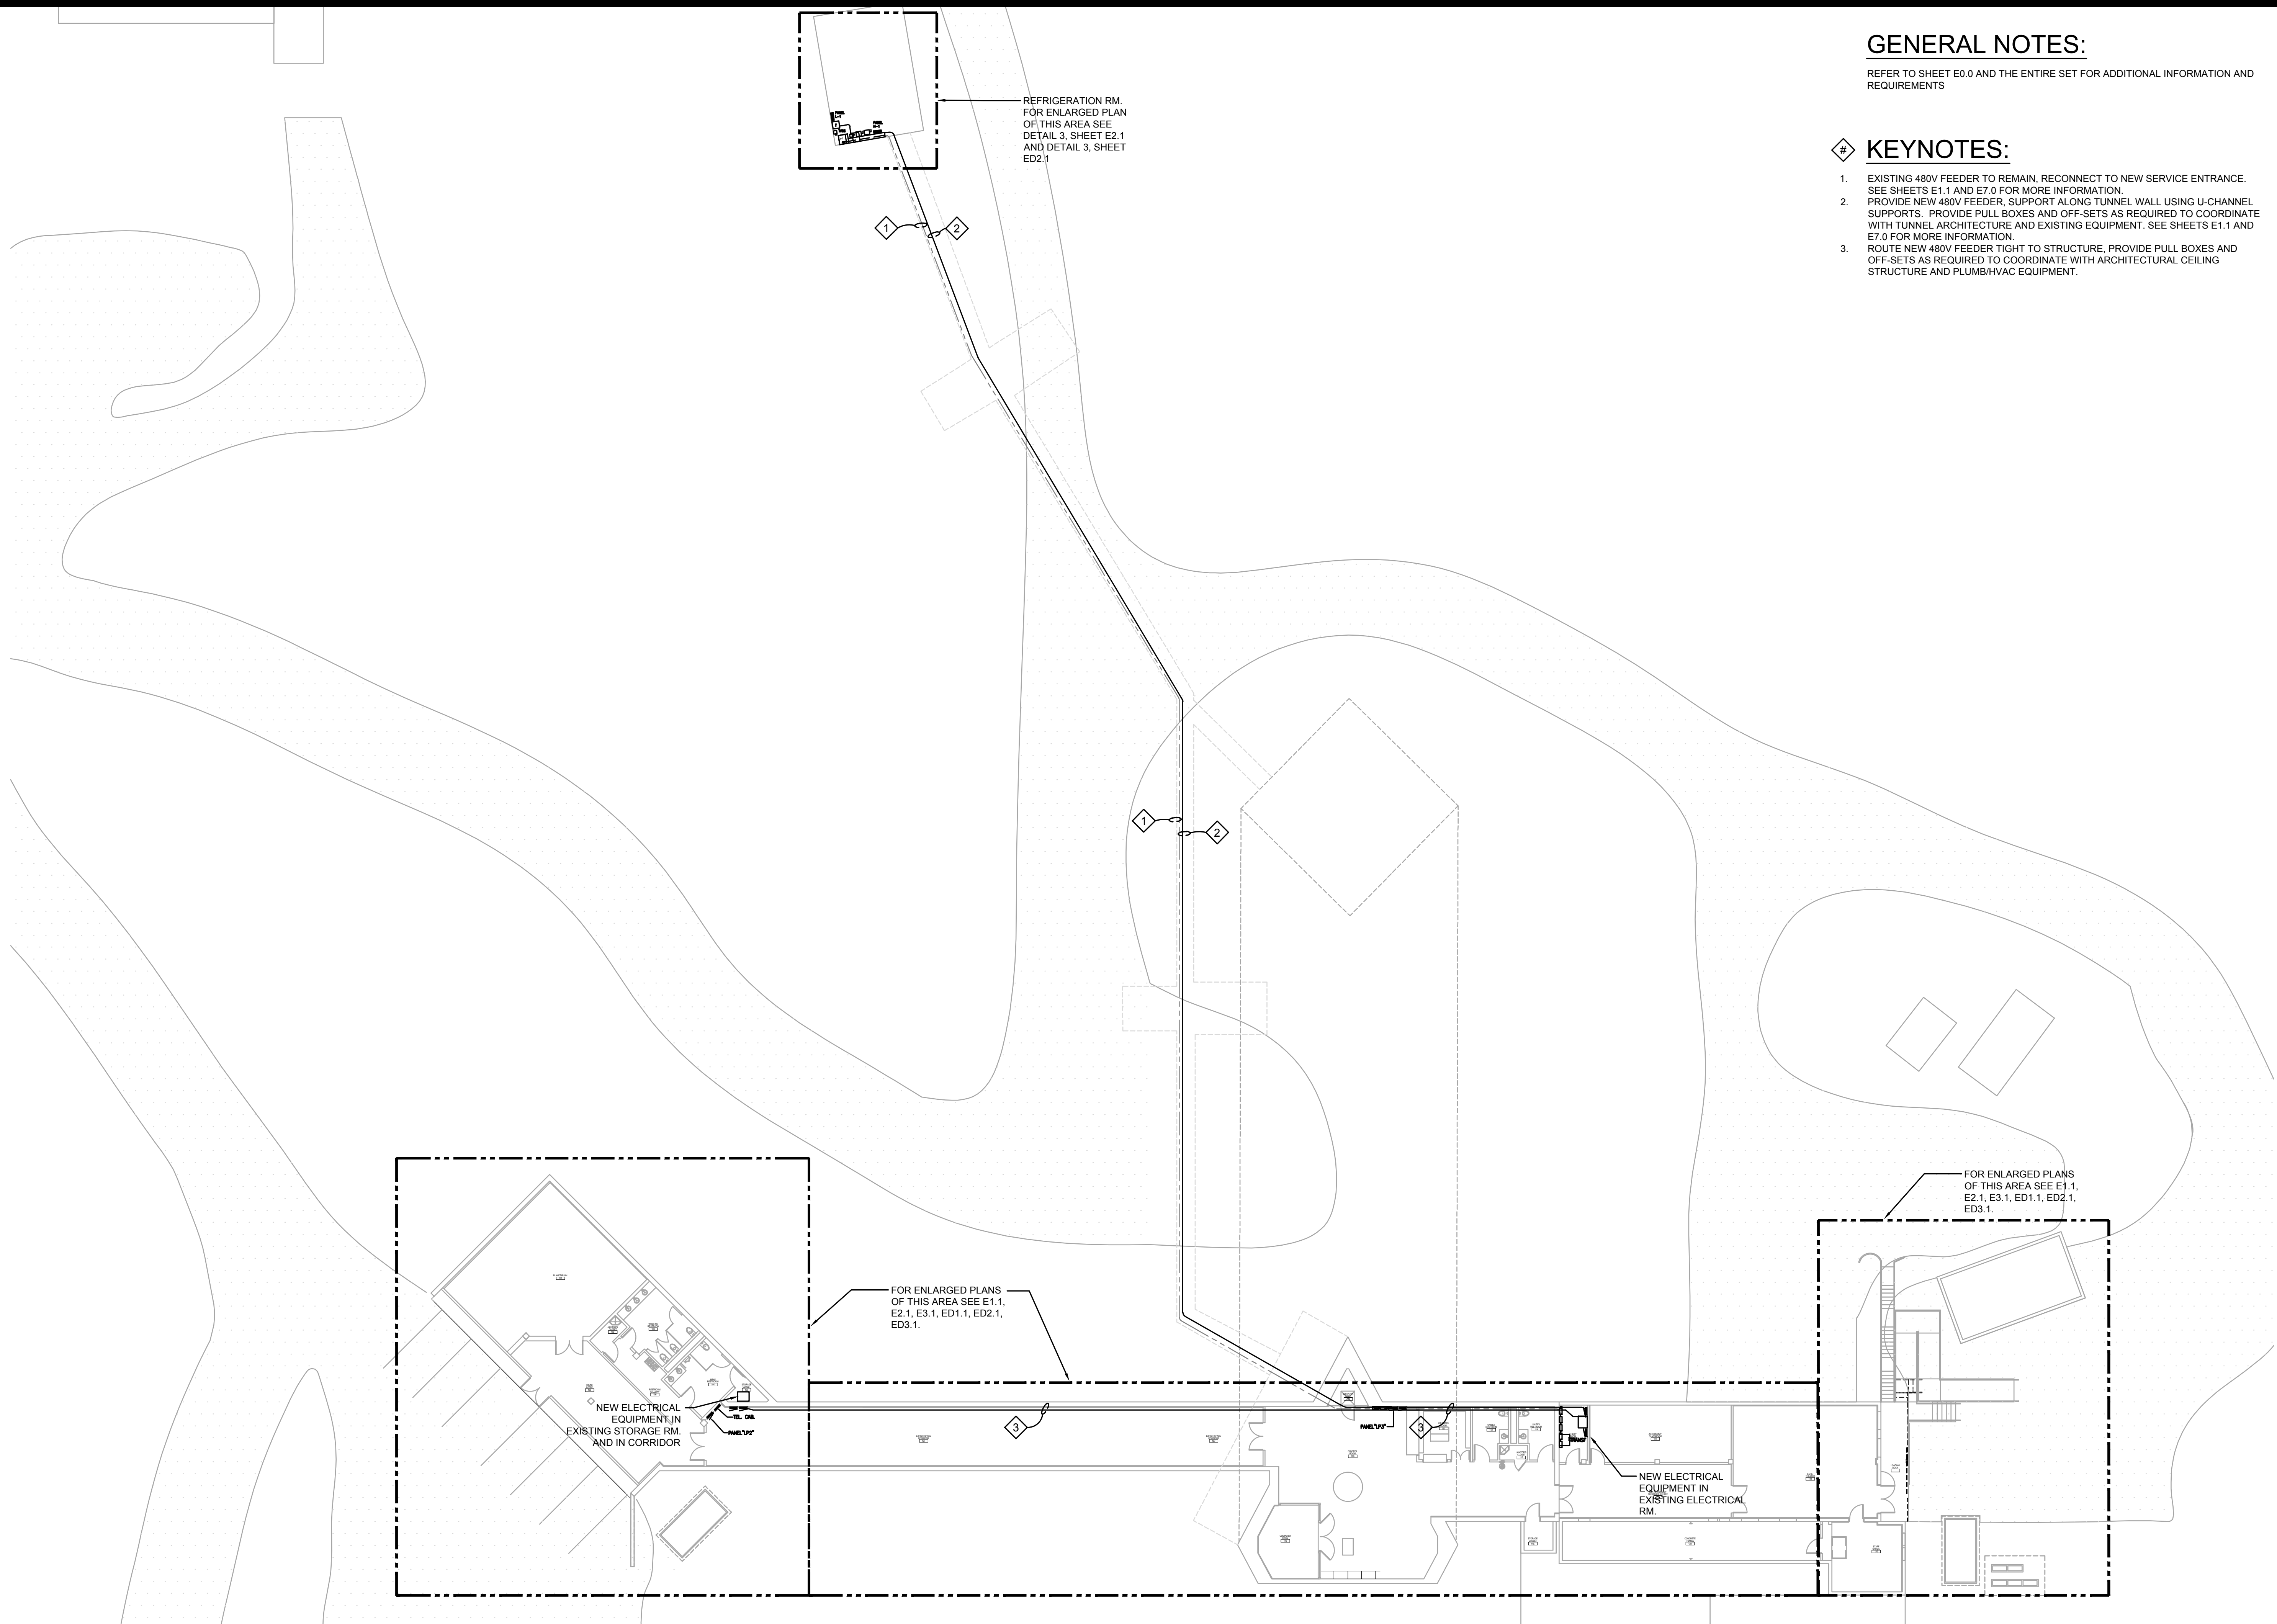
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△	DATE	DESCRIPTION
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ELECTRICAL
 OVERALL & UNDERGROUND
 FEEDER PLAN

E0.1



REFRIGERATION RM.
 FOR ENLARGED PLAN
 OF THIS AREA SEE
 DETAIL 3, SHEET
 ED2.1
 AND DETAIL 3, SHEET
 ED2.1

1 2

1 2

FOR ENLARGED PLANS
 OF THIS AREA SEE E1.1,
 E2.1, E3.1, ED1.1, ED2.1,
 ED3.1.

FOR ENLARGED PLANS
 OF THIS AREA SEE E1.1,
 E2.1, E3.1, ED1.1, ED2.1,
 ED3.1.

NEW ELECTRICAL
 EQUIPMENT IN
 EXISTING STORAGE RM.
 AND IN CORRIDOR

NEW ELECTRICAL
 EQUIPMENT IN
 EXISTING ELECTRICAL
 RM.

1 ELECTRICAL OVERALL AND UNDERGROUND FEEDER PLAN
 1ST LEVEL



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GENERAL NOTES:



REFER TO SHEET E0.0 AND THE ENTIRE SET FOR ADDITIONAL INFORMATION AND REQUIREMENTS

KEYNOTES:

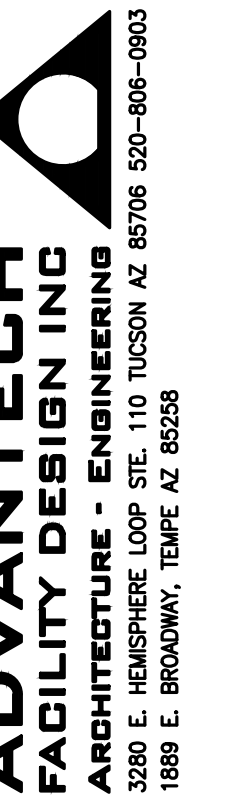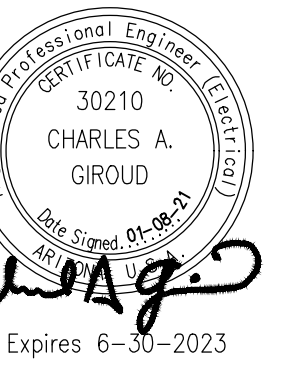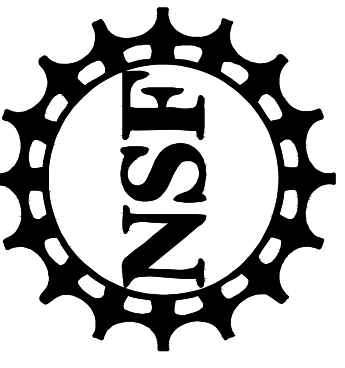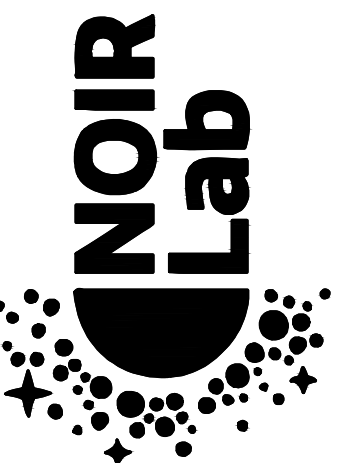1. REMOVE LIGHT FIXTURE AND ASSOCIATED CIRCUITS BACK TO SOURCE.
2. REMOVE EMERGENCY/EXIT LIGHT AND ASSOCIATED CIRCUITS BACK TO SOURCE.
3. LIGHT FIXTURE TO REMAIN, RECONNECT TO NEW CIRCUITS.
4. REMOVE WIREMOLD, RECEPTACLES AND ASSOCIATED CIRCUITS BACK TO PANEL.
5. REMOVE RECEPTACLE AND ASSOCIATED CIRCUITS BACK TO NEAREST JUNCTION POINT.
6. REMOVE ALL ELECTRICAL DEVICES AND WIRING. VERIFY WITH OWNER PRIOR TO REMOVAL FOR TELESCOPE CONTROLS AND COMPONENTS REQUIRED TO MAINTAIN OPERATIONS OR BE TURNED OVER TO THE OWNER.
7. REMOVE LIGHT SWITCHES AND ASSOCIATED CIRCUITS TO SOURCE.



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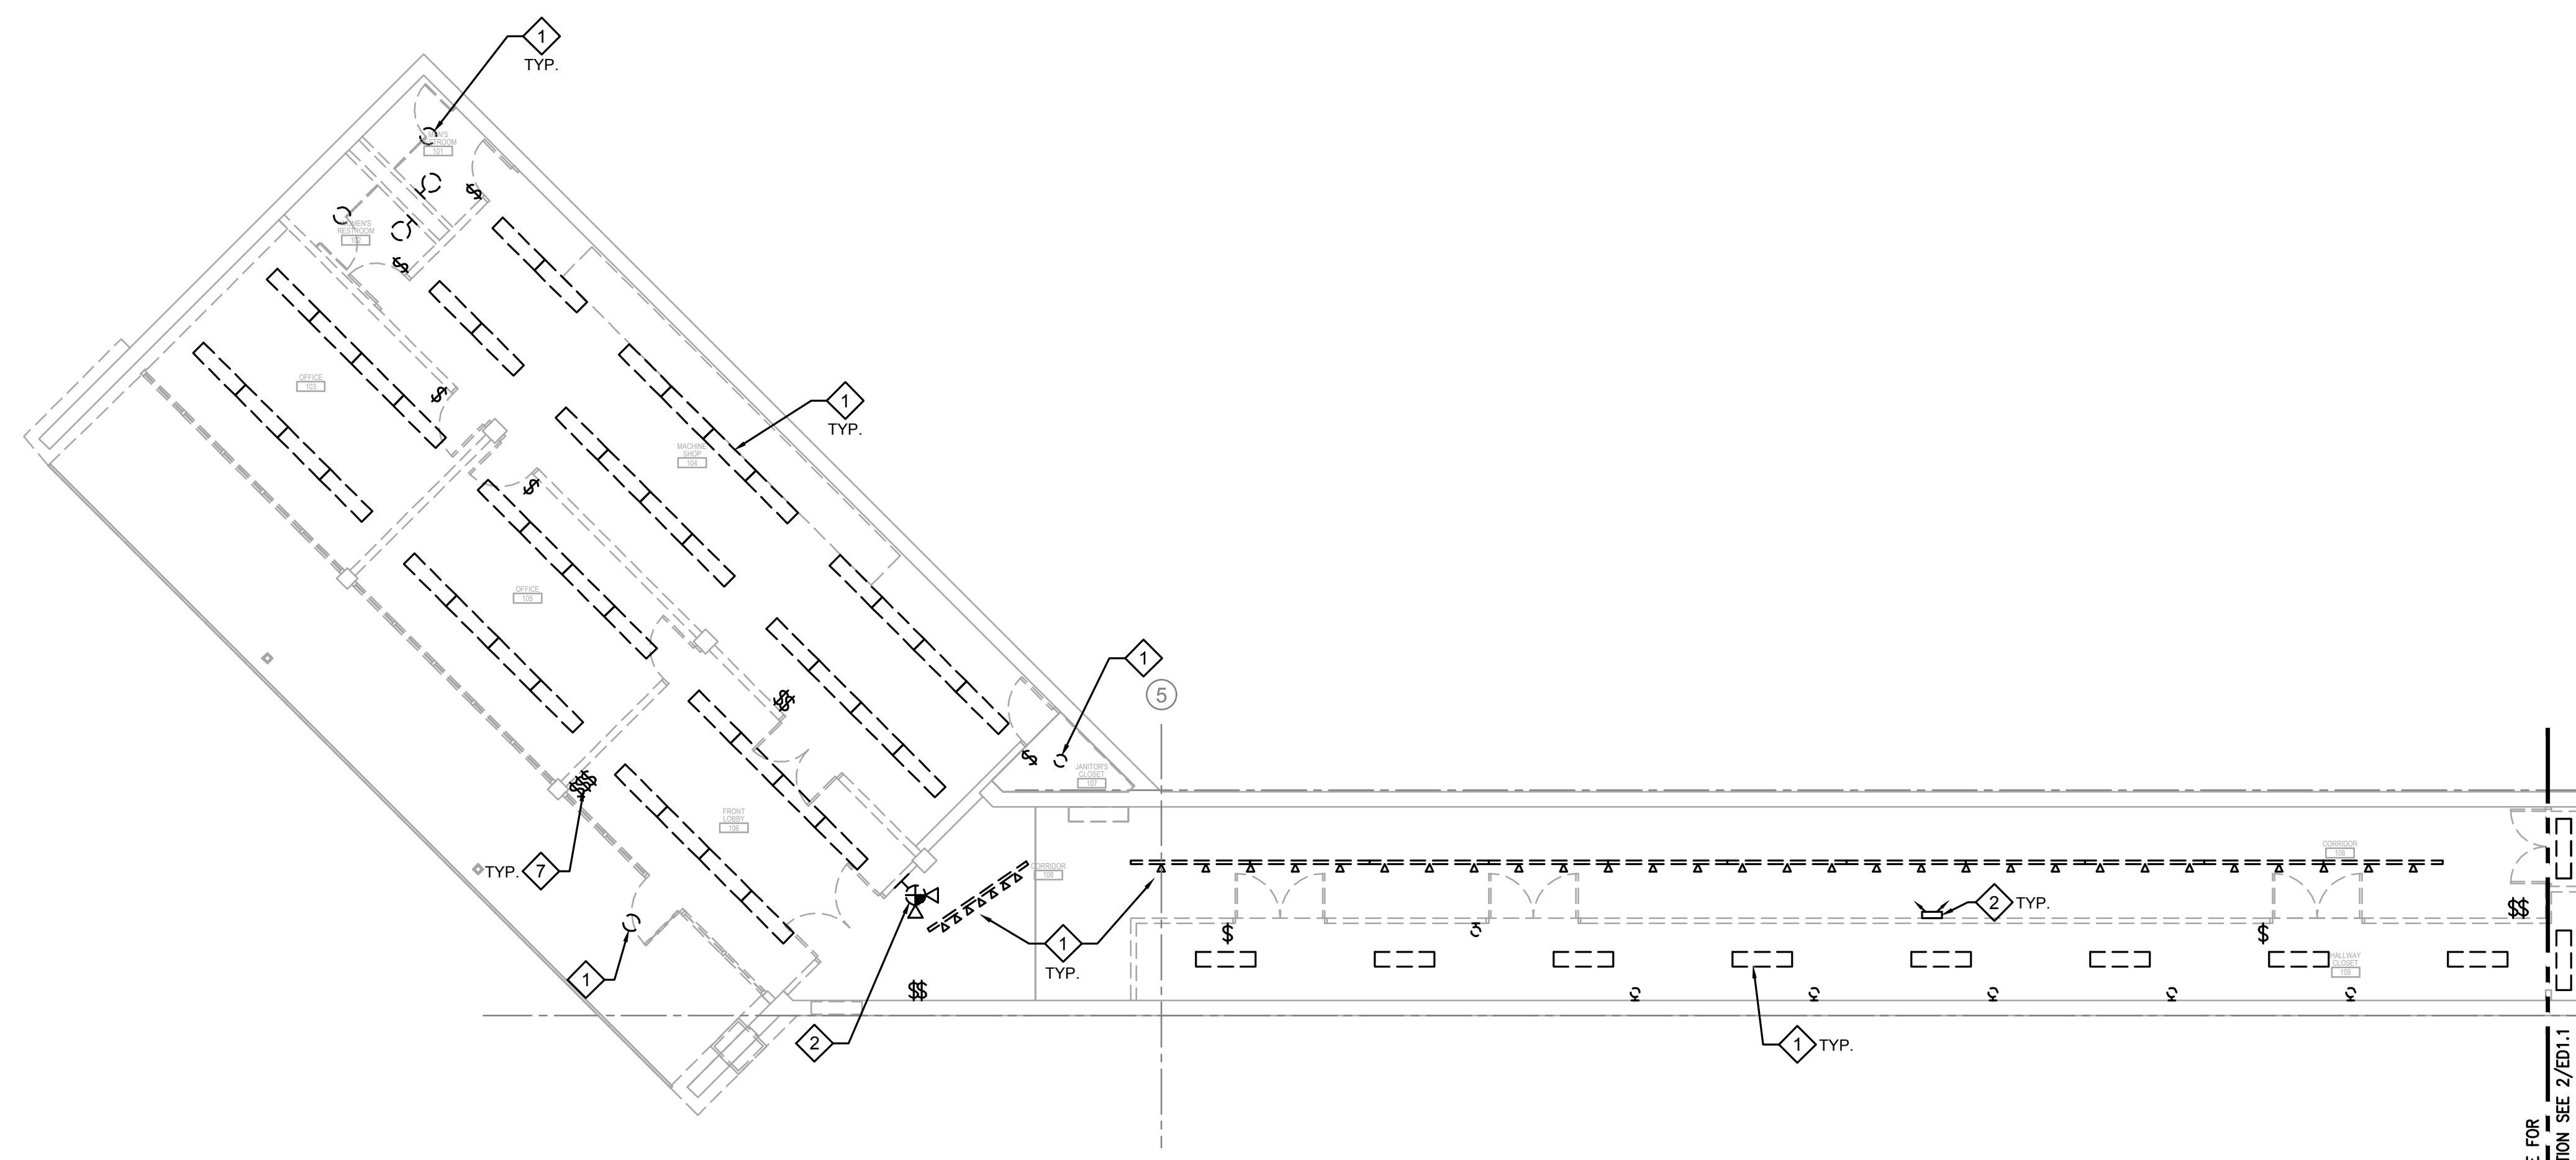
KITT PEAK - Sells, AZ 85634

DATE	DESCRIPTION
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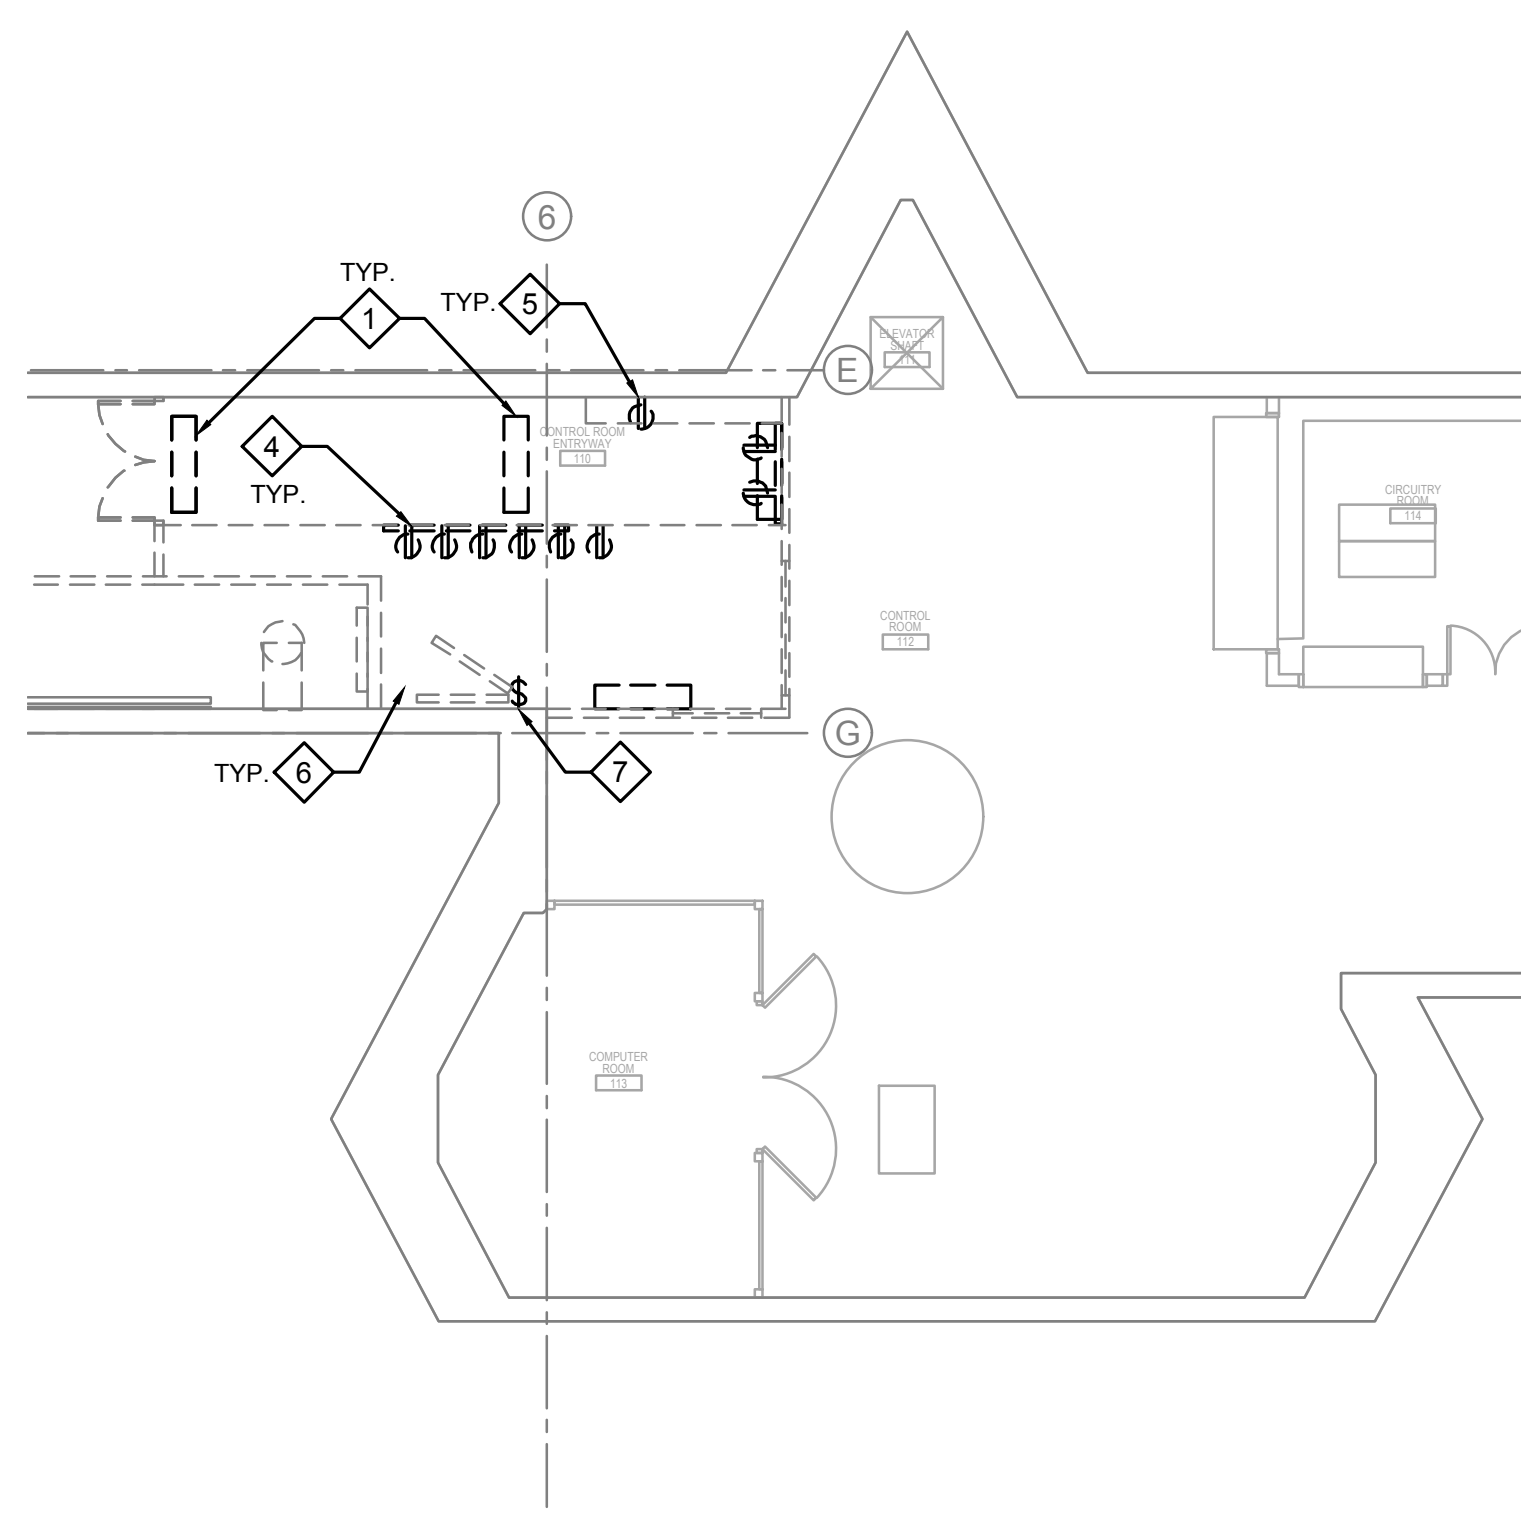
ELECTRICAL
LIGHTING
DEMOLITION PLANS

ED1.1



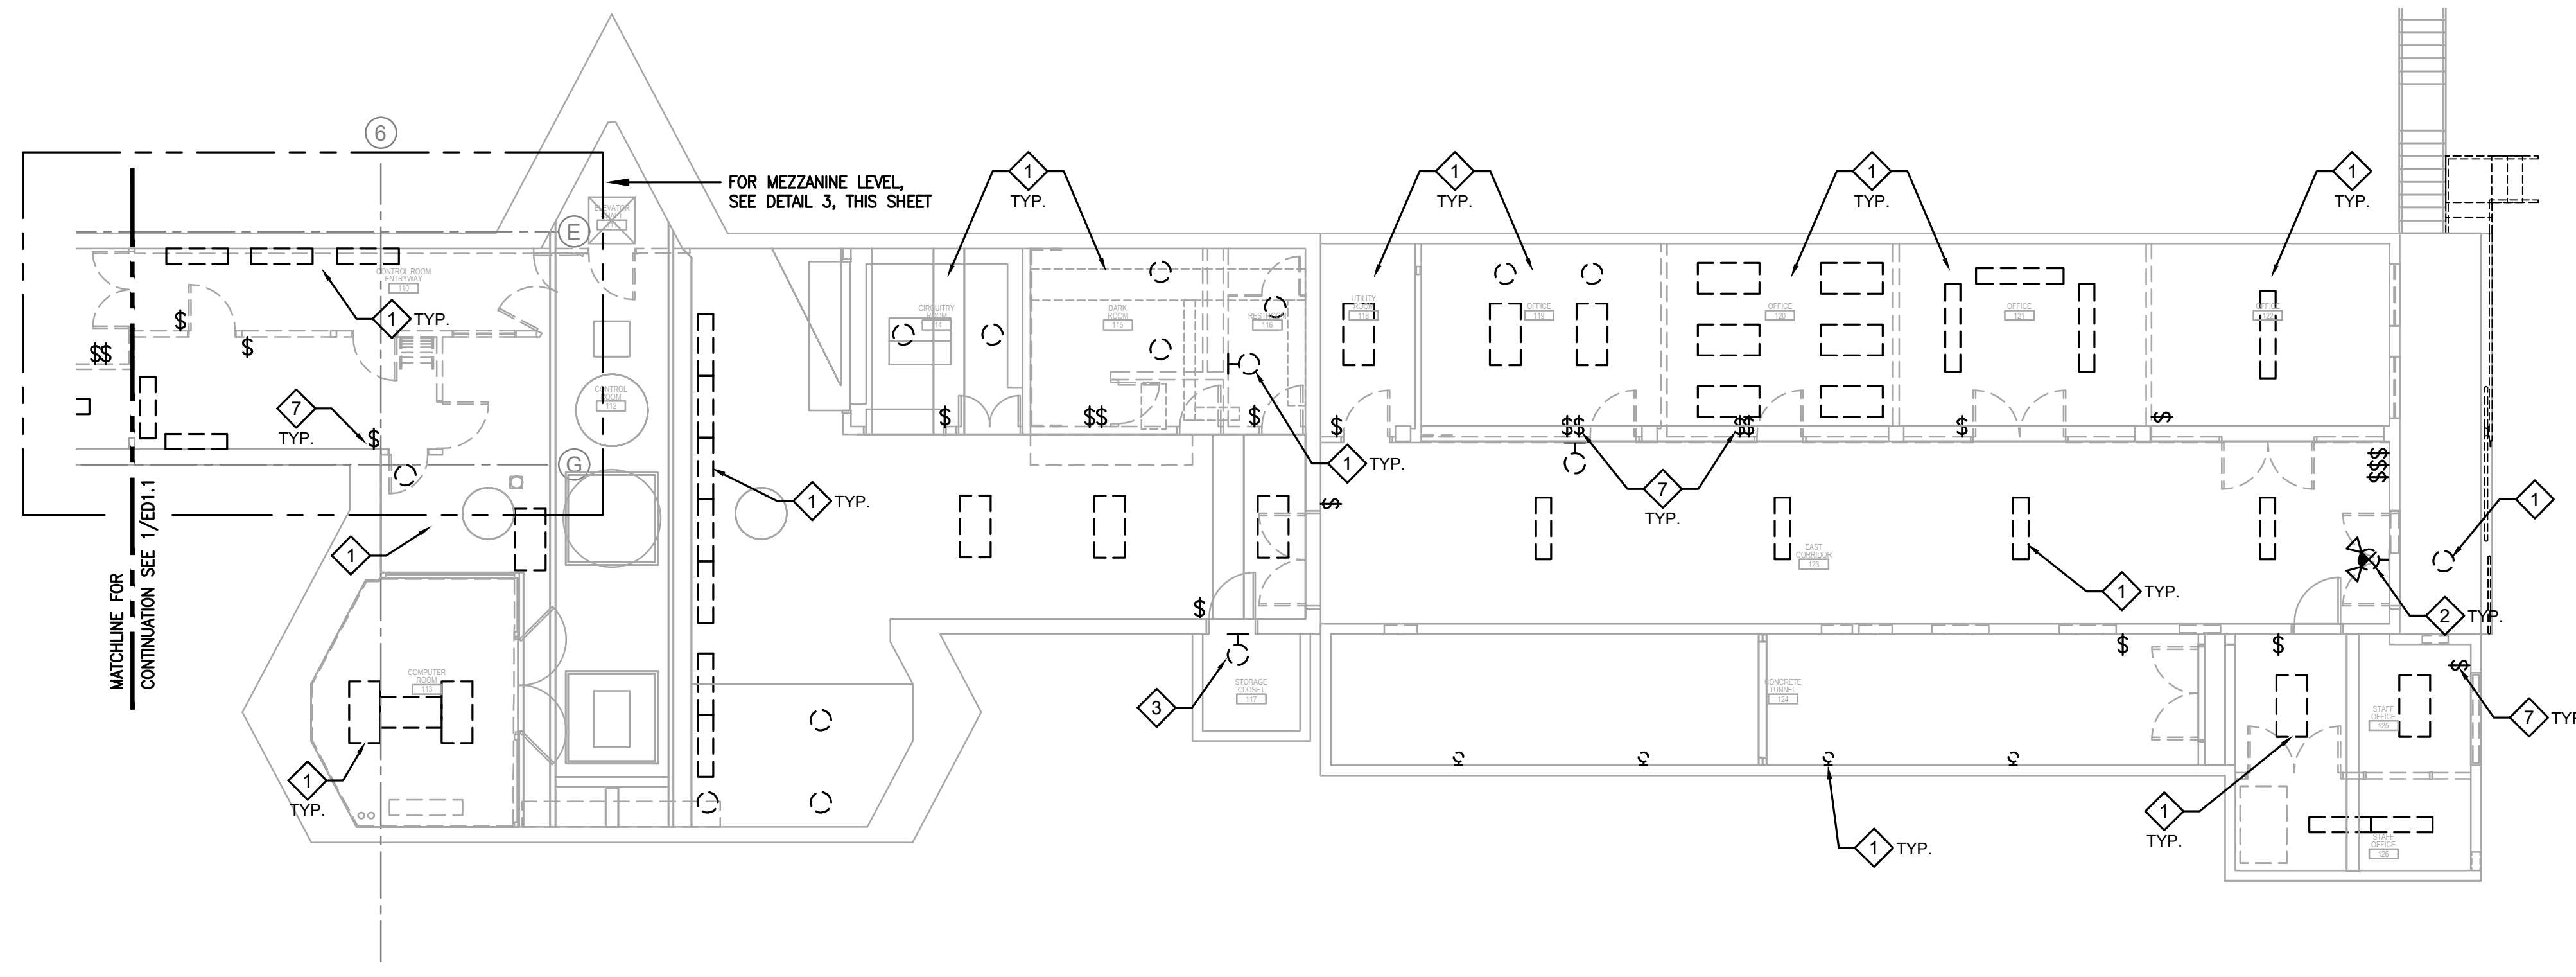
1 ELECTRICAL LIGHTING DEMOLITION PLAN
1ST LEVEL

SCALE: 1/8"-1'-0"
N



3 ELECTRICAL POWER AND LIGHTING DEMOLITION PLAN
MEZZANINE LEVEL

SCALE: 1/8"-1'-0"
N



2 ELECTRICAL LIGHTING DEMOLITION PLAN
1ST LEVEL


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GENERAL NOTES:

REFER TO SHEET E0.0 AND THE ENTIRE SET FOR ADDITIONAL INFORMATION AND REQUIREMENTS

KEYNOTES:

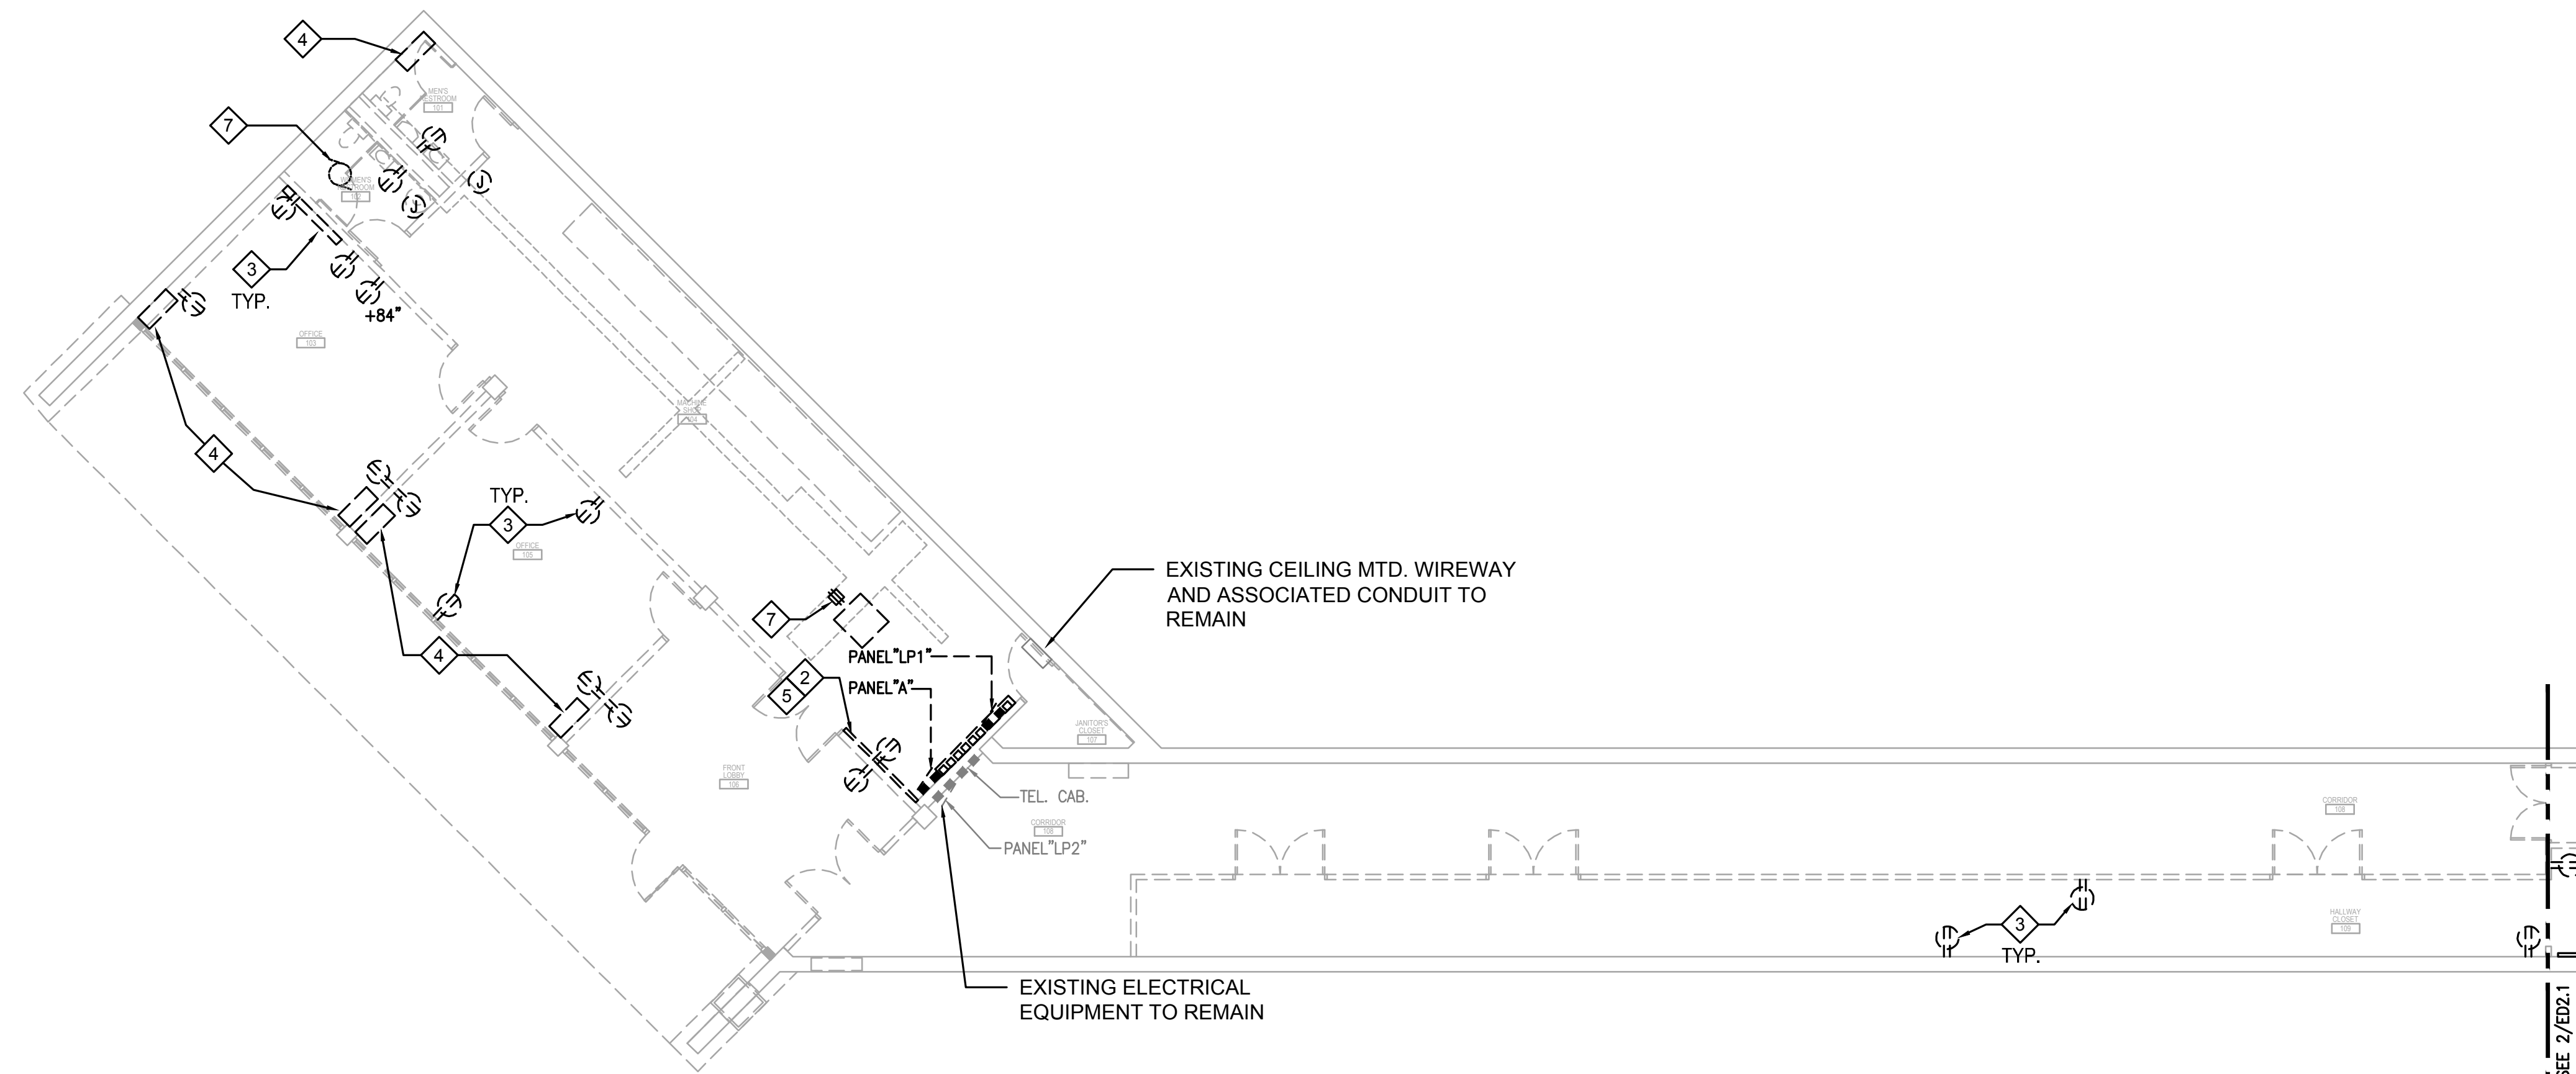
1. REMOVE BUS DUCT AND ASSOCIATED CIRCUIT IN THIS ROOM BACK TO NEAREST ACTIVE POINT. ALL WIREMOLD IN THIS ROOM (113) TO REMAIN.
2. REMOVE WIREWAY AND ASSOCIATED CIRCUITS BACK TO NEAREST POWER SOURCE.
3. REMOVE RECEPTACLES AND ASSOCIATED CIRCUITS BACK TO NEAREST ACTIVE POINT.
4. REMOVE EXISTING ELECTRICAL UNIT HEATER CIRCUITING BACK TO PANEL.
5. REMOVE ELECTRICAL EQUIPMENT INCLUDING PANEL BOARD AND ASSOCIATED CIRCUITS BACK TO SOURCE.
6. REMOVE ELECTRICAL PANEL BOARDS, DISCONNECTS, GUTTER SYSTEMS, ETC. BACK TO SOURCE. VERIFY WITH OWNER ANY CIRCUITS REQUIRED TO REMAIN IN OPERATION PRIOR TO REMOVAL. FOR PRICING PURPOSES MAKE ALLOWANCE FOR THE RE-SUPPLY OF (10) 120V. CIRCUITS FROM NEW PANELS USING #10AWG CONDUCTORS IN CONDUIT.
7. REMOVE CONNECTIONS TO HVAC EQUIPMENT AND ASSOCIATED CIRCUITS BACK TO SOURCE.
8. REMOVE MCC AND PORTION OF EXISTING FEEDER CONDUIT. RETAIN FEEDER FOR RECONNECTION TO NEW SERVICE EQUIPMENT.



1 ELECTRICAL POWER DEMOLITION PLAN
1ST LEVEL


SCALE: 1/8"-1'-0"

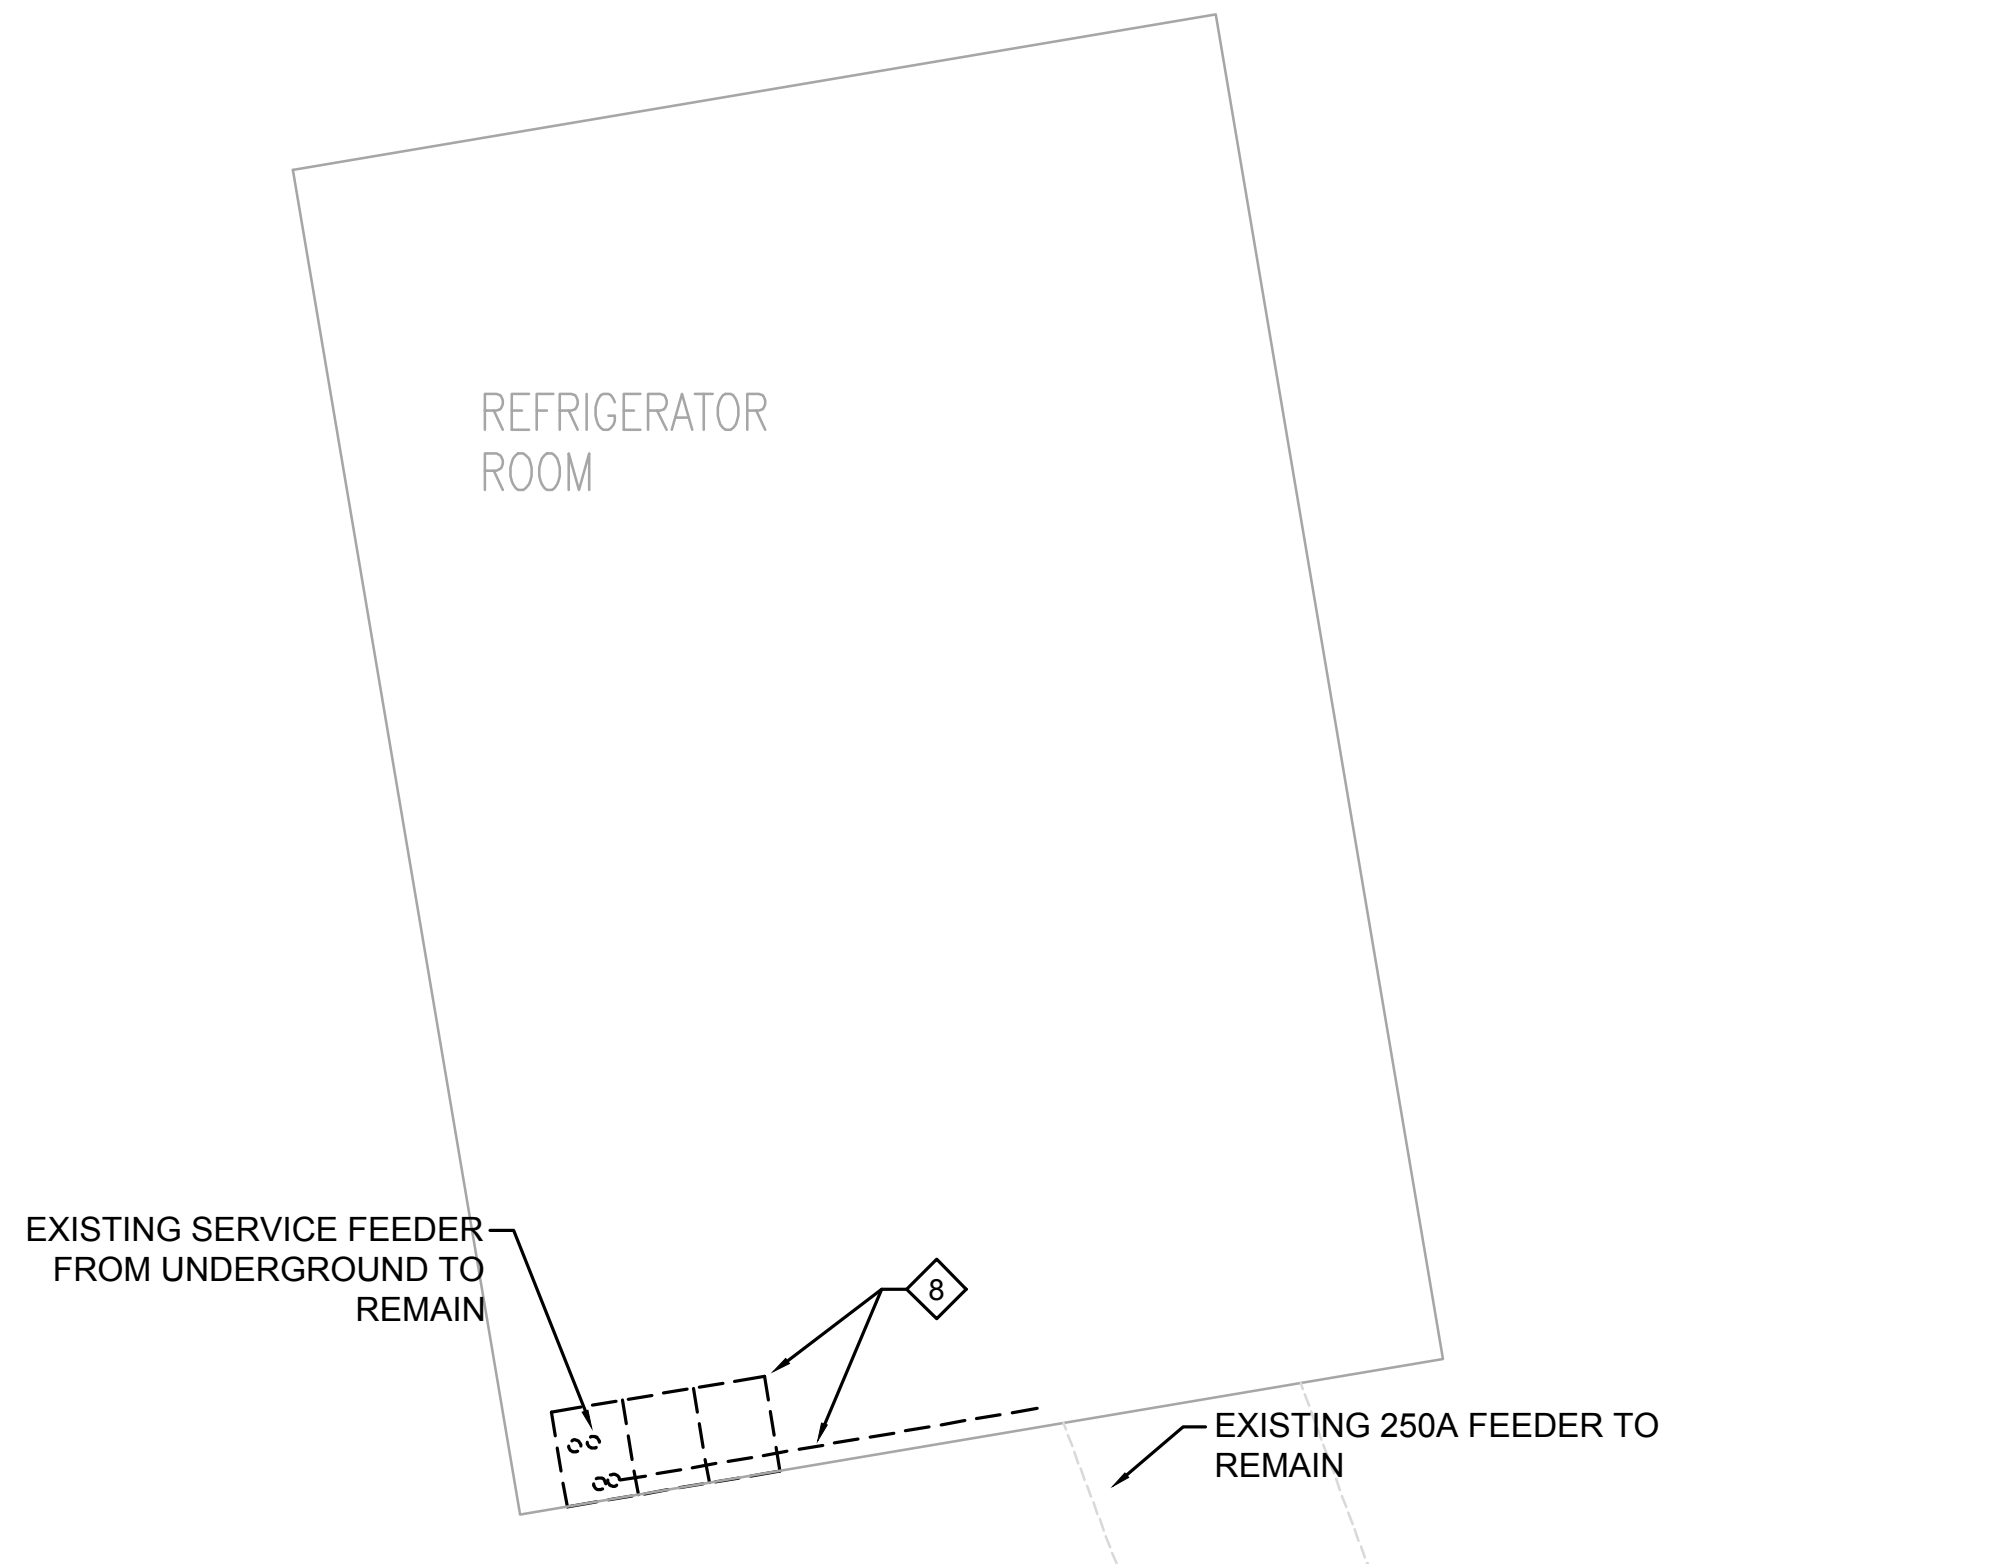MATCHLINE FOR CONTINUATION SEE 2/ED2.1




3 ELECTRICAL SERVICE DEMOLITION PLAN
REFRIGERATOR BUILDING

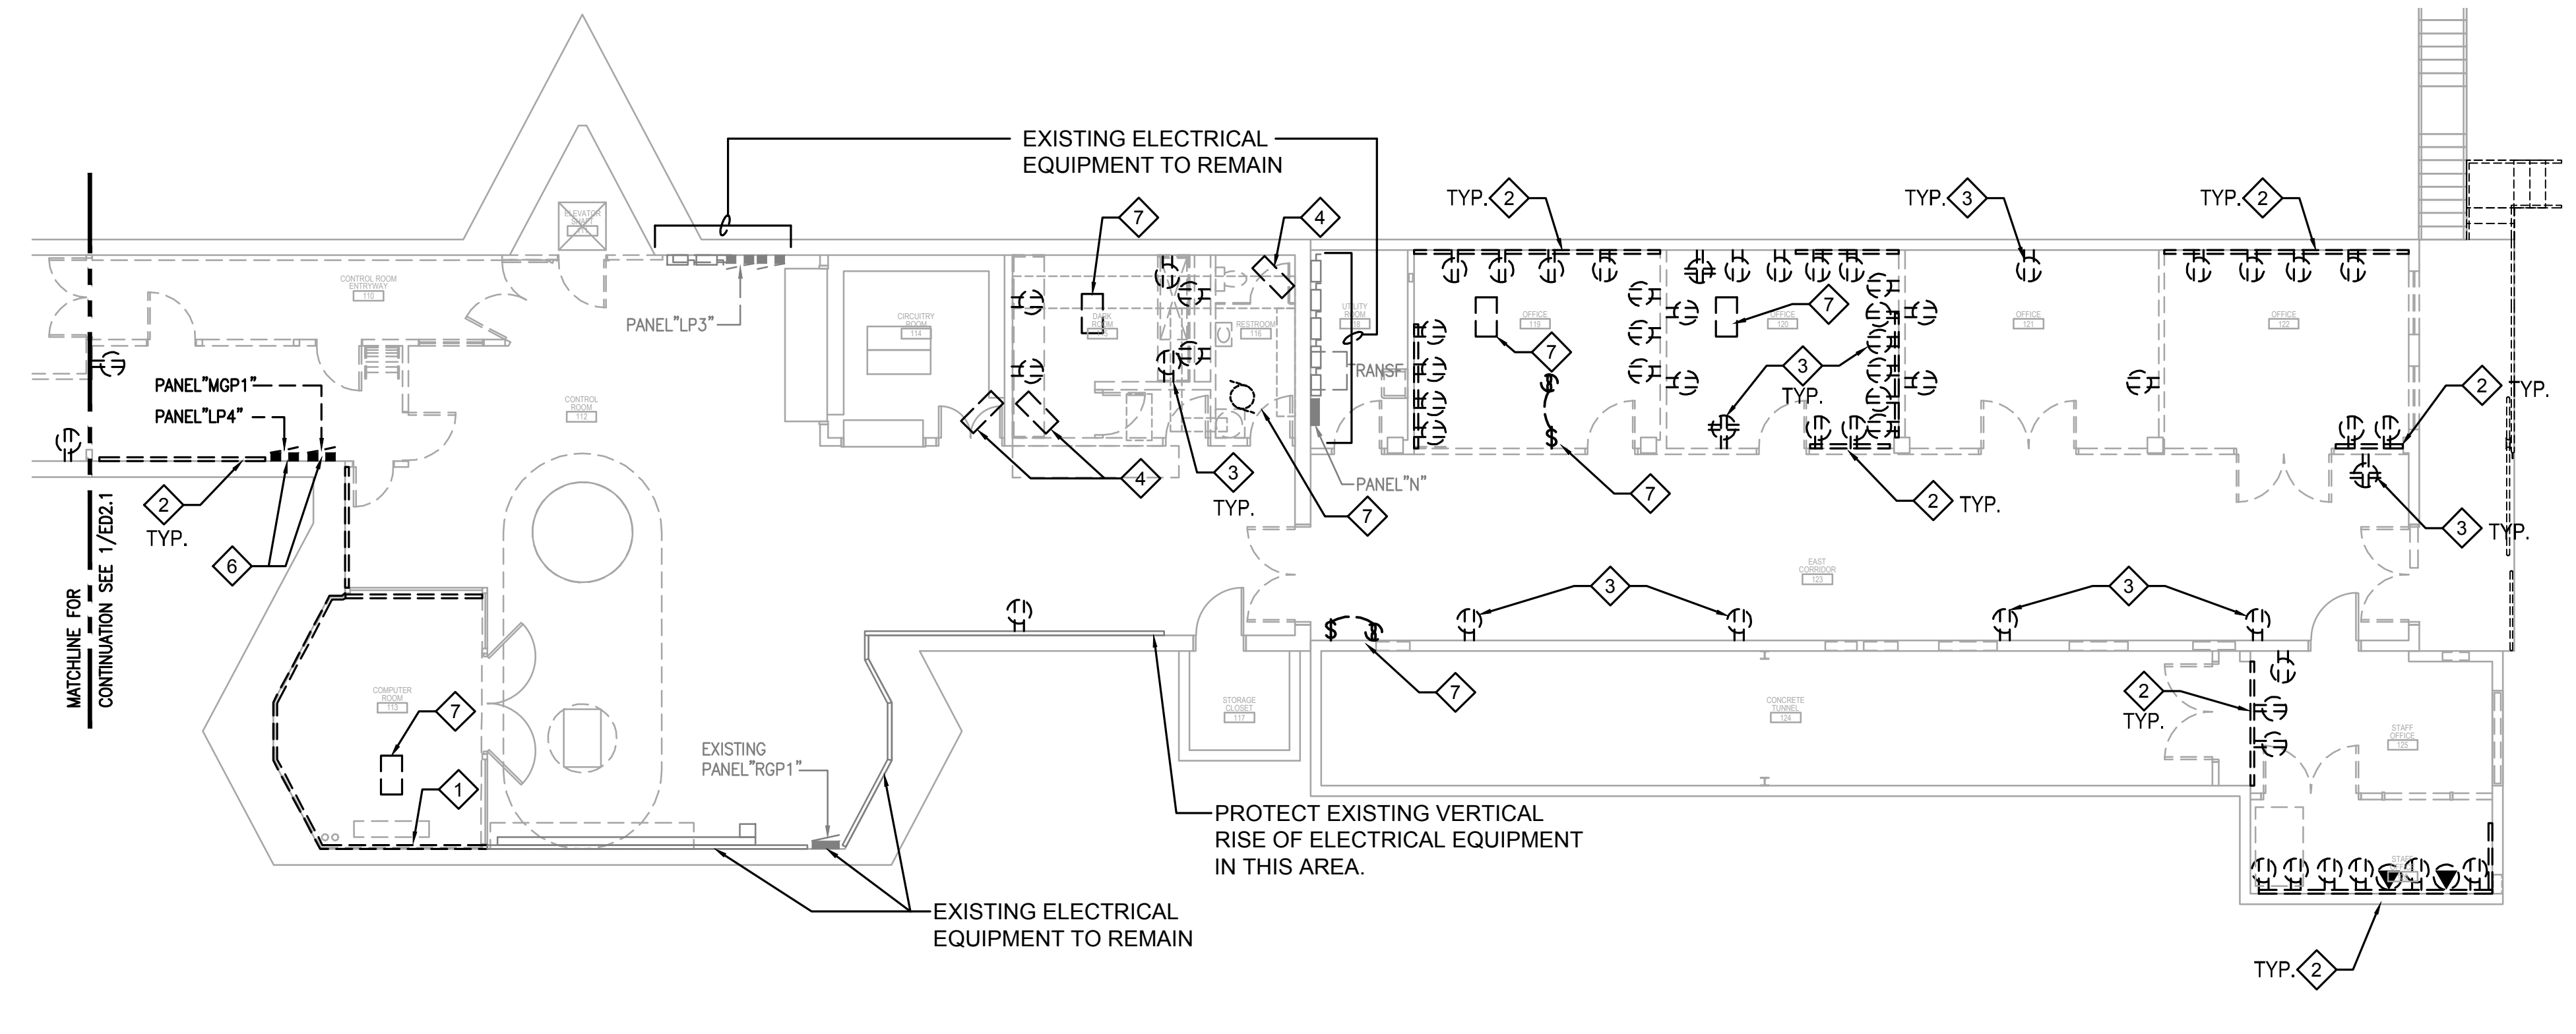SCALE: 1/4"-1'-0"




2 ELECTRICAL POWER DEMOLITION PLAN
1ST LEVEL

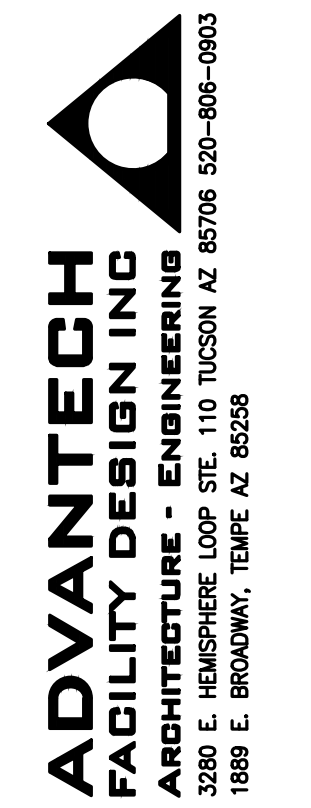SCALE: 1/8"-1'-0"



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OUTREACH

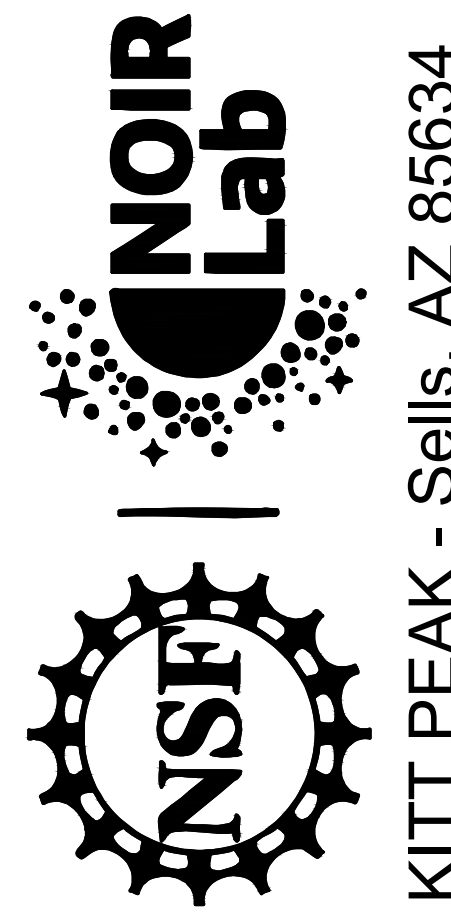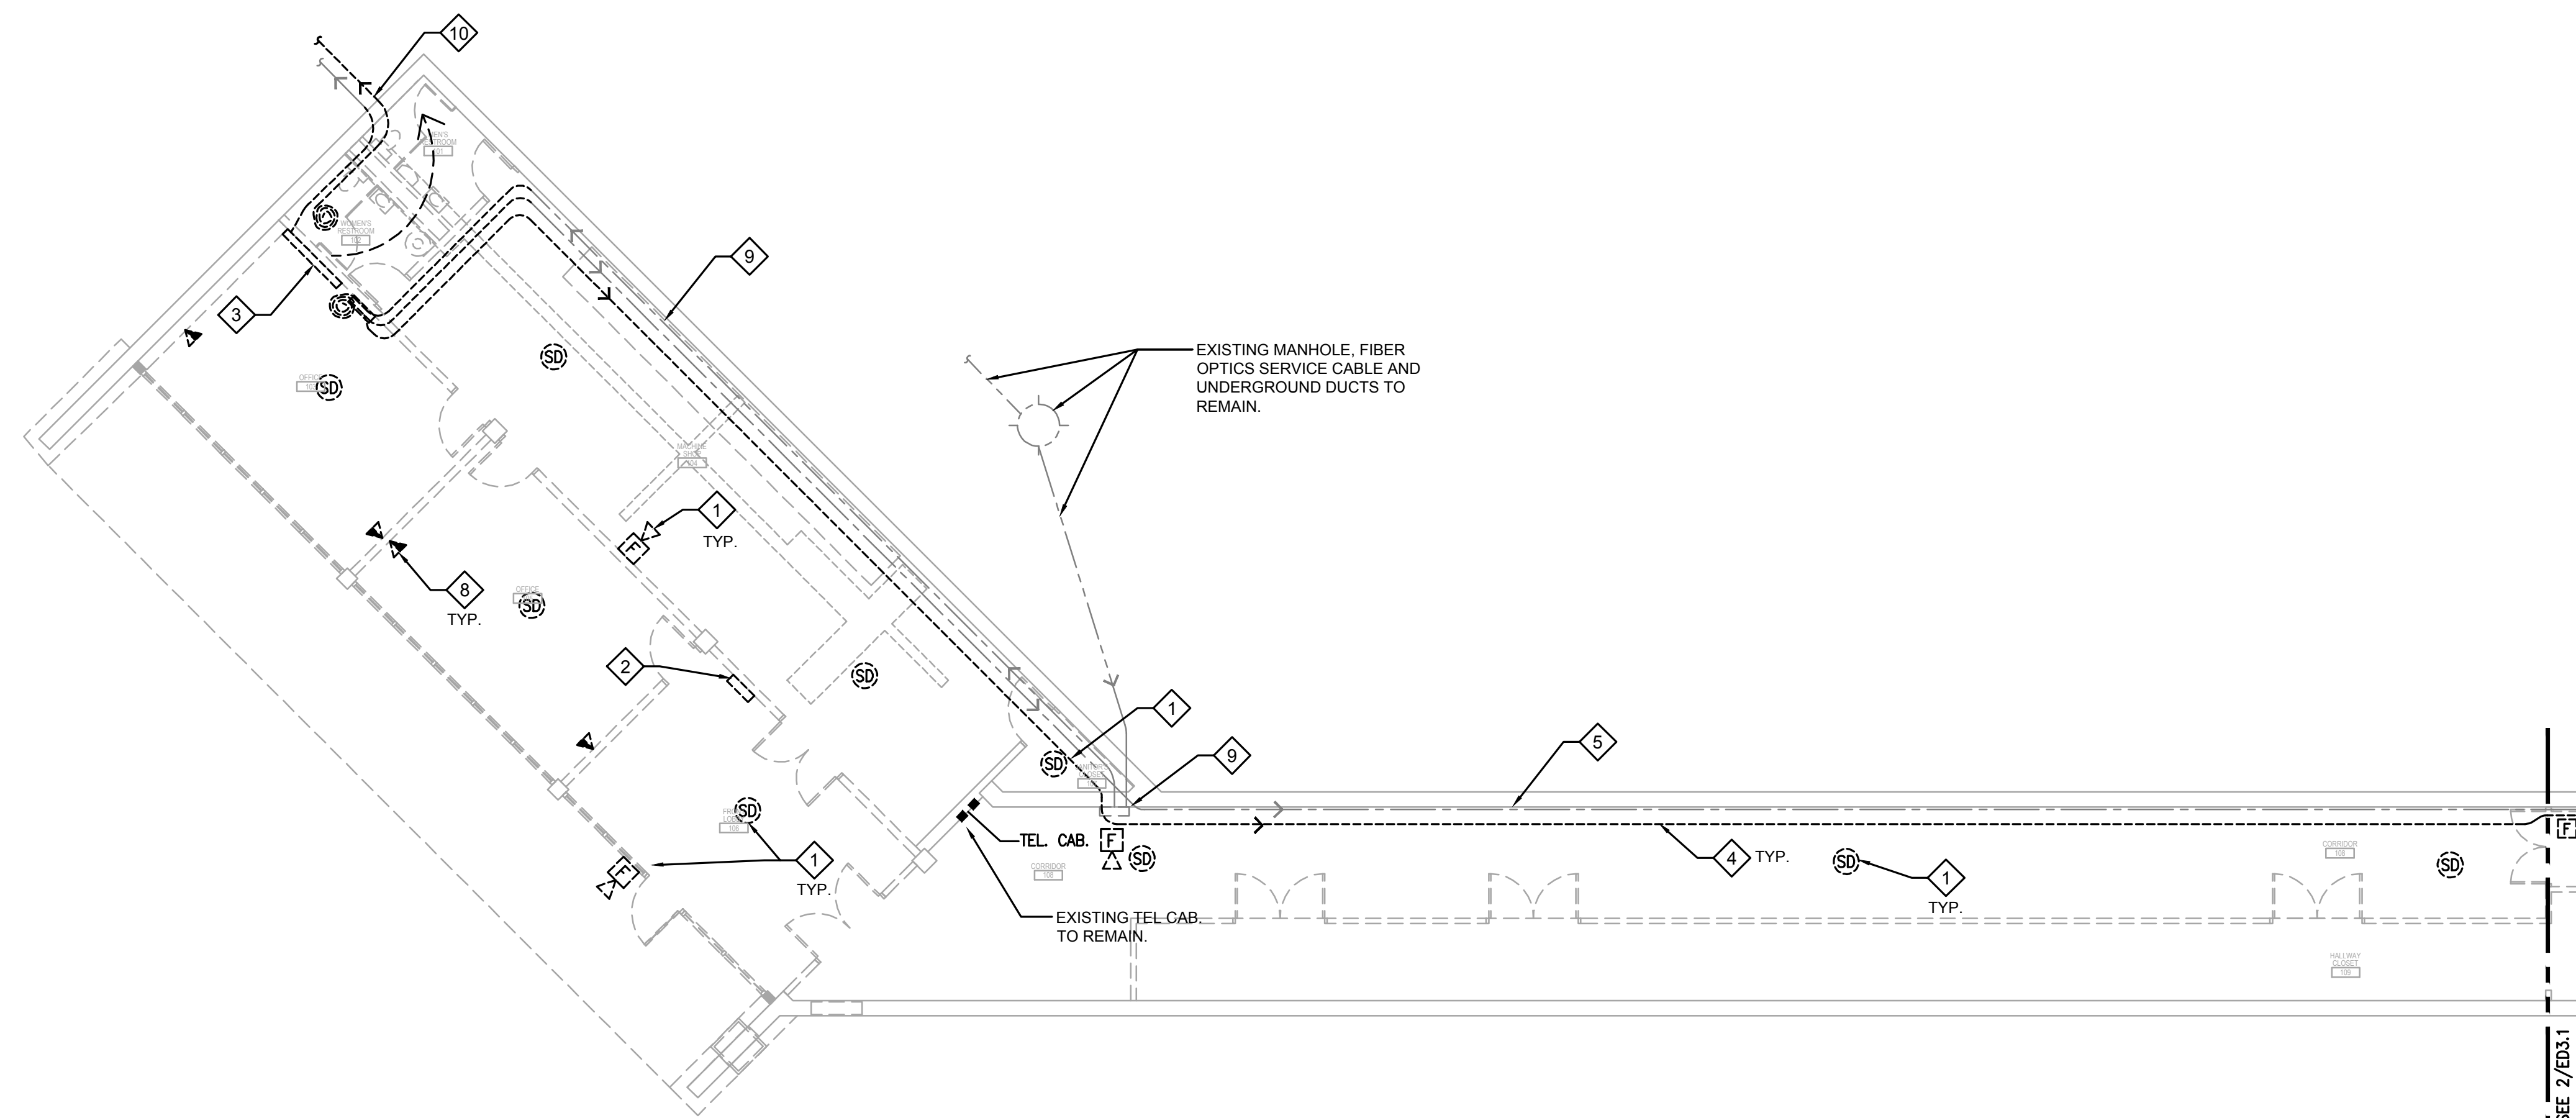


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PROJECT NUMBER: 11904.00
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CAD FILE: 11904.00-ED2.1
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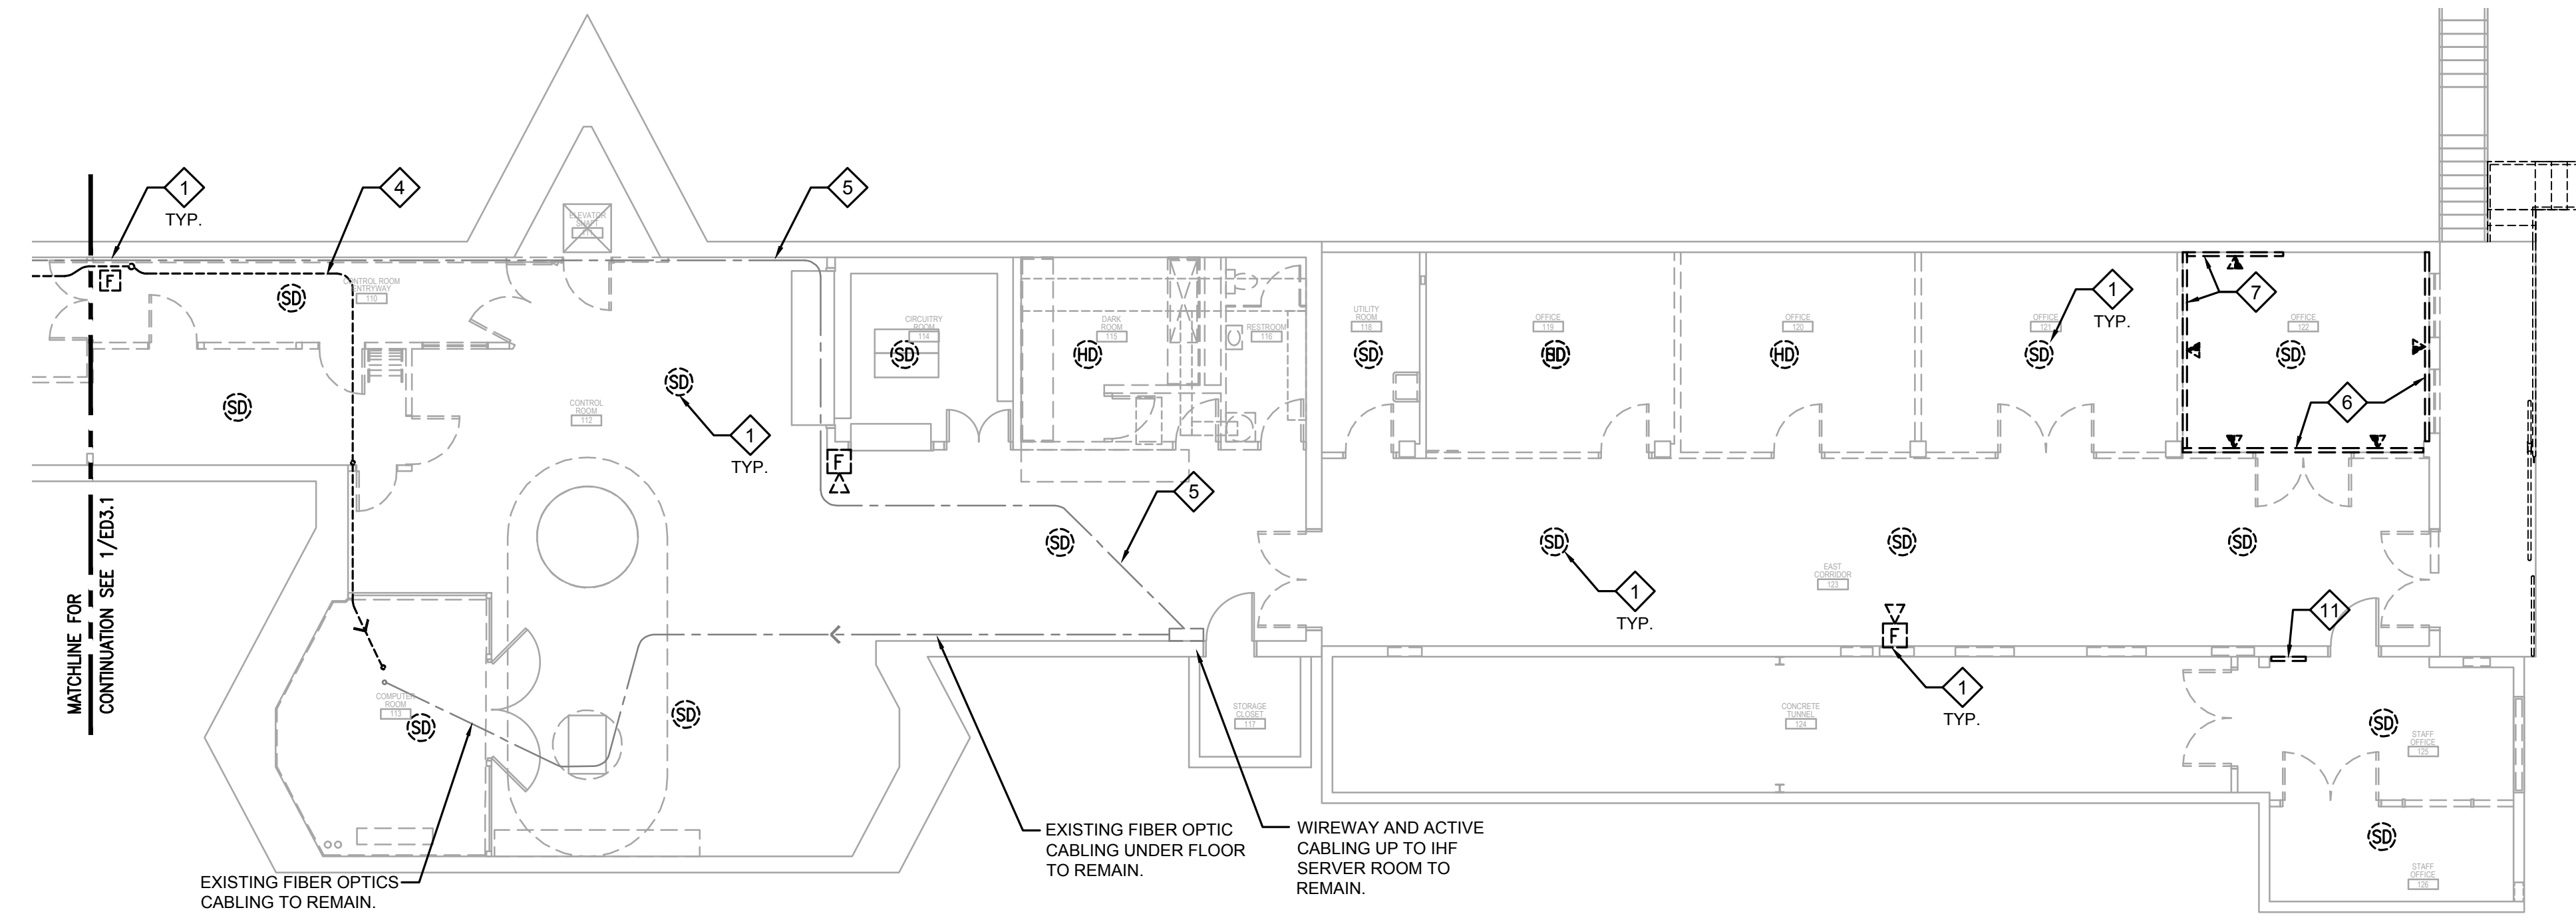
ELECTRICAL
POWER
DEMOLITION PLANS

ED2.1



1 ELECTRICAL SYSTEMS DEMOLITION PLAN
1ST LEVEL

SCALE: 1/8"=1'-0"



2 ELECTRICAL SYSTEMS DEMOLITION PLAN
1ST LEVEL


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GENERAL NOTES:



- A. REFER TO SHEET E0.0 AND THE ENTIRE SET FOR ADDITIONAL INFORMATION AND REQUIREMENTS.
- B. PRIOR TO REMOVAL OF ANY FIBER OPTIC CABLING, CONSULT WITH OWNER TO DETERMINE WHICH CABLES ARE ACTIVE AND REQUIRE SYSTEM SHUT-DOWN IN ORDER TO RELOCATE AND WHICH CABLES ARE NON-OPERATIONAL AND ARE SCHEDULED FOR REMOVAL.
- C. REMOVE ALL UN-USED CABLING AND CONDUIT TO RESULT IN A CLEAN AND PROFESSIONAL APPEARANCE.

KEYNOTES:

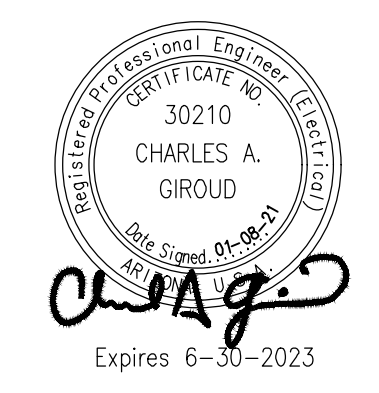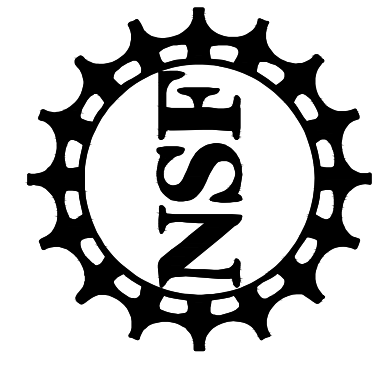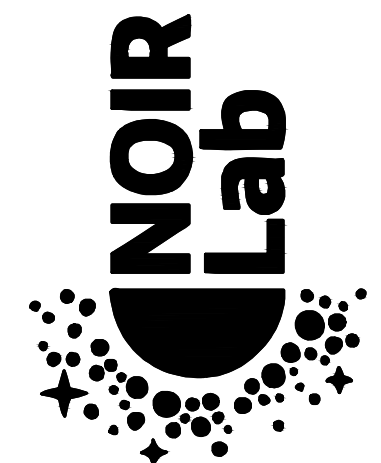- 1. REMOVE FIRE ALARM DEVICE AND ASSOCIATED WIRING/CONDUIT BACK TO SOURCE.
- 2. RELOCATE FIRE ALARM ANNUNCIATOR PANEL TO NEW WALL, EXTEND WIRE/CONDUIT TO NEW LOCATION.
- 3. RELOCATE EXISTING FIBER OPTICS, LIU AND PATCH PANEL AS INDICATED. REDIRECT EXISTING CIRCUITS AND CABLING TO NEW LOCATION. SEE RENOVATION PLAN FOR ADDITIONAL INFORMATION.
- 4. REMOVE NON OPERATIONAL FIBER OPTIC CABLES AND ASSOCIATED CABLING BACK TO SOURCE AND RETAIN CONDUIT FOR RE-USE.
- 5. REMOVE EXPOSED ACTIVE FIBER OPTIC CABLE AND INSTALL IN EXISTING CONDUIT MADE AVAILABLE BY REMOVAL OF EXIST NON OPERATIONAL FIBER OPTIC CABLE.
- 6. REMOVE TEL/DATA WIRE WAY LOCATED HIGH ON WALL AND ASSOCIATED CABLING BACK TO SOURCE.
- 7. REMOVE TEL/DATA WIRE WAY LOCATED LOW ON WALL AND ASSOCIATED CABLING BACK TO SOURCE.
- 8. REMOVE TEL/DATA COMMUNICATIONS DEVICE AND CABLING BACK TO SOURCE.
- 9. RELOCATE TEL/DATA SPLICE BOX IN SAME GENERAL LOCATION AT MAXIMUM HEIGHT. RETAIN INCOMING AND OUTGOING FIBER OPTIC CABLE CONNECTIONS. SUPPORT IN PULL BOX AS INDICATED ON RENOVATION PLANS.
- 10. REMOVE DEAD FIBER OPTIC CABLE COIL BACK TO SOURCE.
- 11. REMOVE EXISTING TEL BOARD AND ASSOCIATED CABLING AND EQUIPMENT.



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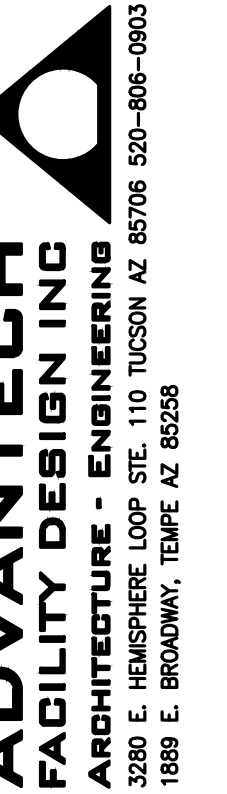
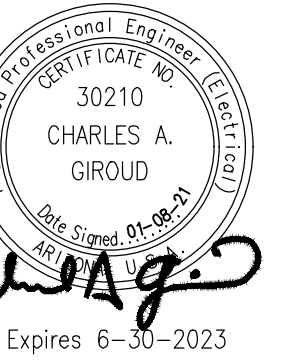
KITT PEAK - Sells, AZ 85634

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0	01/08/21	I.F.C.


PROJECT NUMBER: 11904.00
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ELECTRICAL
SYSTEMS
DEMOLITION PLANS

ED3.1



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SCALE: AS SHOWN

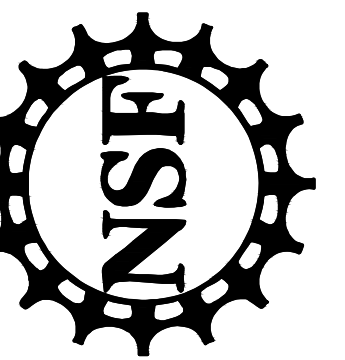ELECTRICAL
LIGHTING
RENOVATION PLANS


E1.1

GENERAL NOTES:

- A. REFER TO SHEET E0.0 AND ENTIRE SET FOR ADDITIONAL INFORMATION AND REQUIREMENTS.
- B. SMART TRACK IS TO BE MOUNTED 1'-0" BELOW CEILINGS EXCEPT WHERE HVAC DUCT IS IN CONFLICT, THE TRACKS SHALL BE INSTALLED 6" BELOW THE DUCT WORK UNLESS NOTED OTHERWISE.
- C. ALL LIGHTING CONTROLS SHALL BE LOW VOLTAGE USING POWER PACKS AS THE LINE VOLTAGE RELAY INTERFACE AND DIMMING CONTROL POINT.


KEYNOTES:

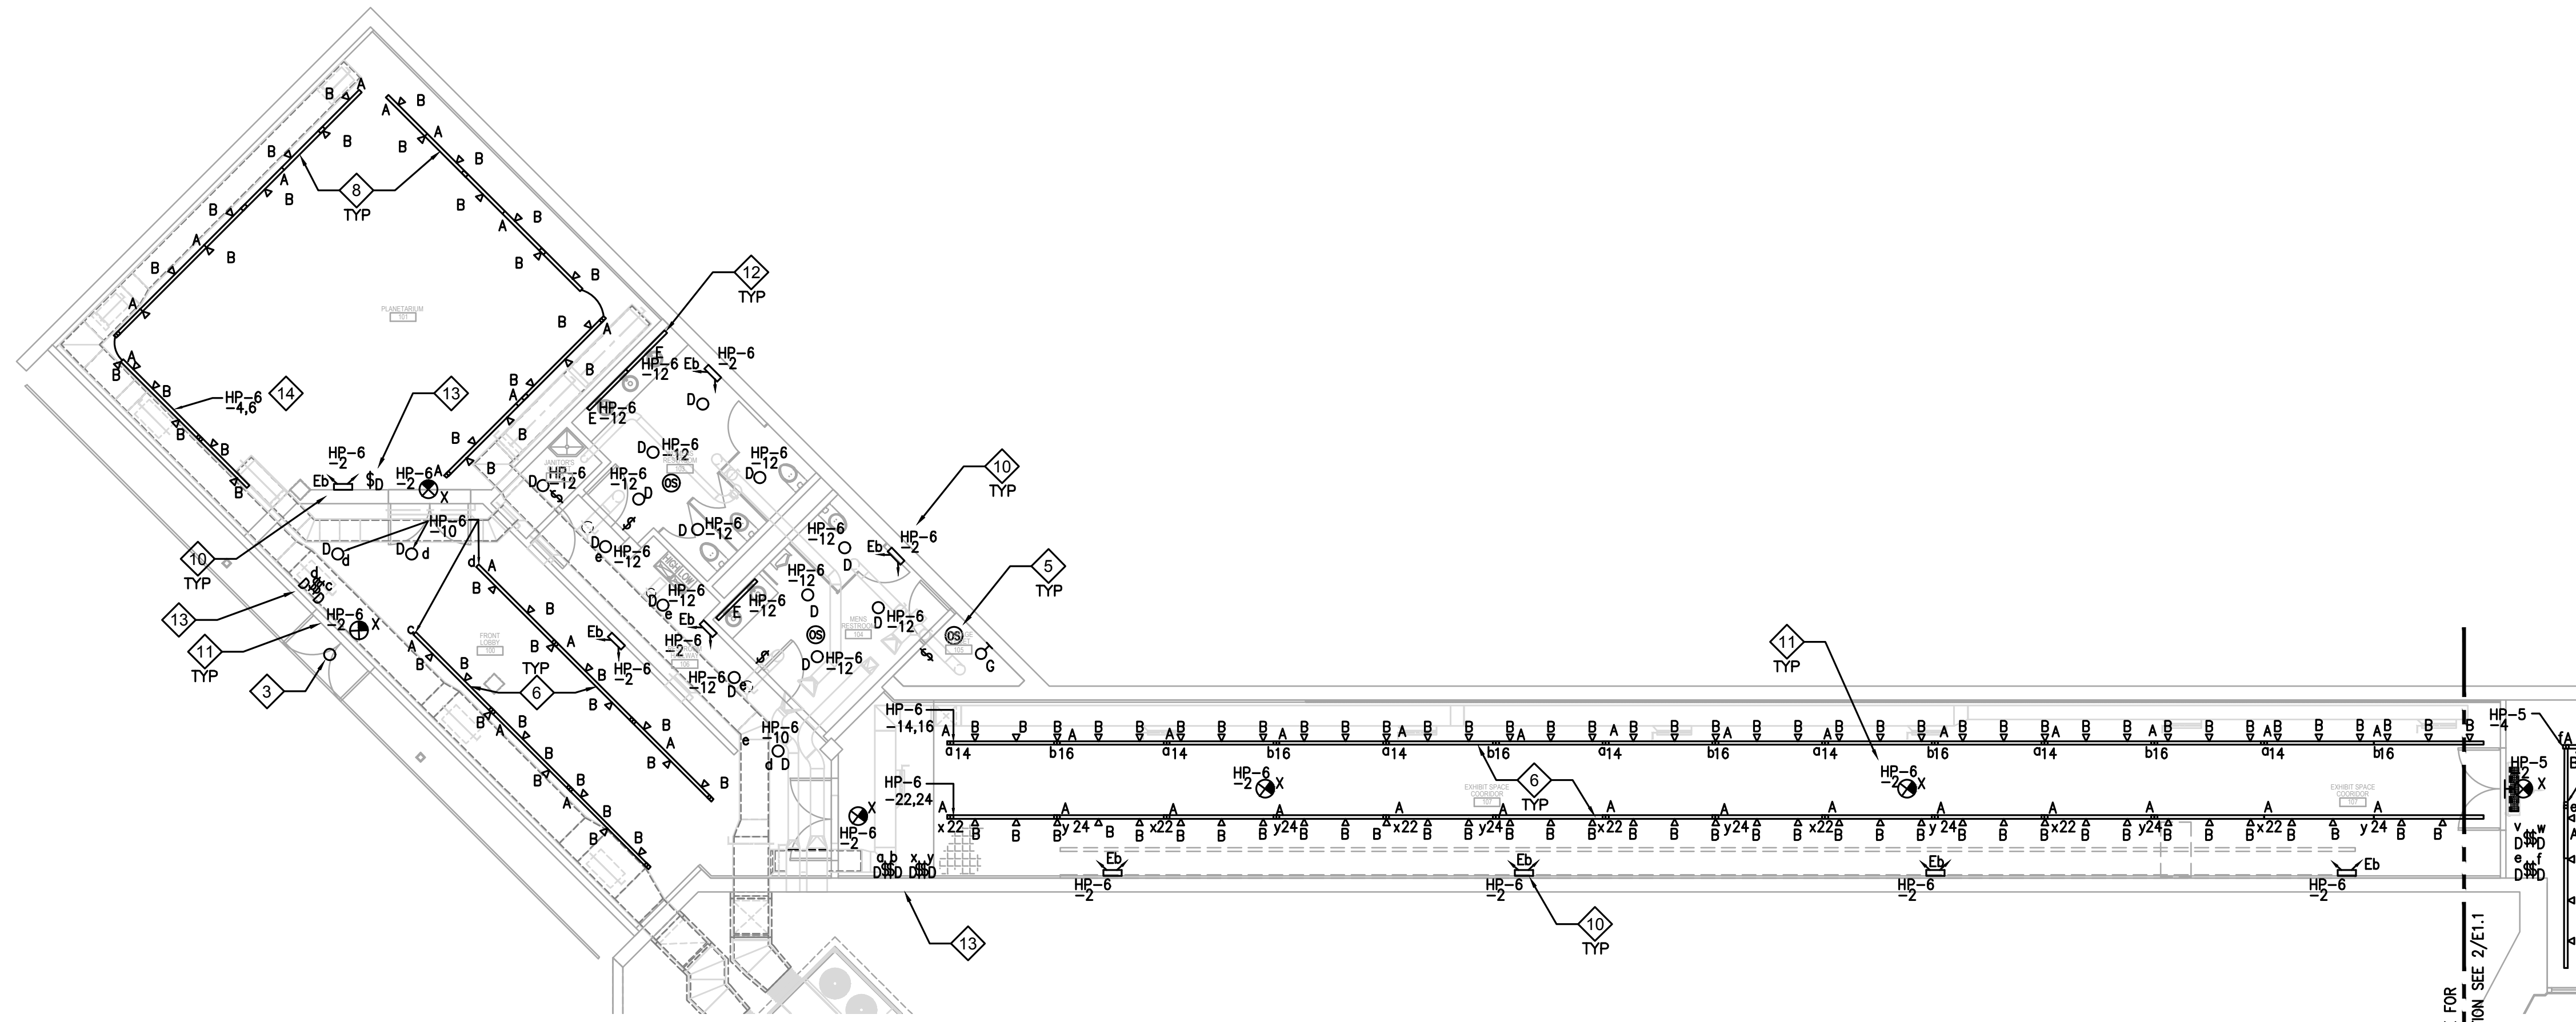- 1. PROVIDE WP J-BOX BELOW FLOOR IN TUNNEL. RUN 1" C TO WALL AND THEN THROUGH FLOOR UP TO SWITCH FOR FUTURE BELOW FLOOR LIGHTS. VERIFY EXACT LOCATION WITH OWNER.
- 2. PROVIDE SWITCH FOR BELOW FLOOR LIGHTS. RUN 1" C STUB INTO ELECTRICAL ROOM FOR FUTURE CIRCUITING OF BELOW FLOOR LIGHTS. VERIFY EXACT LOCATIONS WITH OWNER.
- 3. INSTALL RELOCATED RECESSED CAN LIGHT FROM DEMOLITION. CLEAN RE-LAMP AND LIGHTING CONTROL.
- 4. PROVIDE NEW FIXTURES AS SHOWN. RECONNECT TO EXISTING CIRCUIT AND LIGHTING CONTROL.
- 5. PROVIDE LOW VOLTAGE OCCUPANCY SENSOR WITH INTERFACE TO LOCAL POWER PACK.
- 6. PROVIDE SMART TRACK MOUNTED BELOW HVAC DUCT WORK AVOIDING CONFLICTS WITH MECHANICAL INSTALLATIONS.
- 7. PROVIDE INSTALLATION OF SMART TRACK, AND COORDINATION WITH SOS THEATER EQUIPMENT INSTALLATION.
- 8. PROVIDE INSTALLATION OF SMART TRACK, AND COORDINATION WITH PLANETARIUM EQUIPMENT INSTALLATION.
- 9. PROVIDE WALL WASHER LIGHT, INSTALL ABOVE VIEWING WINDOW FOR LIGHT-WELL AFFECT IN ELEVATOR SHAFT.
- 10. INSTALL EM BATTERY PACK LIGHTS AT 8'-0" AFF. CONNECT TO NON-SWITCHED PORTION OF LOCAL LIGHTING CKT.
- 11. PROVIDE BATTERY BACKED EXIT LIGHTS. CONNECT TO NON-SWITCHED PORTION OF LOCAL LIGHTING CKT.
- 12. INSTALL LIGHTS ABOVE MIRROR.
- 13. PROVIDE DIMMING SWITCH FOR EACH CONTROL GROUPS LISTED, IF NO GROUP IS LISTED, PROVIDE A COMMON DIMMING SWITCH FOR THE ENTIRE ROOM.
- 14. ALTERNATELY CIRCUIT EACH 8' L TRACK SECTION, CONTROL WITH A COMMON DIMMER SWITCH.



1 ELECTRICAL LIGHTING RENOVATION PLAN
1ST LEVEL

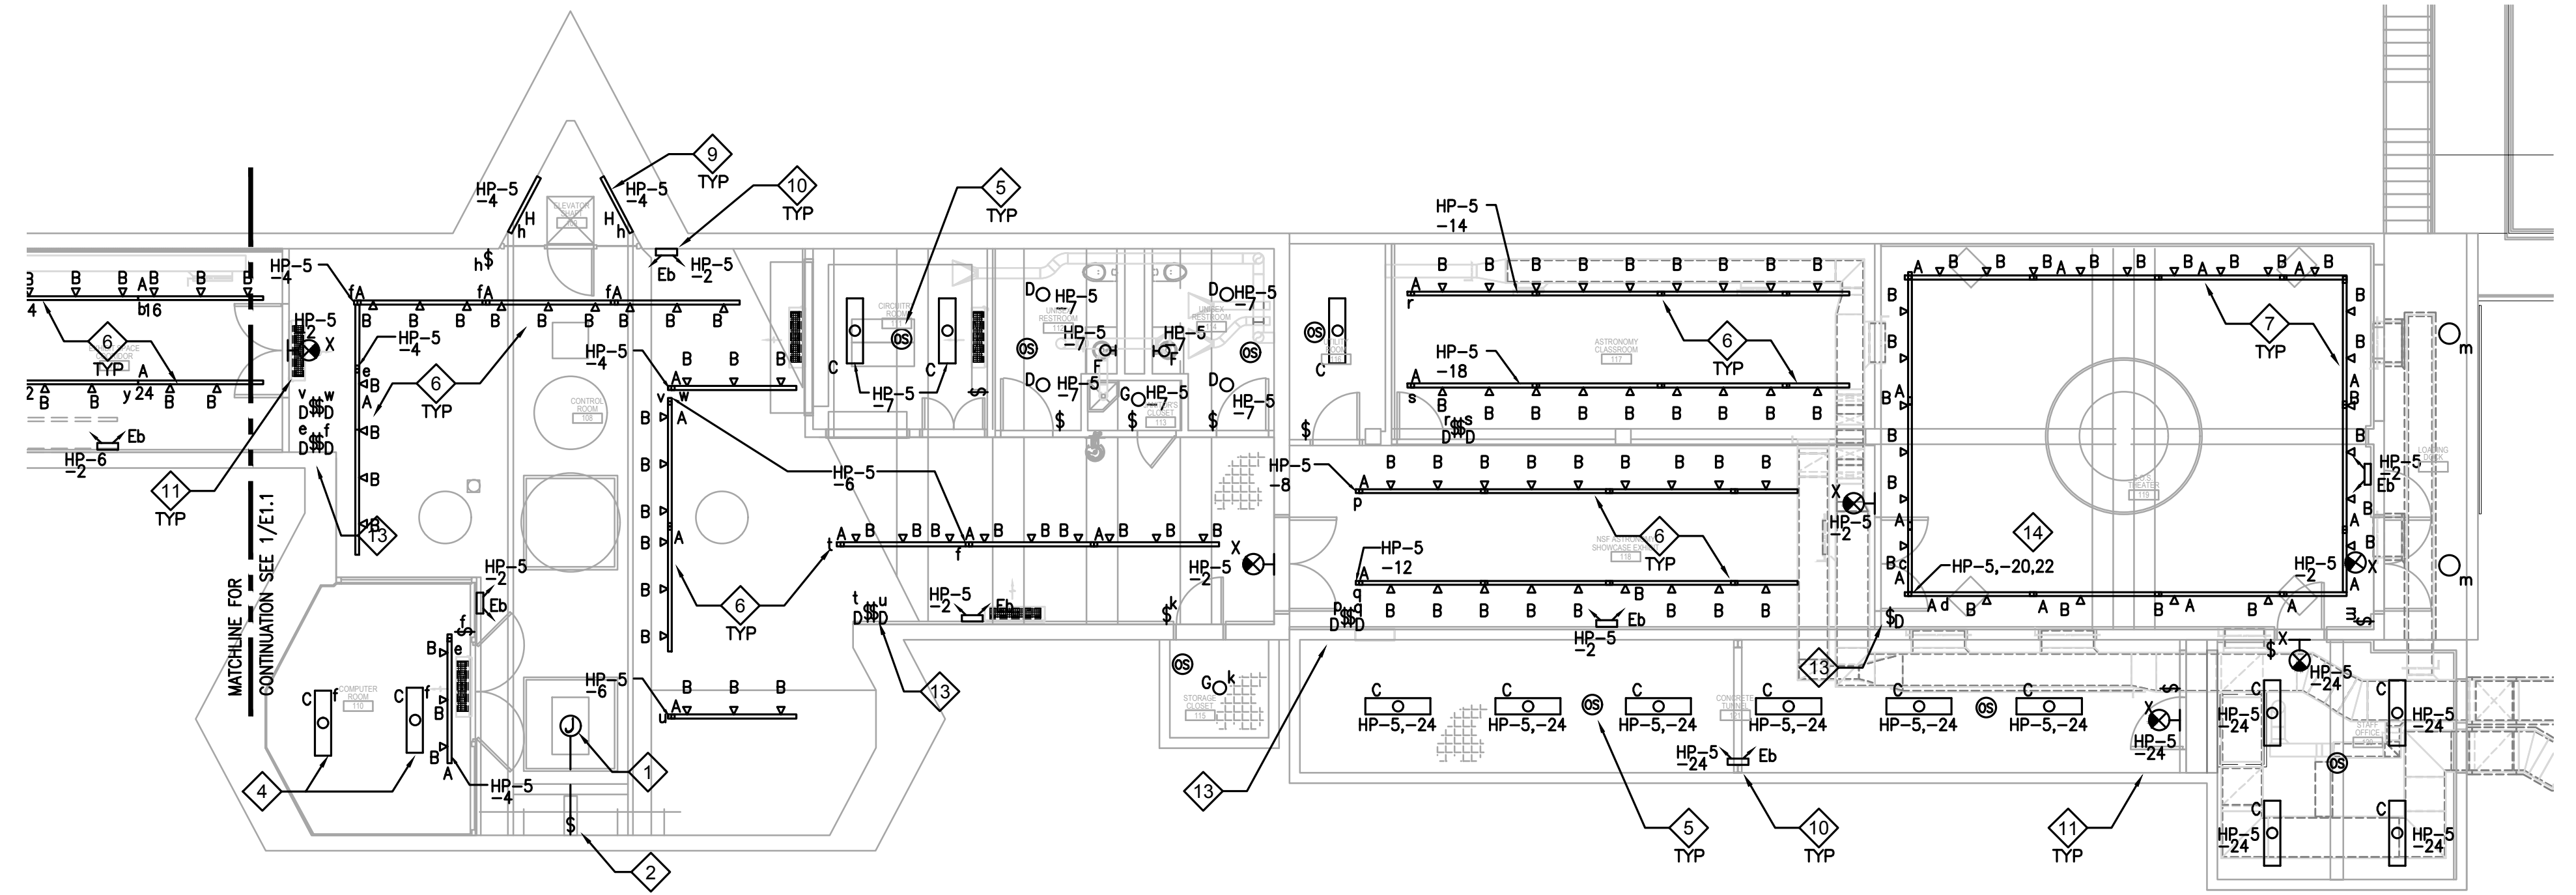SCALE: 1/8"=1'-0"



2 ELECTRICAL LIGHTING RENOVATION PLAN
1ST LEVEL

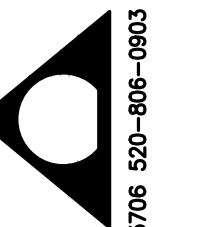
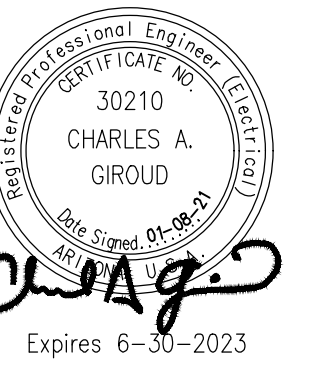
SCALE: 1/8"=1'-0"

GENERAL NOTES:

REFER TO SHEET E0.0 AND THE ENTIRE SET FOR ADDITIONAL INFORMATION AND REQUIREMENTS

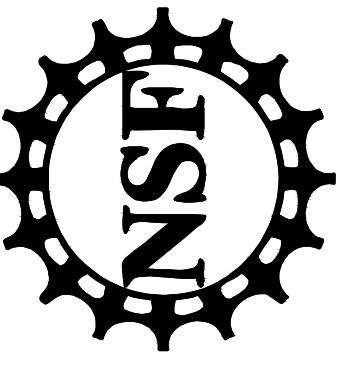
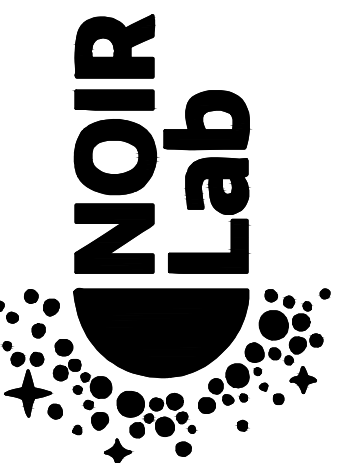
KEYNOTES:

1. PROVIDE NEW PULL BOX, WIREWAY AND EQUIPMENT FOR NEW SERVICE. SEE SHEET E7.0 FOR DETAILS.
2. NEW 400A FEEDER, SEE SHEET E0.1 AND E7.0 FOR DETAILS.
3. RECONNECT EXISTING 250A FEEDER TO NEW DISC. SW. AND PROVIDE NEW DISC. SW. FOR NEW 400A FEEDER.
4. INSTALL NEW XFMR ON U-CHANNEL FRAME (PAD).
5. NEW 480V PANEL UNDER ALTERNATE BID, SEE SHEET E7.0.
6. PROVIDE G4000 WIREMOLD AND RECEPTACLES AS SHOWN AT 48" AFF.
7. PROVIDE NEW RECEPTS AS INDICATED.
8. SAWCUT FLOOR AND PROVIDE FLUSH FLOOR BOX WITH DEVICES INDICATED. PATCH AND REPAIR FLOOR SURFACE. INCLUDE (1) 3/4" C FOR POWER, AND (1) 1" C FOR FUTURE DATA. CONCEAL CONDUIT RISERS IN WALL TO CLG. SPACE.
9. SUPPORT XFMR FROM CLG. STRUCTURE AT 8'0" TO BOTTOM USING U-CHANNEL FRAME AND THREADED RODS.
10. INSTALL XFMR ON U-CHANNEL FRAME (PAD).



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WINDOWS ON
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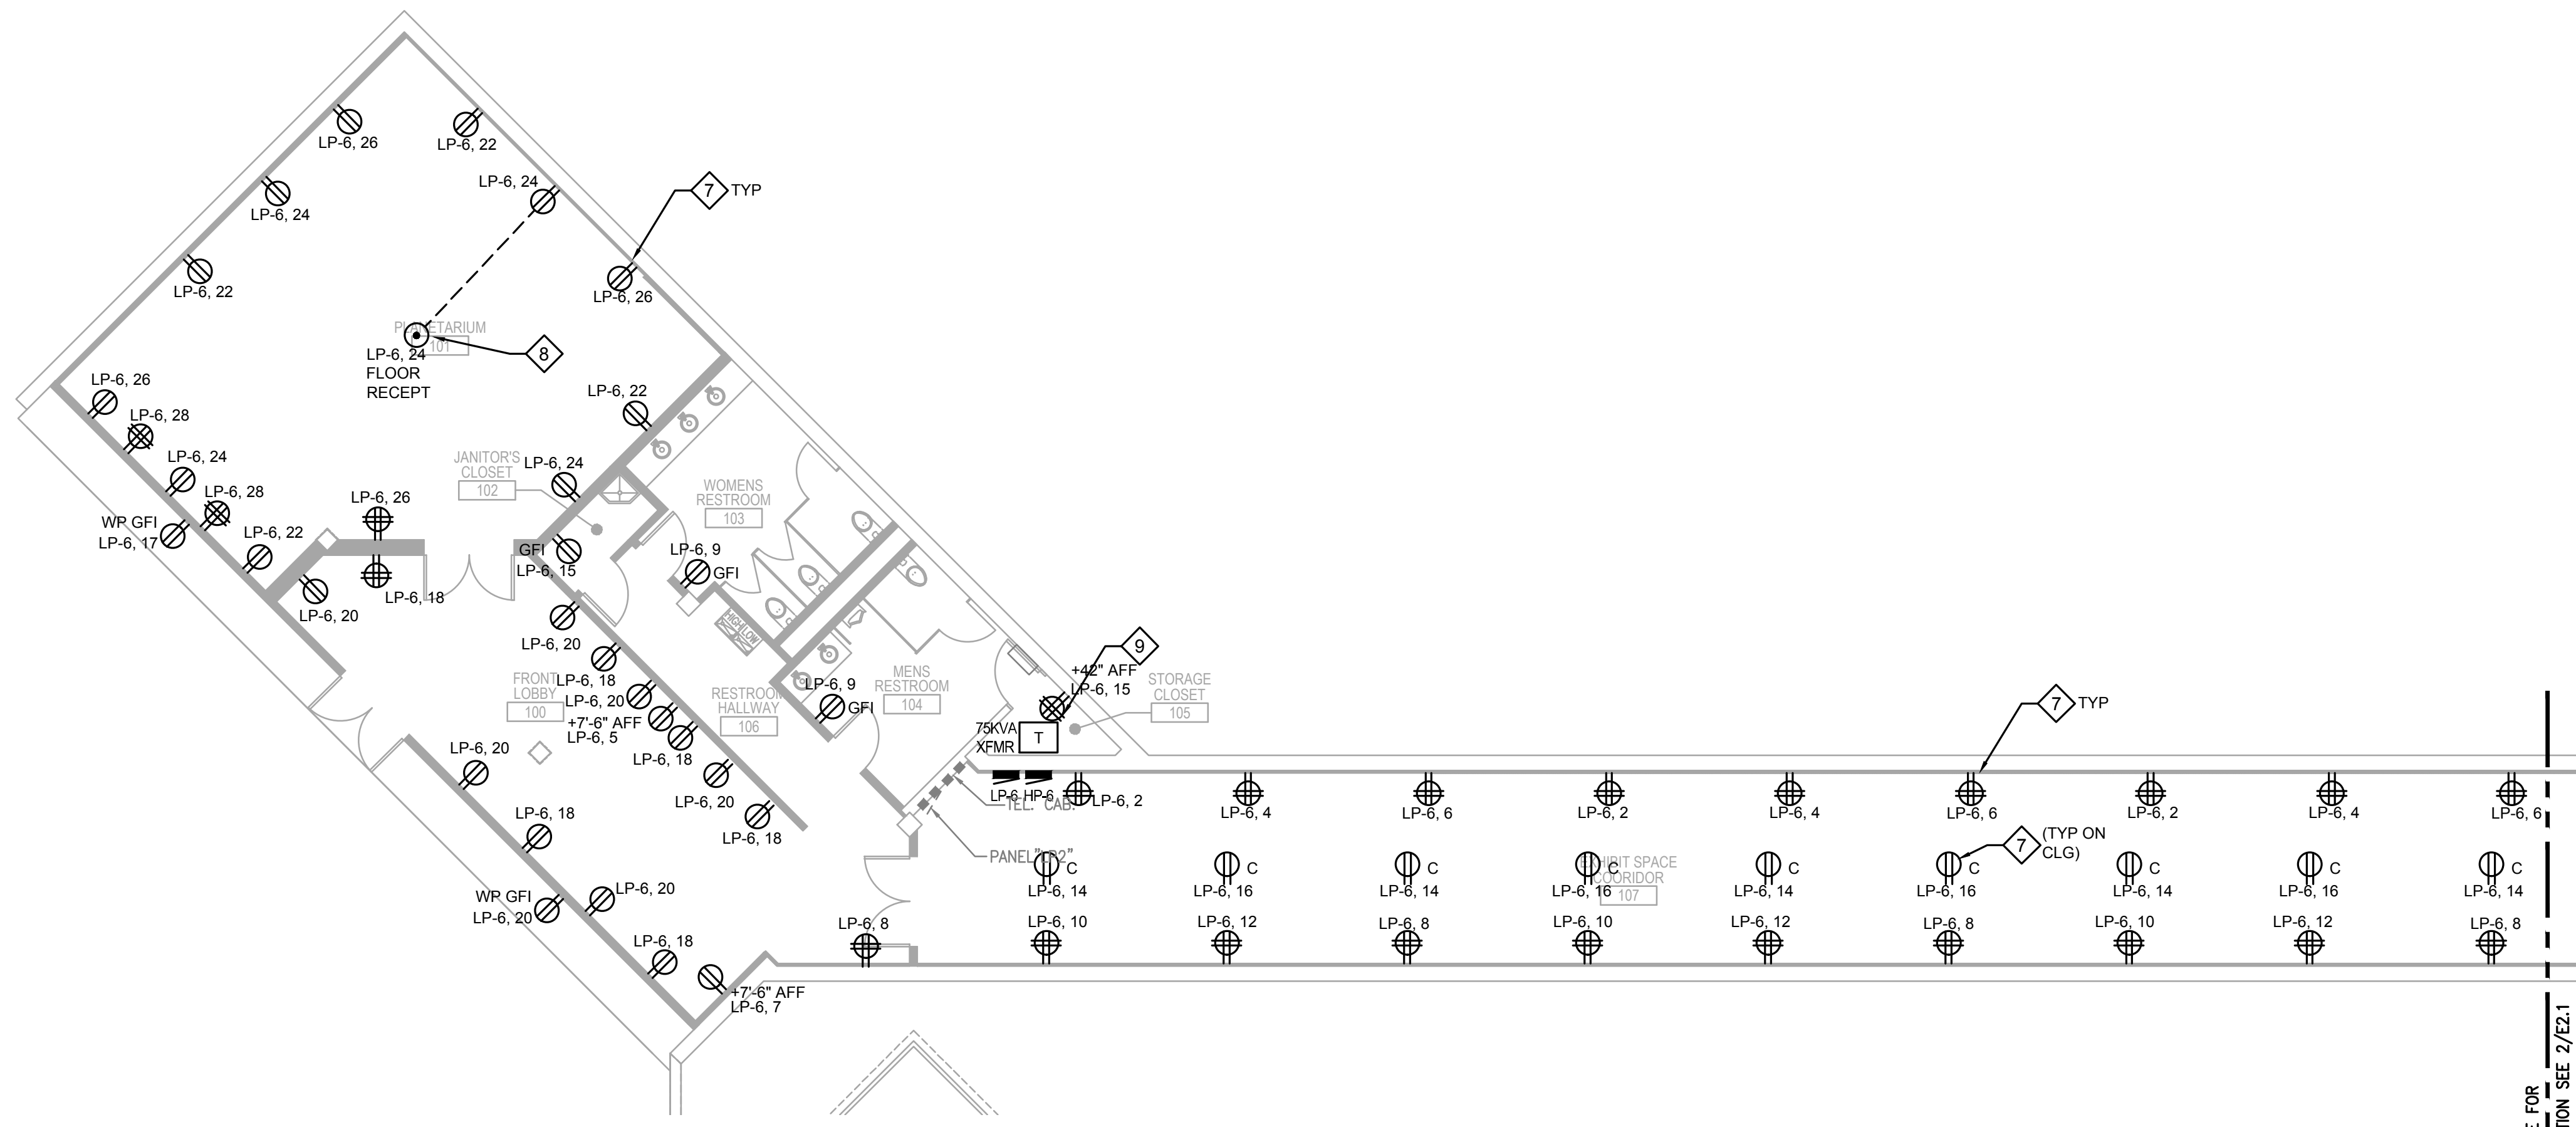
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△	DATE	DESCRIPTION
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PROJECT NUMBER: 11904.00
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CHECKED BY: CG
CAD FILE: 11904.00-E2.1
SCALE: AS SHOWN


ELECTRICAL
POWER
RENOVATION PLANS

E2.1



1 ELECTRICAL POWER RENOVATION PLAN
1ST LEVEL

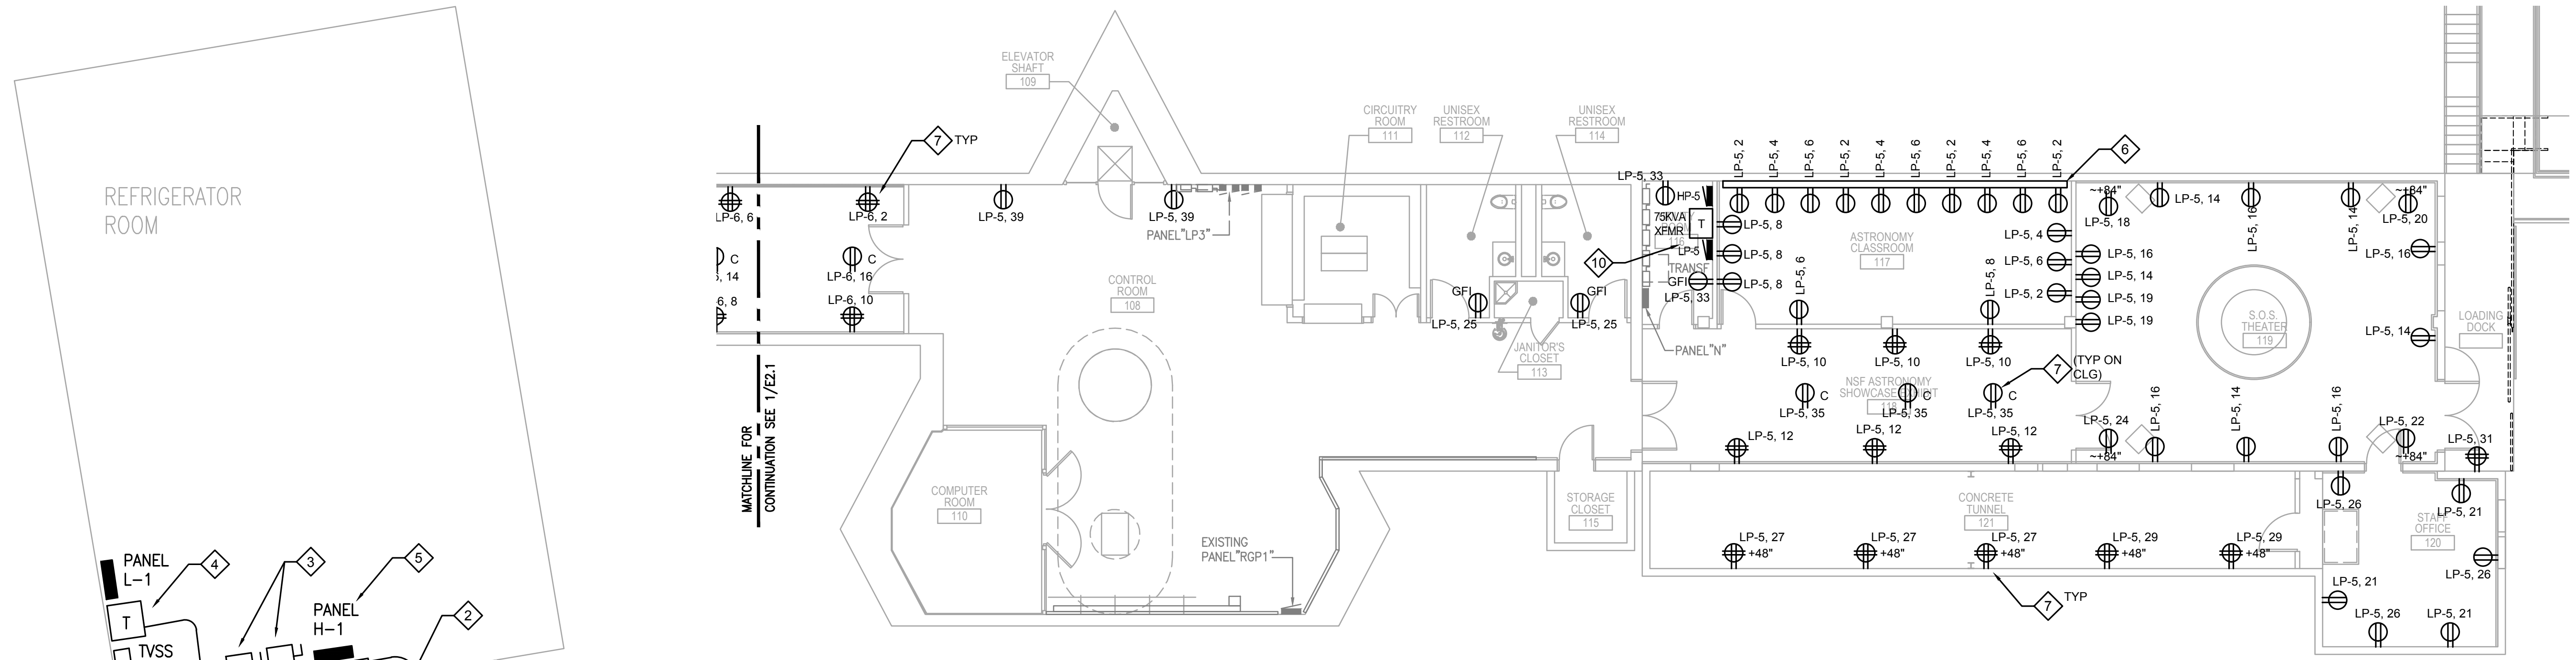SCALE: 1/8"=1'-0"




3 ELECTRICAL SERVICE RENOVATION PLAN
REFRIGERATOR BUILDING

SCALE: 1/4"=1'-0"


2 ELECTRICAL POWER RENOVATION PLAN
1ST LEVEL

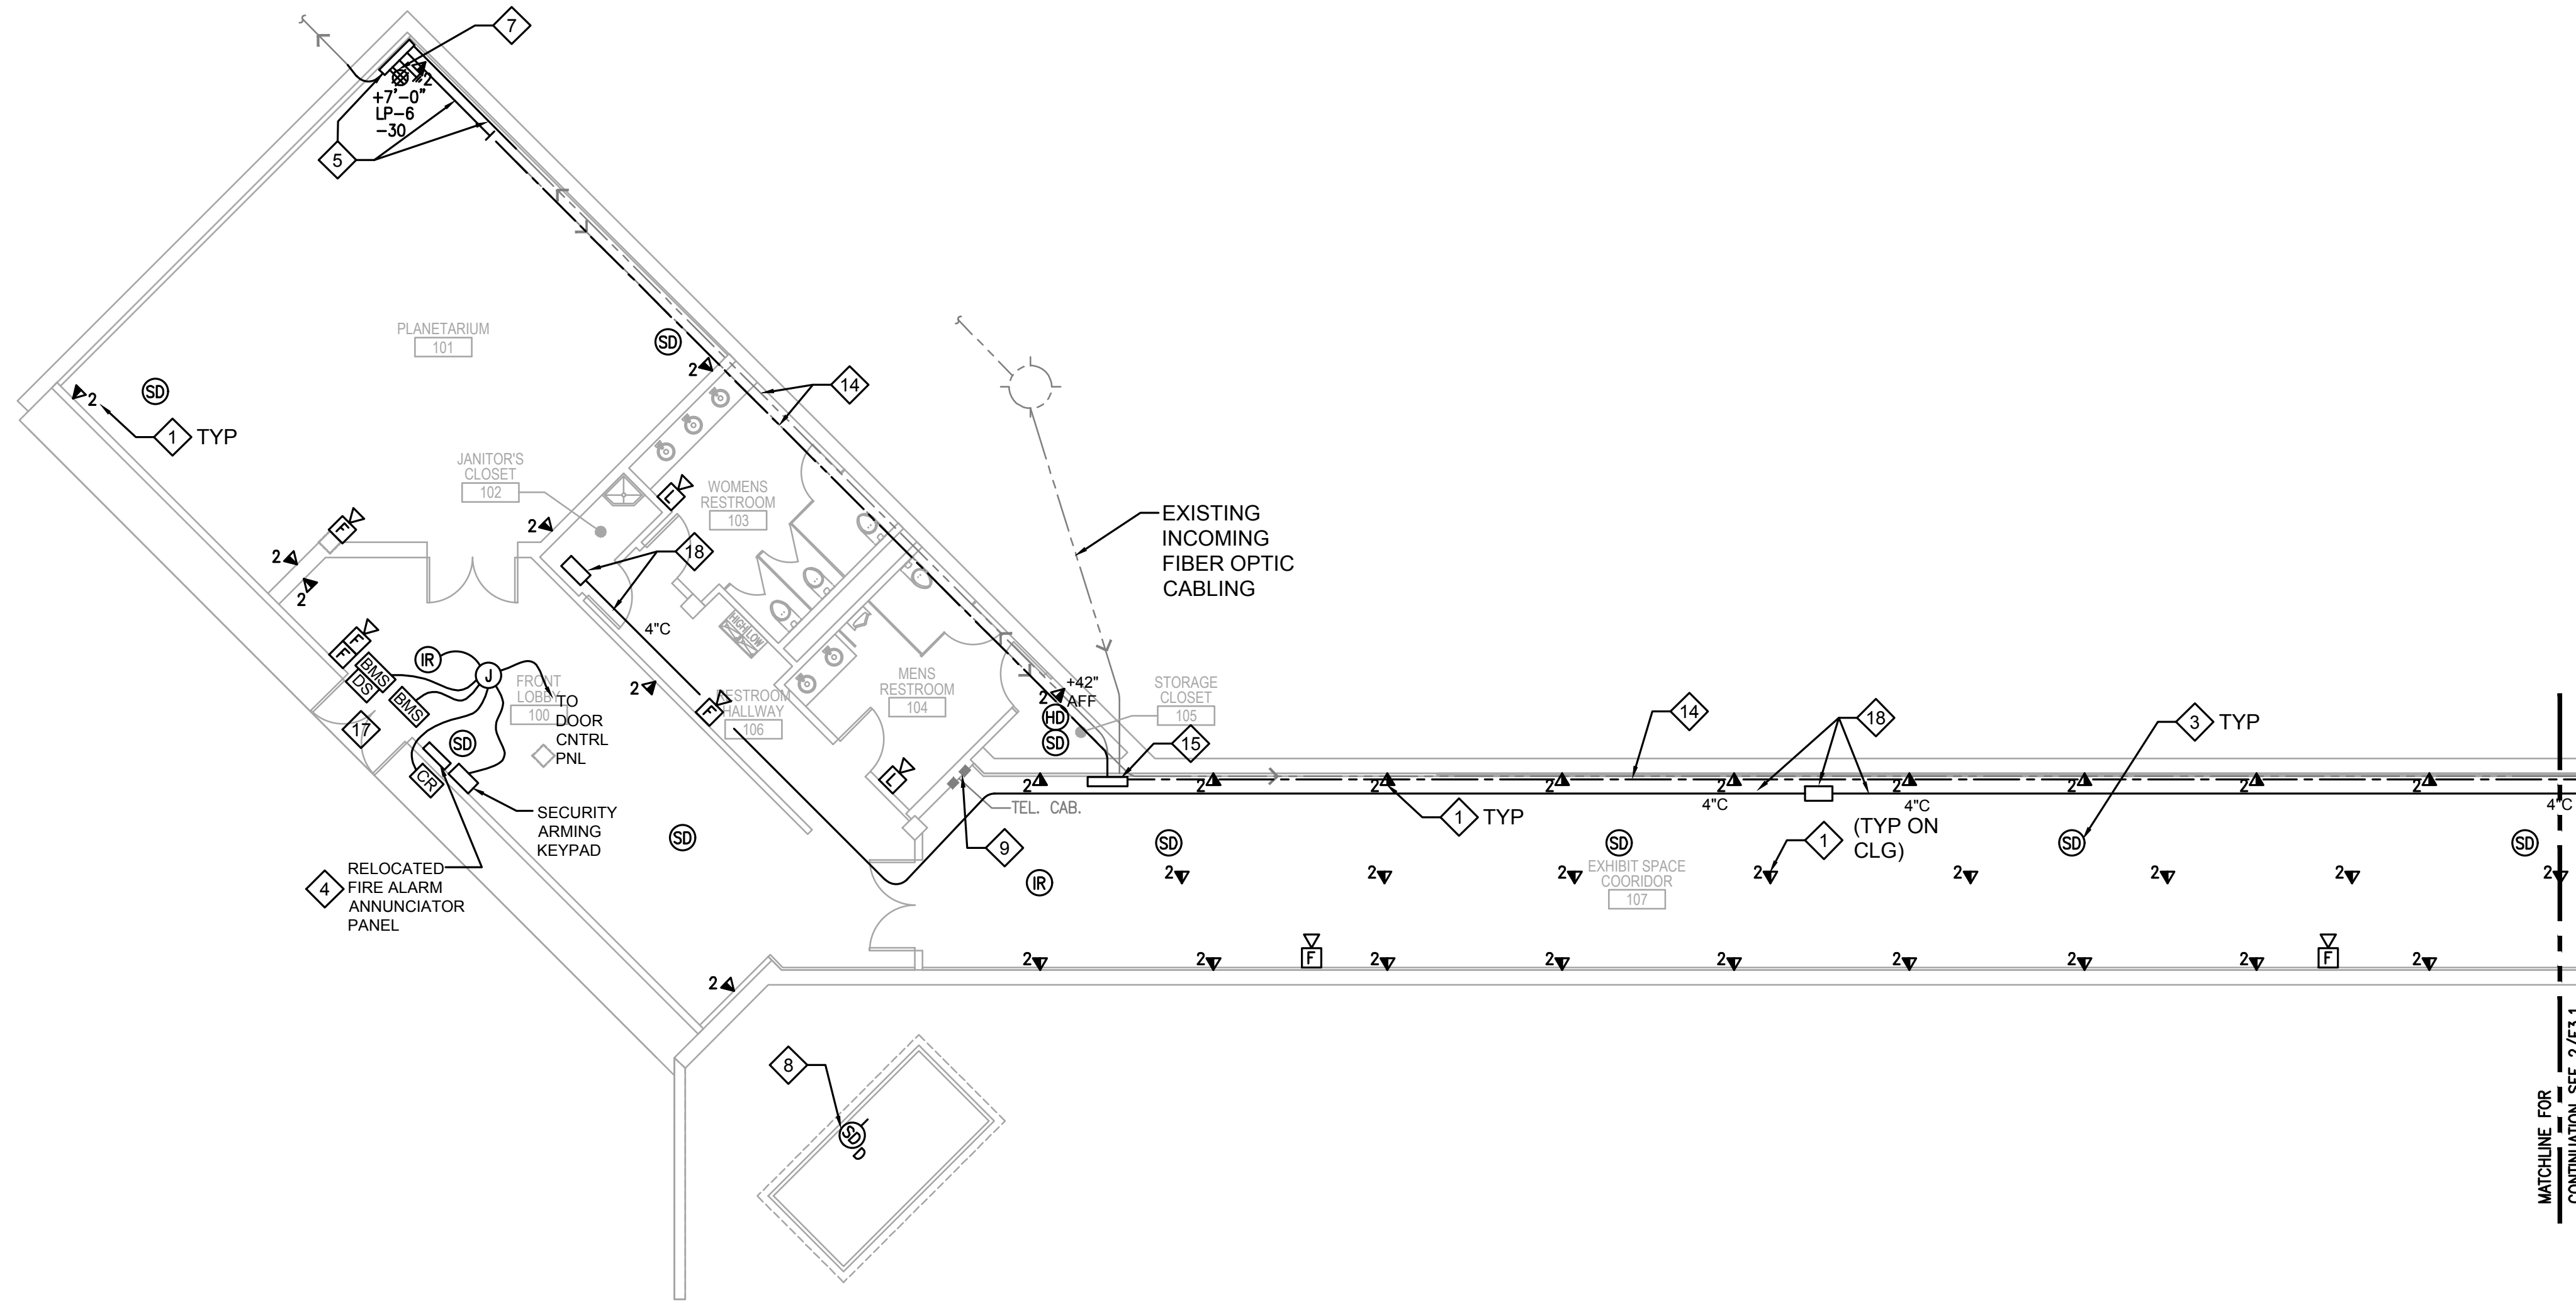SCALE: 1/8"=1'-0"



1 ELECTRICAL SYSTEMS RENOVATION PLAN
1ST LEVEL

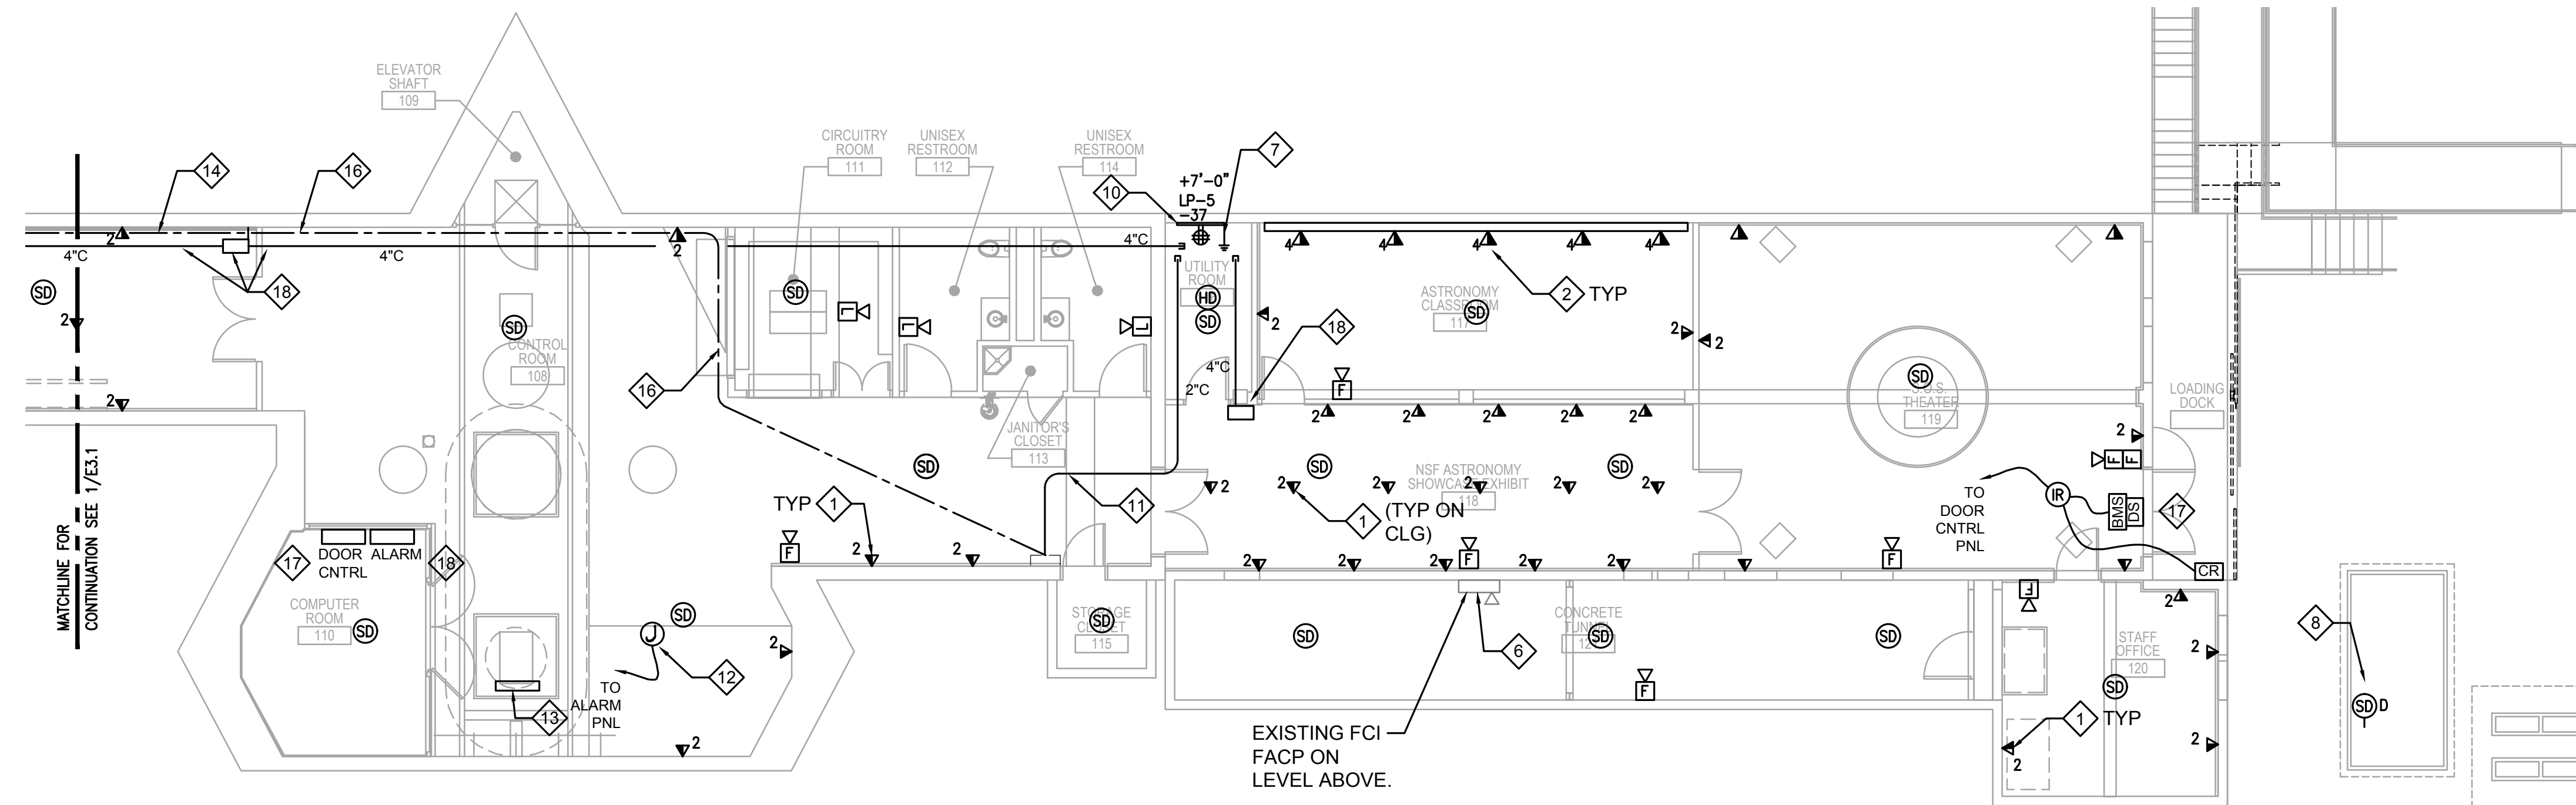SCALE: 1/8"=1'-0"



2 ELECTRICAL SYSTEMS RENOVATION PLAN
1ST LEVEL


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GENERAL NOTES:


- A. REFER TO SHEET E0.0 AND THE ENTIRE SET FOR ADDITIONAL INFORMATION AND REQUIREMENTS.
- B. PROVIDE A COMPLETE AND FUNCTIONAL VOICE/DATA CABLING SYSTEM FOR CONNECTION OF ALL OUTLETS TO THE IHF SERVER LOCATED ON THE 2ND LEVEL. INCLUDE COPPER CAT 6E STATION CABLING, FIBER CABLING, CONDUIT, PATCH PANELS, LABELING AND FIRE RATED PLYWOOD BACKBOARDS. COORDINATE CABLING STANDARDS WITH OWNER.

KEYNOTES:

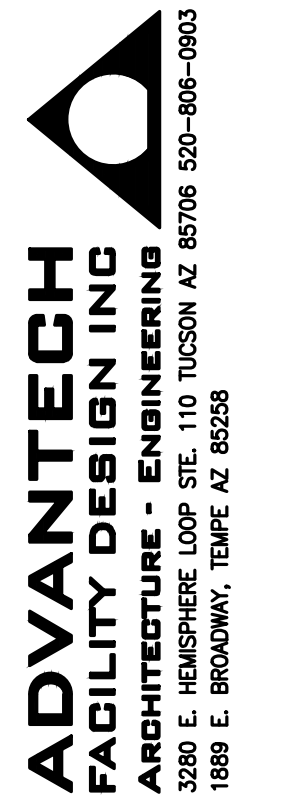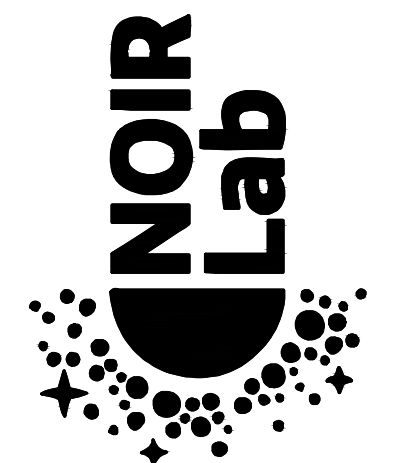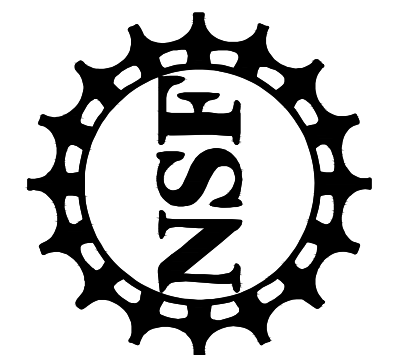
1. PROVIDE TELE/DATA OUTLET EXTEND 1" TO PATCH PANEL OR LOCAL PULL BOX.
2. PROVIDE TELE/DATA OUTLET G4000 WIREMOLD, STUB 1" TO PATCH PANEL.
3. PROVIDE NEW FIRE ALARM DEVICE. EXTEND MANUFACTURER REQUIRED NETWORK CABLING IN CONDUIT TO EXISTING FACP ON 2ND LEVEL.
4. NEW LOCATION OF FAAP, EXTEND WIRE/CONDUIT TO NEW LOCATION.
5. NEW LOCATION OF FIBER HUB. REINSTALL BACKBOARD AND ASSOCIATED EQUIPMENT ON WALL AT 84" AFF. DIVERT EXISTING FIBER CABLING TO NEW HUB LOCATION.
6. PROVIDE ANALOG TELEPHONE LINES FROM EXISTING TEL CABINET TO EXISTING FACP FOR DIAL-UP MODEM.
7. PROVIDE # 6 GND FOR NEW PATCH PANEL AND SWITCH. BOND TO ELECTRICAL SYSTEM GROUND.
8. PROVIDE DUCT MTD. SMOKE DETECTOR CONNECT TO EXISTING FIRE ALARM SYSTEM.
9. EXISTING TEL BOARD W/ EXISTING ANALOG LINES AVAILABLE.
10. PROVIDE NEW IT HUB INCLUDING 12 STRAND FIBER OPTIC CABLING TO EXISTING IHF DATA CENTER ON 2ND LEVEL, LIU FIBER PATCH PANEL AND (2) 96 PORT COPPER STATION CABLE PATCH PANELS. SWITCH AND ACTIVE EQUIPMENT BY OWNER.
11. PROVIDE NEW FIBER OPTIC CABLE FROM IHF SERVER IN 2" C.
12. PROVIDE JUNCTION BOX AND 1" CONDUIT TO SECURITY ALARM PANEL BELOW RAISED FLOOR FOR SECURITY CONNECTION TO MOON ROCK EXHIBIT.
13. PROVIDE 4" L WIREWAY FOR CONCEALMENT OF EXISTING UNDER-FLOOR FIBER OPTIC CABLING FROM ENTRY HATCH VIEW.
14. RE-INSTALL EXISTING EXPOSED FIBER OPTIC CABLING THROUGH EMPTY CONDUIT MADE AVAILABLE FROM REMOVAL OF DEAD FIBER CABLING.
15. PROVIDE A WALL MTD. 36"LX36"HX18"D PULL BOX FOR CONCEALMENT OF EXISTING UTILITY FIBER SPLICE CLOSURE. INSTALL AT CEILING LEVEL. PROVIDE CONDUIT CONNECTIONS AND OR GROMMETS AS APPLICABLE FOR IN/OUT CABLING/CONDUIT.
16. PROVIDE NEW 1" C FOR REROUTED FIBER CABLING IN THIS AREA. STUB UP TO IHF DATA ROOM.
17. PROVIDE A COMPLETE TURN-KEY CARD ACCESS CONTROL SYSTEM FOR DOOR SECURITY. INCLUDE CENTRAL DOOR CONTROLLER, ELECTRONIC DOOR STRIKES, MAG STATUS SWITCHES AND PROXIMITY CARD READERS. INSTALL ALL CABLING IN CONDUIT. PROVIDE SYSTEM COMMISSIONING AND OWNER TRAINING. PROVIDE DATA CONNECTION TO IHF DATA CENTER FOR OWNER MONITORING AND PROGRAMMING.
18. PROVIDE CONDUIT AND PULL BOX FOR LOCAL DATA CABLING CONDUIT. INSTALL TIGHT TO CLG. STRUCTURE, CONCEAL AS MUCH AS POSSIBLE.



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CENTER FOR
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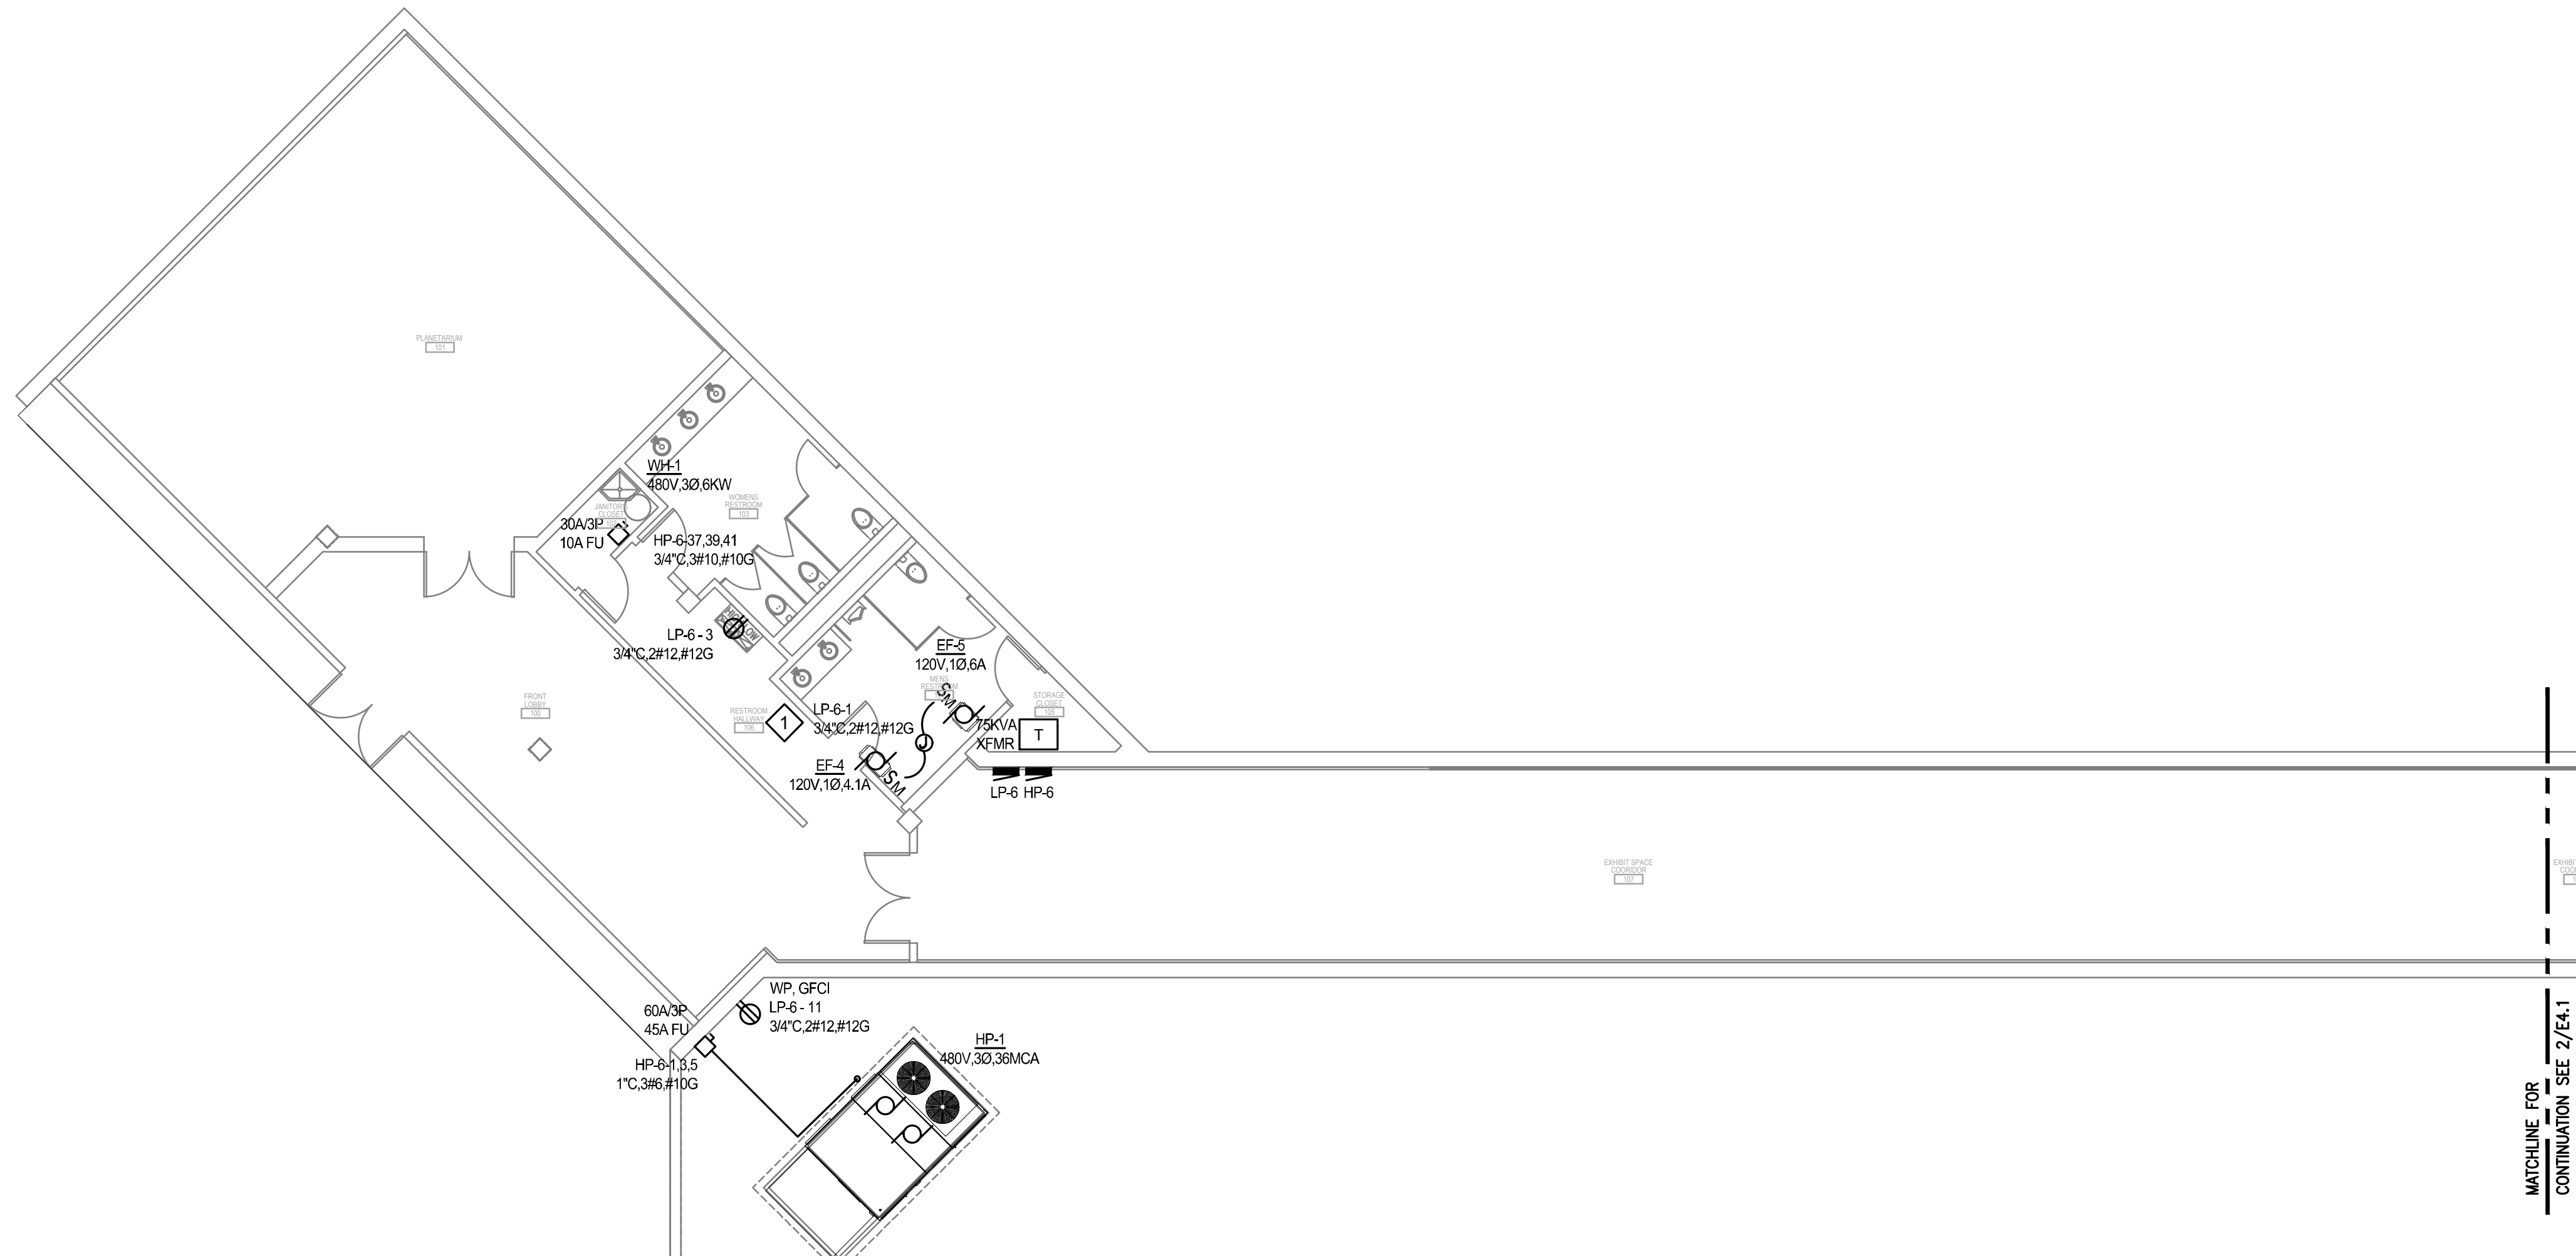


DATE	DESCRIPTION
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CAD FILE:	11904.00-E3.1
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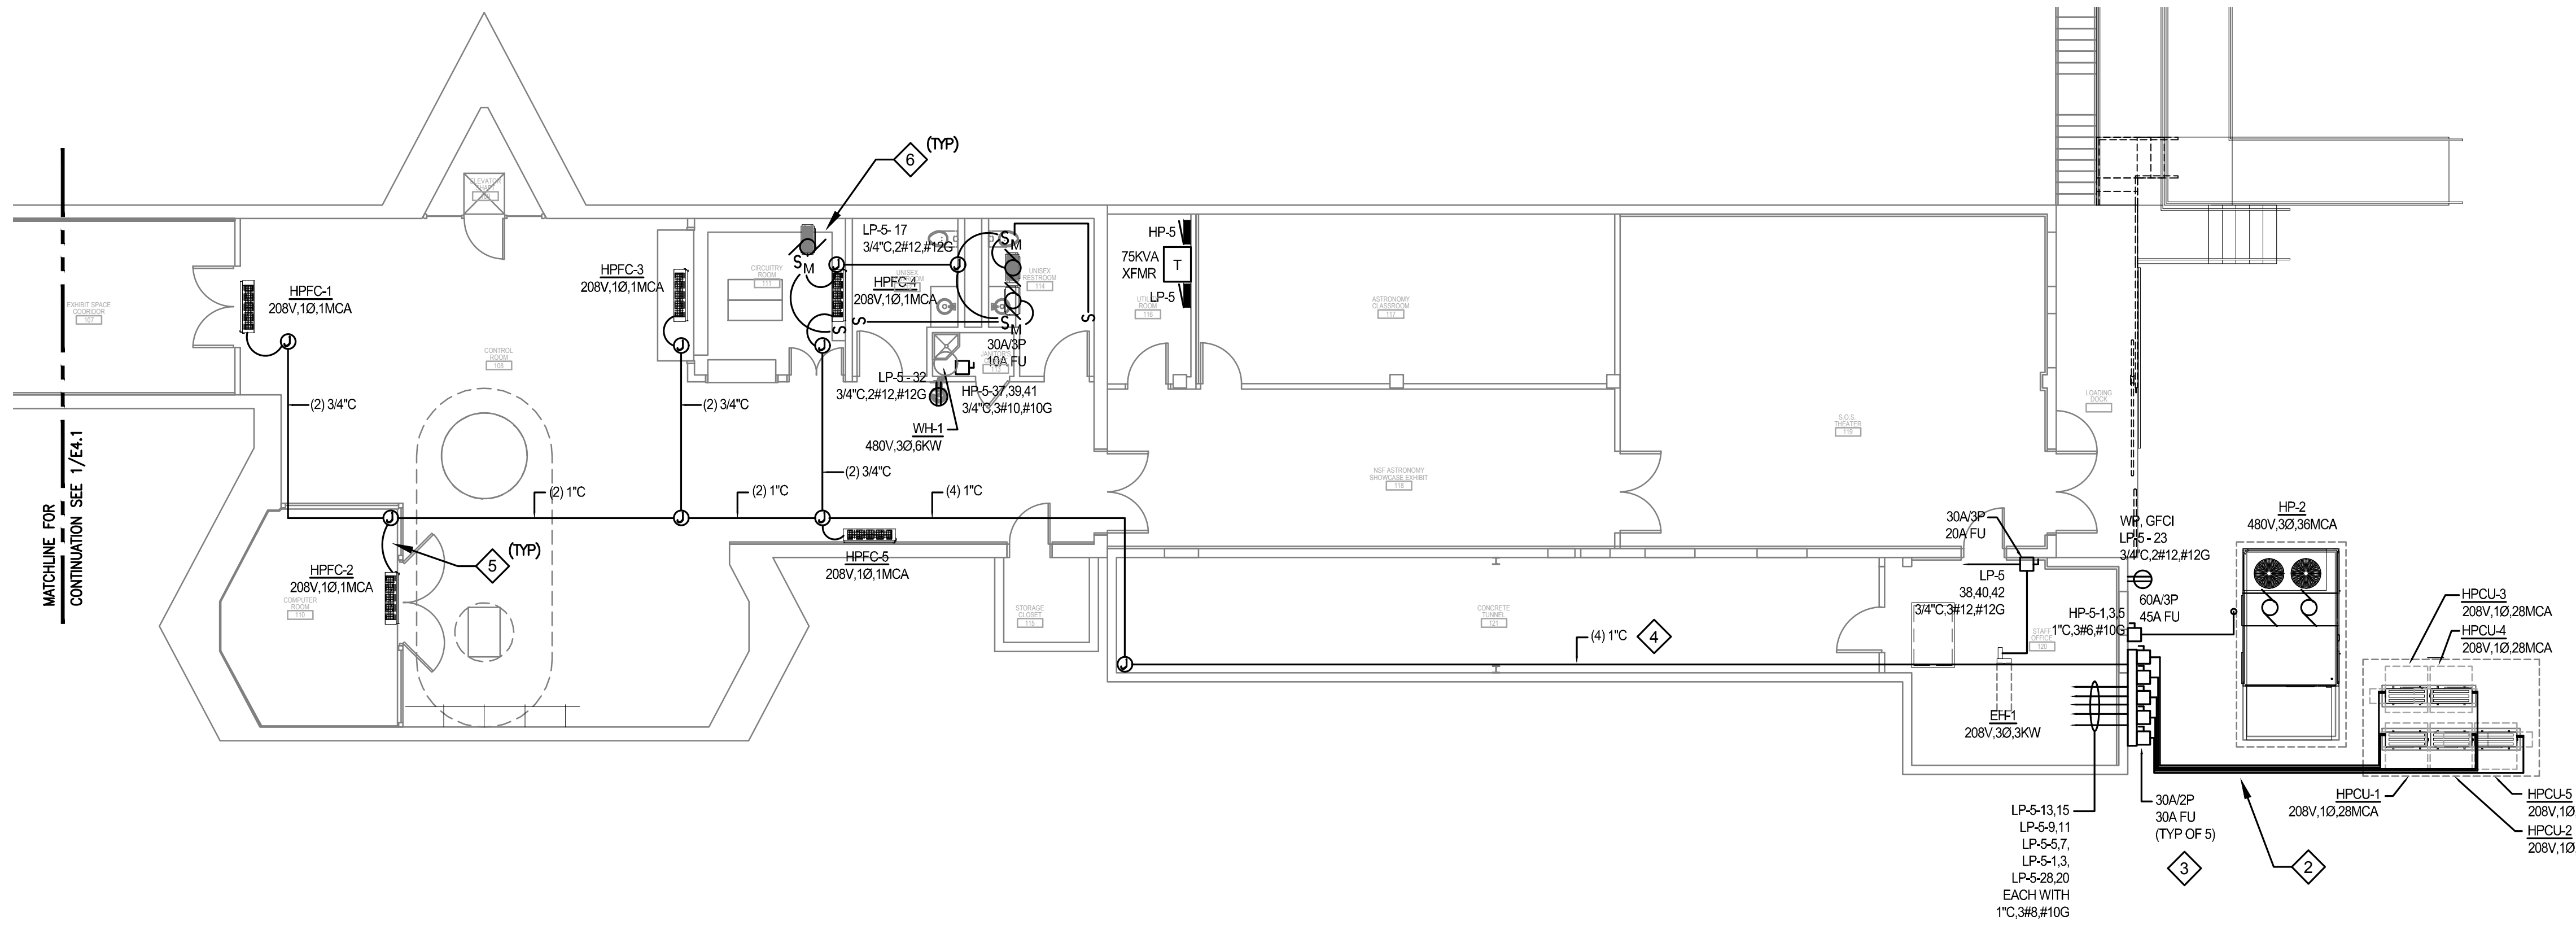
ELECTRICAL
SYSTEMS
RENOVATION PLANS

E3.1



1 ELECTRICAL HVAC POWER RENOVATION PLAN
1ST LEVEL

SCALE: 1/8"=1'-0"



2 ELECTRICAL HVAC POWER RENOVATION PLAN
1ST LEVEL


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GENERAL NOTES:


- A. REFER TO SHEET E0.0 AND THE ENTIRE SET FOR ADDITIONAL INFORMATION AND REQUIREMENTS.
- B. COORDINATE ALL CONDUIT RUNS AND ELECTRICAL DEVICE LOCATIONS WITH MECHANICAL EQUIPMENT.

KEYNOTES:

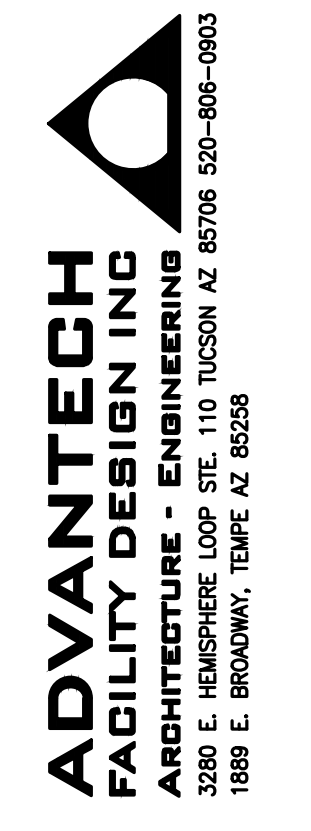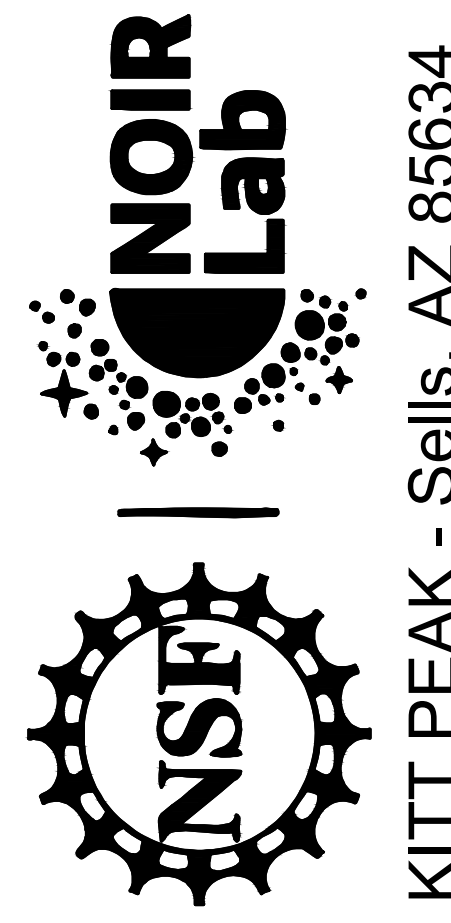1. PROVIDE RELAY FOR INTERLOCK OF EF-3 AND EF-4 WITH HP-1. WHEN HP-1 RUNS, FANS RUN.
2. EXTEND (2) 3/4" C FROM EACH HPCU TO THE WIREWAY. INSTALL CONDUITS ON PIPE RACK.
3. PROVIDE A NEMA 3R WIREWAY FOR POWER AND CONTROLS CKTS.
4. PROVIDE CONDUITS TO HPFC UNITS AS INDICATED. GROUP NO MORE THAN (3) POWER CKTS. PER CONDUIT. ALL CONTROLS WIRING CAN BE IN A COMMON CONDUIT.
5. PROVIDE (1) POWER CONDUIT AND (1) CONTROLS CONDUIT TO EACH HPFC UNIT. PROVIDE CABLING PER MFR'S RECOMMENDATIONS. NOTE THAT UNITS WILL PROVIDE ERROR SIGNAL IF CABLING IS TOO LARGE OR TOO SMALL.
6. PROVIDE LOCAL CONTROL SWITCH AT 48" AFF IN ADDITION TO THE MANUAL MOTOR STARTER DISC. SW. AT THE UNIT.



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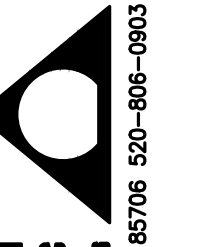
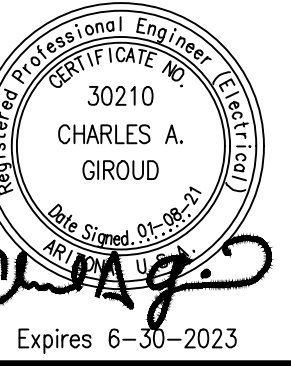
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CAD FILE: 11904.00-E4.1
SCALE: AS SHOWN

ELECTRICAL
HVAC POWER
RENOVATION PLANS

E4.1

GENERAL NOTES:

- A. REFER TO SHEET E0.0 AND THE ENTIRE SET FOR ADDITIONAL INFORMATION AND REQUIREMENTS
- B. LIGHT FIXTURES INDICATED ARE FOR BASIS OF DESIGN, SUBSTITUTIONS OF EQUAL QUALITY AND PERFORMANCE ARE ACCEPTABLE.





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BASE OPTION TO BE BLACK TRIM, TYP. ALL FINAL FINISH SELECTIONS TO BE VERIFIED BY OWNER.

LIGHT FIXTURE SCHEDULE							
SYMBOL	VOLTS	MOUNTING	DESCRIPTION	MANUFACTURER	LAMP TYPE	LAMP WATTS	LOCATION
A	MVOLT	SUSPENDED	SMARTTRACK 48V, 2-CIRCUIT TRACK SYSTEM, BLACK FINISH. LENGTH AS REQUIRED. PROVIDE 480W CURRENT LIMITER EVERY 8'-0". BRUCKLIGHTING.COM. PROVIDE MOUNTING HANGERS	BRUCK - LEDRABRANDS CONTACT ARIZONA LIGHTING, JARRAD REDWINE 1-520-392-8258	-	-	LOBBY, CLASS ROOMS, EXHIBITS SOS, THEATER, ETC.
B	MVOLT	TRACK HEAD	LEDRABRANDS FIXTURE HEADS TO BE SELECTED BY OWNER. BRUCKLIGHTING.COM	BRUCK - LEDRABRANDS CONTACT ARIZONA LIGHTING, JARRAD REDWINE 1-520-392-8258	LED 80CRI	-	TRACK
C	MVOLT	SURFACE/ PENDANT	4'L INDUSTRIAL, LITHONIA UFIT LED	LITHONIA	LED 4000 LUMENS 80CRI, 4000K	30W	OFFICE/ TUNNEL / CIRCUITRY ROOM
D	MVOLT	PENDANT	SLIMFORM LED JSF 11IN MVOLT ZT WH. PROVIDE EBX. OWNER TO SELECT TRIM	JUNO	LED 1305 LUMENS 90 CRI 2700K	15.2W	-
E	MVOLT	SURFACE WALL SCONCE	8' SURFACE MOUNT EDGE 2 FIXTURE, SURFACE CORNER MOUNT, INTEGRAL NON DIMMING DRIVER	AXIS LIGHTING	LED 850 LUMENS PER LN FOOT 80CRI, 3500K	32.7W	MEN AND WOMEN'S REST ROOM
F	MVOLT	SURFACE WALL SCONCE	4' SURFACE MOUNT EDGE 2 FIXTURE, SURFACE CORNER MOUNT, INTEGRAL NON DIMMING DRIVER	AXIS LIGHTING	LED 4000 LUMENS PER LN FOOT 80CRI, 3500K	32W	MEN AND WOMEN'S REST ROOM
G	MVOLT	SURFACE WALL SCONCE	BLWP4 40LHE ADMS MVOLT EZ1	LITHONIA	LED LP835 4000 LUMENS 82CRI, 3500K	37W	JANITORS CLOSET
H	MVOLT	SURFACE	S2LS LLP 4	LITHONIA	LED 3200 LUMENS 80CRI, 3500K	28W	SOLOR TUBE LIGHT
Eb	MVOLT	SURFACE	LED EMERGENCY LIGHT FIXTURE WITH AIMABLE LAMPS, BATTERY BACK-UP, MULTI-VOLT, BLACK FINISH.	LITHONIA ELM6L SERIES	LED 1100 LUMENS	6.6	EMERGENCY EGRESS LIGHT FIXTURE
X	MVOLT	SUSPENDED/ SURFACE	LED EDGE LIT EXIT SIGN, RED LETTERS , BRUSHED ALUM FINISH, EDG, BATTERY BACK UP, MULTI-VOLT.	LITHONIA EDG	LED	3.9	PATH OF EGRESS

WINDOWS ON
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 OUTREACH

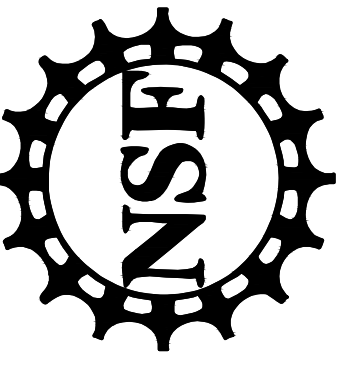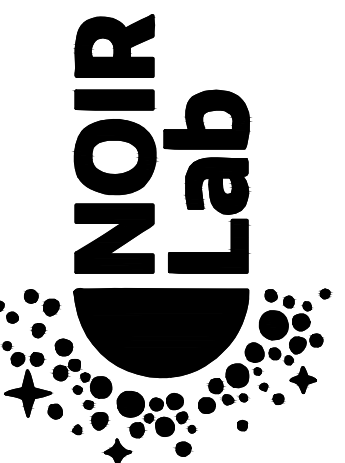

KITT PEAK - Sells, AZ 85634

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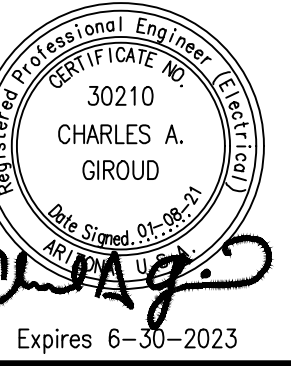
PROJECT NUMBER: 11904.00
 DRAWN BY: DLH
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 CAD FILE: 31801-E6.0
 SCALE: AS NOTED

ELECTRICAL
 SCHEDULES

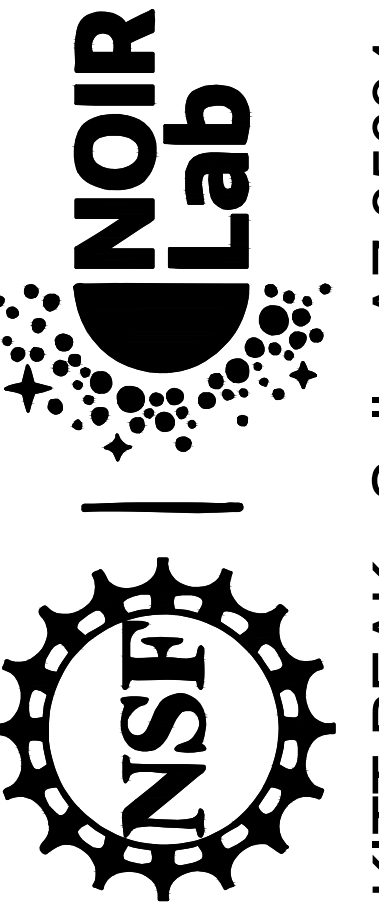
E6.0

GENERAL NOTES:

REFER TO SHEET E0.0 AND THE ENTIRE SET FOR ADDITIONAL INFORMATION AND REQUIREMENTS



WINDOWS ON THE UNIVERSE CENTER FOR ASTRONOMY OUTREACH



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CAD FILE: 31801-E6.1

SCALE: AS NOTED

ELECTRICAL SCHEDULES

E6.1

Panel HP-5 schedule table for Main 400A MCB. Includes columns for load description, VA load (A, B, C), and various electrical parameters. Total VA is 164300.

Panel LP-5 schedule table for Main 225A MCB. Includes columns for load description, VA load (A, B, C), and various electrical parameters. Total VA is 42539.

Panel HP-6 schedule table for Main 200A MCB. Includes columns for load description, VA load (A, B, C), and various electrical parameters. Total VA is 72193.

Panel LP-6 schedule table for Main 225A MCB. Includes columns for load description, VA load (A, B, C), and various electrical parameters. Total VA is 18312.

FAULT CURRENT CALCULATIONS

FAULT CURRENT AT THE SERVICE (MECH. PUMP HOUSE)

FAULT #1
 $f = \frac{1.732 \times 440 \times 32,600}{30,096 \times 480} = 0.33$
 $m = \frac{1}{1+f} = \frac{1}{1+0.33} = 0.75$
FAULT #1 @ MCC-1
 $32,600AC \times 0.75 = \underline{24,450AC}$

FAULT #2
 $f = \frac{1.732 \times 340 \times 24,450}{16,673 \times 480} = 1.80$
 $m = \frac{1}{1+f} = \frac{1}{1+1.80} = 0.36$
FAULT #2 @ TAP
 $24,450AC \times 0.36 = \underline{8,802AC}$

FAULT #3
 $f = \frac{1.732 \times 140 \times 8,802}{16,673 \times 480} = 0.27$
 $m = \frac{1}{1+f} = \frac{1}{1+0.27} = 0.79$
FAULT #3 @ HP-6
 $8,802AC \times 0.79 = \underline{6,954AC}$

FAULT #4
 $f = \frac{1.732 \times 60 \times 8,802}{16,673 \times 480} = 0.11$
 $m = \frac{1}{1+f} = \frac{1}{1+0.11} = 0.90$
FAULT #4 @ HP-5
 $8,802AC \times 0.90 = \underline{7,922AC}$

FAULT #5
 $f = \frac{1.732 \times 10 \times 32,600}{7,493 \times 480} = 0.16$
 $m = \frac{1}{1+f} = \frac{1}{1+0.16} = 0.86$
FAULT #2 @ HP-5
 $32,600AC \times 0.86 = \underline{28,036AC}$

LOAD CALCULATIONS
 (MCC-1 600A, 277/480V-3P)

400A TAP (INCLUDES PANELS HP-5, HP-6)
 HP-5 (INCLUDES LP-5) - 126A
 HP-6 (INCLUDES LP-6) - 116A
 SUB TOTAL - 242A

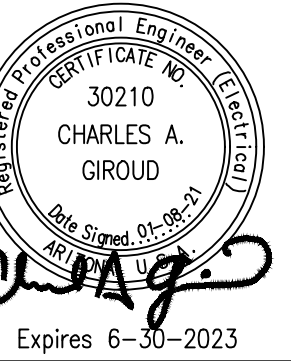
PANEL P-3 - 200A
PANEL L-1 - 38A
MCC-1 TOTAL - 480A

GENERAL NOTES:



- A. REFER TO SHEET E0.0 FOR SYMBOLS ABBREVIATIONS AND GENERAL NOTES.
- B. ALL WORK IS NEW UNLESS NOTED OTHERWISE NOTED.
- C. SCHEDULE POWER SHUTDOWNS WITH OWNER 2 WEEKS IN ADVANCE OF SCHEDULED WORK.
- D. PRIOR TO POWER SHUT-DOWN, VERIFY WITH OWNER STATUS OF ALL EQUIPMENT CONNECTED TO THE MCC SCHEDULED FOR DEMOLITION.

KEYNOTES:

1. ASSESS ALL BRANCH CKTS. ORIGINATING FROM THE MCC. CONSULT WITH OWNER TO DETERMINE WHETHER LOADS ARE ACTIVE OR ABLE TO BE REMOVED FROM POWER SOURCE. SEE NOTE 6. REMOVE EXISTING MCC AND ASSOCIATED WIRE/CONDUIT CONNECTIONS TO NON-OPERATIONAL EQUIPMENT WITHIN THE REFRIGERATION RM. SPLICE EXISTING SERVICE CONDUCTORS WITH NEW AS INDICATED.
2. PROVIDE NEW 2X2X4H PULL BOX OVER EXISTING CONDUIT SUBT-UPS.
3. PROVIDE NEW WIREWAY WITH SUITABLE LANDING LUGS FOR CONNECTION TO NEW EQUIPMENT.
4. RECONNECT EXISTING FEEDER LABELED ON MCC AS "PANEL 3L" TO NEW DISC. SW.
5. RETAIN EXISTING LIGHTING AND BRANCH CKTS. SUPPORTING REFRIGERATION RM. AND CONNECT TO NEW PANEL.
6. PROVIDE A COST ADD ALTERNATE FOR A NEW 480V PANEL IN THE EVENT THAT LOCAL, UNKNOWN EQUIPMENT REQUIRING 480V IS IN NEED OF RECONNECTION. FOR PRICING PURPOSES MAKE ALLOWANCE FOR (4) NEMA SIZE 1 MAGNETIC MOTOR STARTERS AND BRANCH CKTS. AT 30A/3P, 3/4"C, 3#10, 75FT IN LENGTH. PRIOR TO PURCHASE, MAKE ADJUSTMENTS TO NEW PANEL BREAKERS AND BRANCH CKT. SIZING TO MATCH ACTUAL REQUIREMENTS. THIS WORK REQUIRES OWNER APPROVAL PRIOR TO EQUIPMENT PURCHASES. NOTE: EQUIPMENT MUST BE THOROUGHLY REVIEWED BEFORE DISCONNECTING / REMOVING IN ORDER TO ENSURE POWER TO IHF DOES NOT GET DISCONNECTED, AS IT IS CURRENTLY BEING FED FROM AN (E) BREAKER.
7. UNDER THE COST ALTERNATE IN NOTE 6, RETAIN CONTROL WIRING IN EXISTING CONDUIT AND TERMINATE IN A LOCAL 12"X12"X6"D JUNCTION BOX AND EXTEND TO NEW MOTOR CONTROL DEVICES AS REQUIRED. IF WIRING IS NOT REQUIRED UNDER NOTE 6, REMOVE BACK TO SOURCE.
8. PROVIDE SERVICE GRADE TRANSIENT VOLTAGE SURGE SUPPRESSOR, MATCH VOLTAGE AND PHASE REQUIREMENTS OF THE EXISTING SYSTEM.



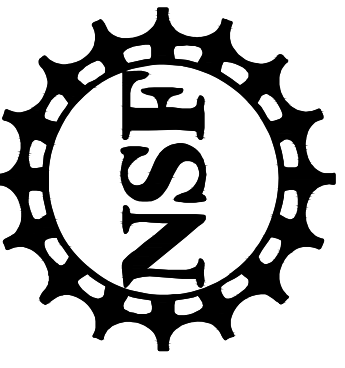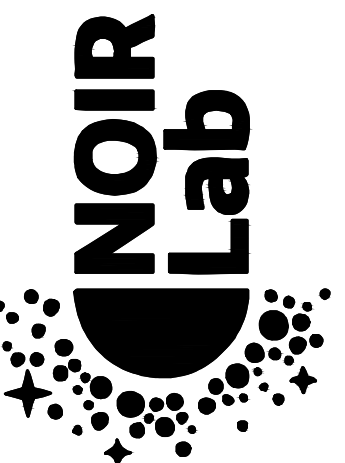WINDOWS ON THE UNIVERSE
 CENTER FOR ASTRONOMY OUTREACH



KITT PEAK - Sells, AZ 85634


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 SCALE: AS NOTED

ELECTRICAL DIAGRAMS

E7.0

SCHEDULE OF EQUIPMENT FOR 480V, 3PH MOTOR CONTROL CENTER 'M'					
ITEM	DESCRIPTION	CIRCUIT BREAKER		CIRCUIT & WIRING	REMARKS
		POLES	TRIP		
(A)	MAIN BREAKER	3	600A	500 MCM	-
(B)	CONDENSER FAN	3	400A	-	DECOMMISSIONED
(C)	PANEL 3L BREAKER	3	250A	-	ACTIVE
(D)	BREAKER UNIT HEATER	2	20A	-	UNKNOWN
(E)	TRANSFORMER	3	40A	-	UNKNOWN
(F)	PUMP P2	-	-	-	DECOMMISSIONED
(G)	PUMP P-3	-	-	-	DECOMMISSIONED
(H)	PANEL L1	-	-	-	ACTIVE
(K)	XFMR FOR PNL L1 7.5KVA 120/240V SEC	-	-	-	ACTIVE
(L)	LIGHTNING PROTECTION	-	-	-	DECOMMISSIONED
(M)	CONTROL RELAY	-	-	-	UNKNOWN
(N)	AIR COMPRESSER	-	-	-	DECOMMISSIONED
(P)	FILL PUMP	-	-	-	DECOMMISSIONED
(Q)	TUNNEL PUMP	-	-	-	UNKNOWN
(R)	COMPRESER	-	-	-	DECOMMISSIONED
	UPS SYSTEM BREAKER ON EXTERIOR OF MCC	-	-	-	DECOMMISSIONED

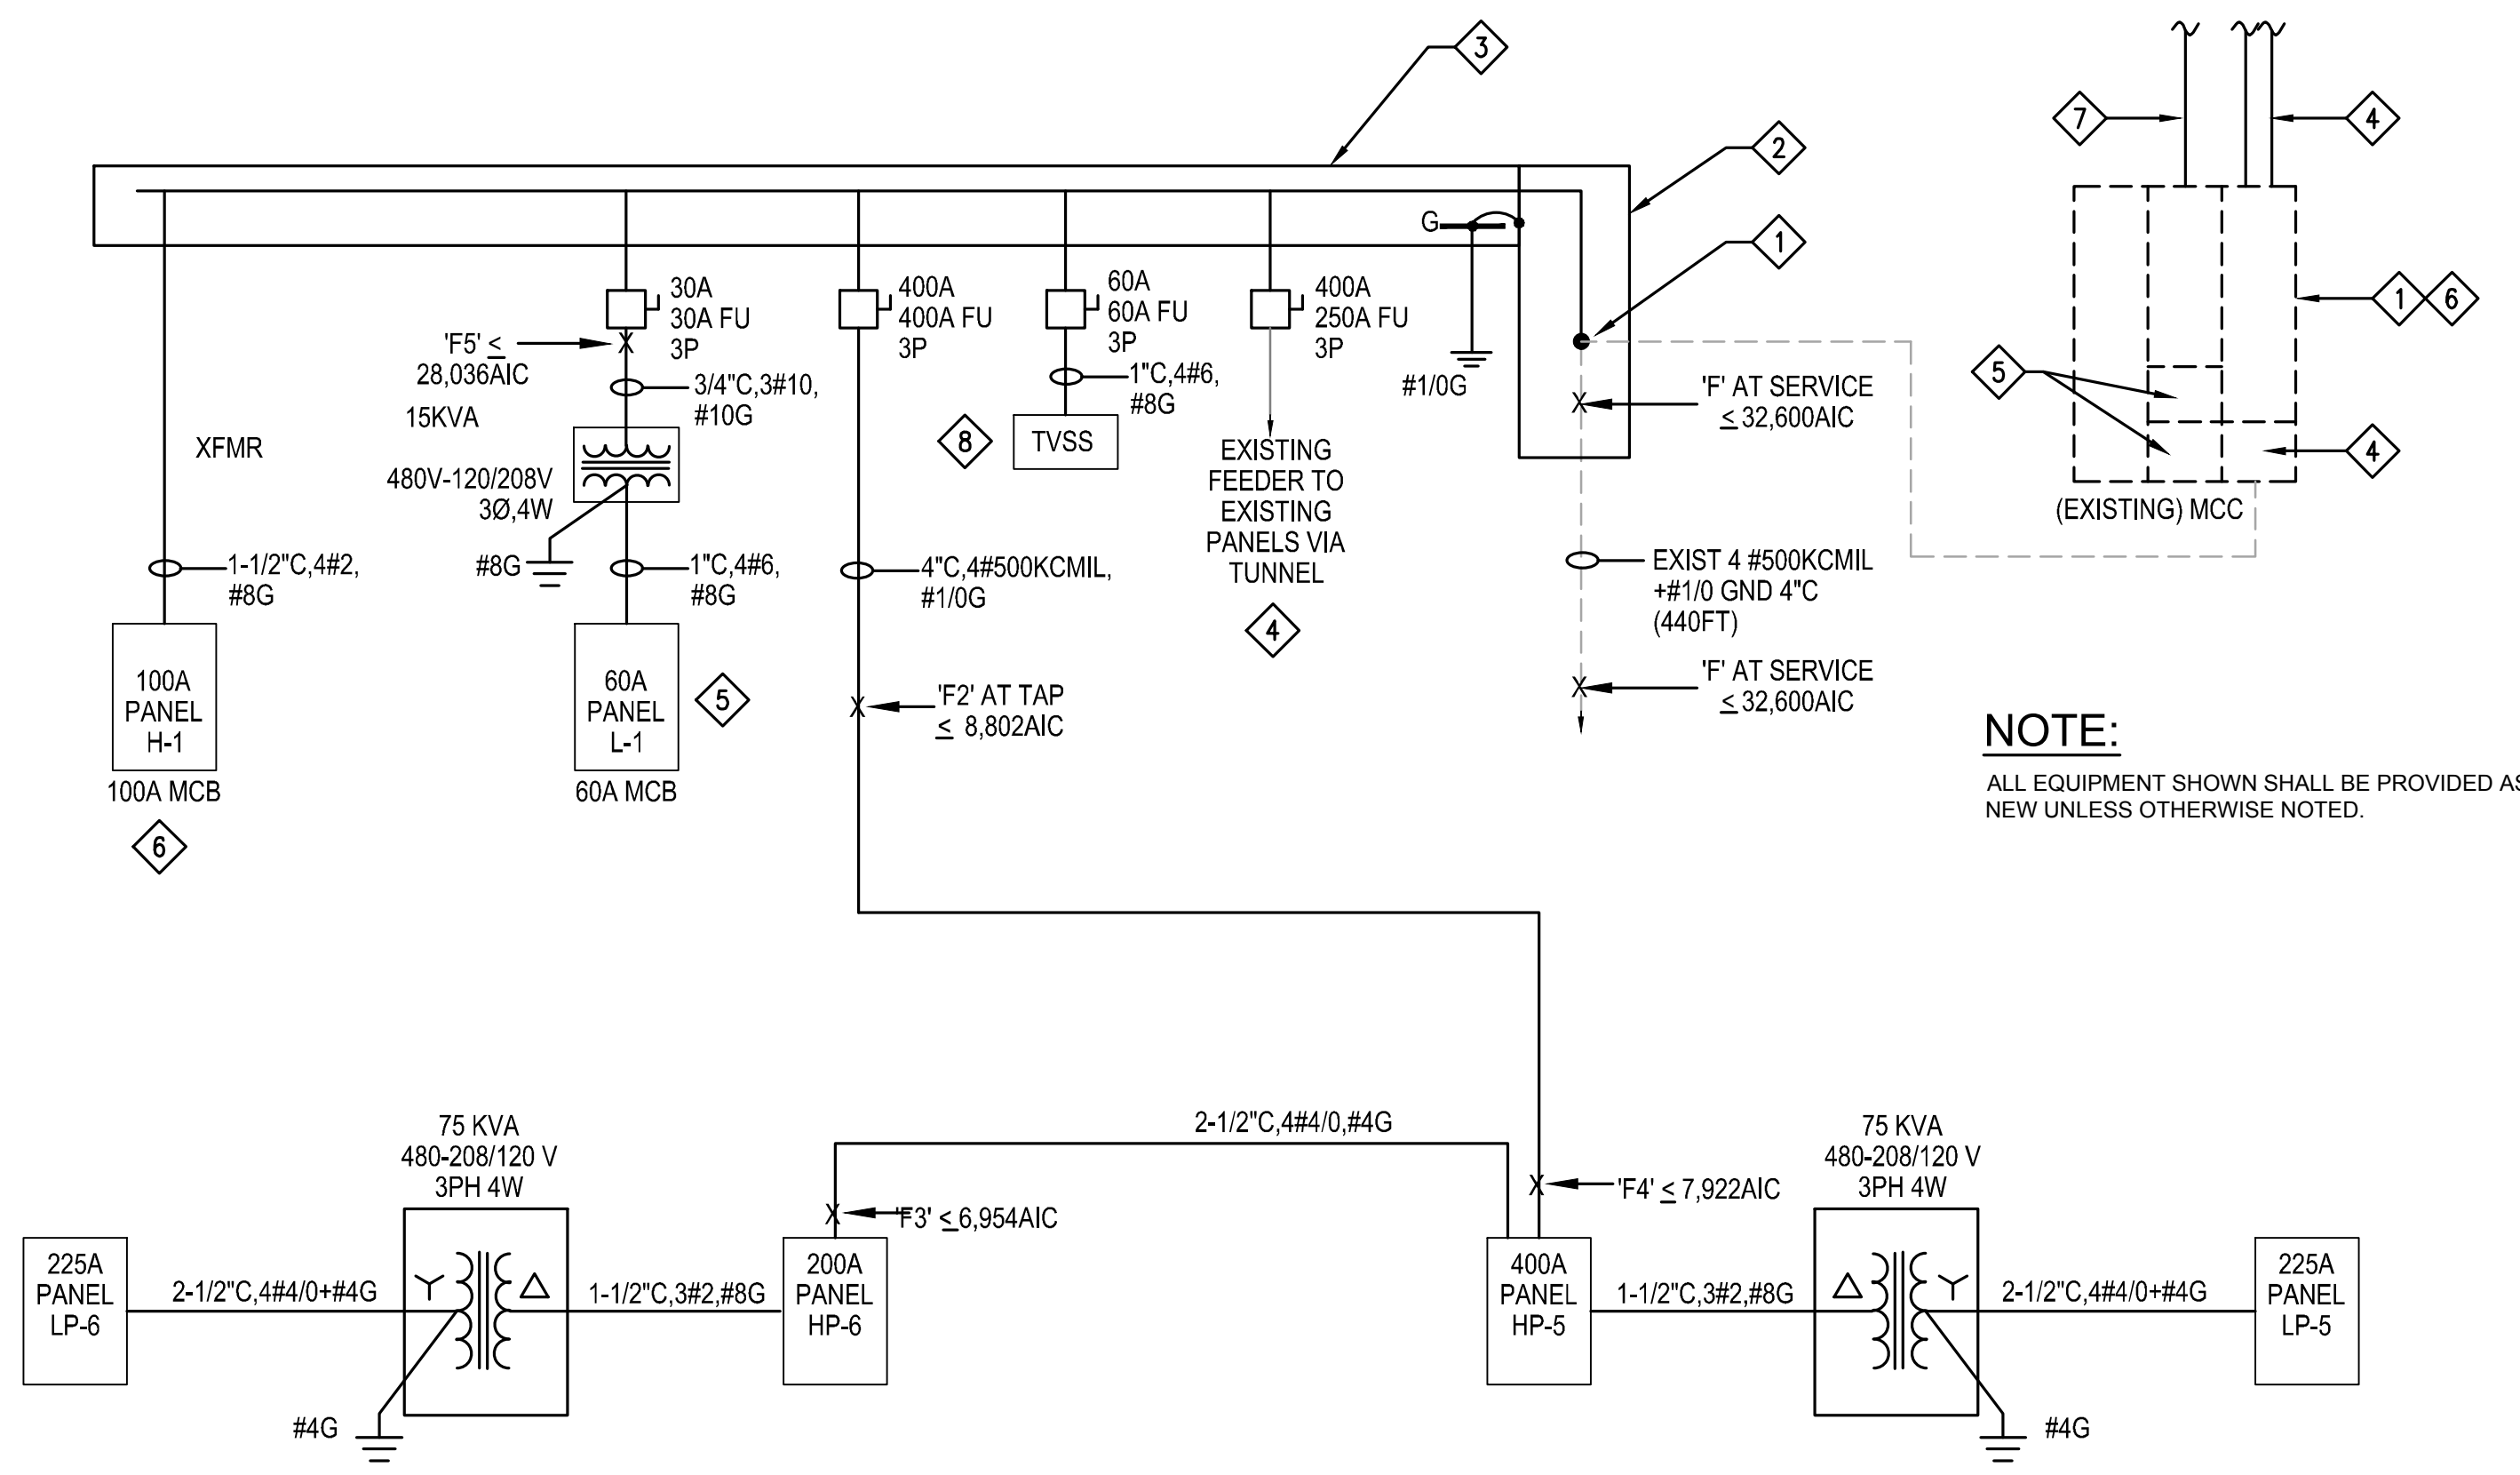

2 ORIGINAL MCC SCHEDULE (FOR REFERENCE ONLY)

1 ONE LINE DIAGRAM