# APPENDIX F - EXHIBIT DRAWINGS

# MCMATH-PIERCE SOLAR TELESCOPE EXHIBITS

# Design Development Document

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K-3.7-1	SOS: ELEVATIONS		,



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MCMATH-PIERCE SOLAR TELESCOPE EXHIBITS

Kei Space Design Ltd in collaboration with Ian C McLennan Consulting & Bill Peters Consulting

## MCMATH-PIERCE SOLAR TELESCOPE EXHIBITS

#### **GENERAL FABRICATION SPECIFICATIONS**

#### **GENERAL**

All materials and products provided shall be constructed from new materials and free from defects that may impair the strength, functionality, operability, longevity, or appearance. All work product shall be free of defects, errors, or omissions, upon completion of installation.

All materials and products provided shall be intended for commercial use and should be of the appropriate characteristics to withstand the use of general visitors of all ages to a museum. This includes making provisions for longevity and durability based on constant user operation and abuse as may occur in an interpretive environment.

Fabricator will be responsible for reviewing all design drawings, specifications, graphic schedules, component sheets and any other part of the documentation included within this package, clarifying any questions, or omissions prior to fabrication.

Fabricator is responsible for reviewing all architectural drawings and specifications, confirming site measurements and conditions prior to fabrication of all items.

#### **WOODWORK**

- All woodwork shall be fabricated to the specifications and dimensions shown on the drawings.
- All structures and wood construction to be made with zero formaldehyde products.
- Avoid interior solid wood construction to minimize expansion and contraction within structures & casework.
- Exterior wood materials should match the finishes sheet provided in this document.
- Avoid high resinous or acid woods for wood exterior wood finishes.

#### **FINISHES**

The contractor will produce sample finish boards that follow the design intent illustrated. The Finishes and materials will be subject to review and approval.

- Fabricator will submit three sample sets of each finish to be used as part of the exhibit fabrication.
- Fabricator may recommend alternative materials and methods of construction to the ones specified in the drawings for review and approval of the Design Authority .
- Plastic Laminate Samples must be minimum 6" x 6". Each sample set to represent range of color and grain expected.
- Paint finishes must meet or exceed the equivalent of a Matthews commercial grade paint.
- All finishes to be completed at the fabricator's facilities.

#### **GLASS**

- All Glass components should be tempered glass thicknesses should be minimum 8.mm, TBC by an engineer
- Where applicable, glass should be UV glued for maximum resistance according to manufacturers specifications
- All glass should have beveled and polished edges
- Fabricator will propose hardware appropriate for each situation. All hardware for glass components (hinges, fasteners and locks) must be submitted for review with cut sheets to design team, prior to ordering.

#### **EXHIBIT SYSTEM**

- The exhibits have been designed to use a modular system, this will allow the client to re-configure the exhibits in the future as needed.
- All Metalwork, assemblies and integration of materials should be completed at fabricator's shop.
- Assembly system show in drawings may be substituted for an equivalent system. Must meet museum grade standards for traffic and interaction with visitors.
- All aluminum materials should be clear anodized aluminum.
- Fabricator to verify all parts, assemblies, locks, connectors, feet, levelers, and any other materials needed to build the structures as shown in the drawing package.

#### **GRAPHICS**

- Proponents should include the graphic materials and finishes they are recommending for each application listed in the documentation.
- Refer to the graphic schedule provided for reference to quantity and sizes.
- Graphic materials should be durable and interchangeable, as the content for each unit will change in the future.
- Fabricator may recommend alternative materials and process of production of graphics to those specified in the documentation for review and approval of the Design Authority.
- All colors on the graphics shall match the Pantone colors specified in the Interpretive Text and Graphics Document.
- Three samples of all graphic processes and materials, using final colors specified must be submitted to the Design Authority (1) and representatives of NOIRLab (2) for review and approval.
- The Design Authority must review and approve color proofs of all graphic panels with final artwork and images before production begins.
- Provide three samples of all typical mounting and laminations, sufficient to demonstrate their resistance to de-lamination due to normal visitor handling.
- Provide three test strips using final color palettes and final layouts for all graphic processes at final high resolution. Size of each test strip shall be a minimum of 12" x 12". All test strips shall show full tonal variations of images.

#### MECHANICAL INTERACTIVE ELEMENTS

- Mechanical interactive elements must be built to fulfill the functionality described in the documentation, any changes to the function must be previously reviewed by the Design Authority.
- Design Drawings include a recommended approach to how interactive elements will work and function. Fabricators may recommend alternative mechanisms, forms of production, assembly and finishes for approval by Design Authority and representatives of NOIRLab.
- Any and all alternatives must meet or improve the minimum standards outlined in the documentation.
- Mechanical elements within the exhibitry must use robust mechanisms that will withstand daily use for prolonged periods of time.
- Shop drawings and prototypes where applicable will be submitted to the design authority for review and approval.

#### **MEDIA & AV EQUIPMENT**

- All AV Equipment and Media Content & Programming are not part of the exhibit fabrication package. To be provided be an AV integrator.
- Fabricator will be responsible for integration of AV equipment into exhibit millwork.
- Final AV equipment specs to be confirmed by AV integrator.
- Fabricator is responsible for identifying any Base Building requirements or infrastructure needed to complete the work.
- There are five (5) media & AV equipment components not part of this package, as follows:
  - 2.1.2 Welcome Message Video
  - 3.0.1 Theater
  - 5.7.2 The Many faces of the Sun Media Interactive
  - 6.2.1 NSF Observatories Media Interactive
  - 7.7.3 Infrared Camera Media Playback

#### **MISCELLANEOUS**

- Props and decorative items added to the exhibits must be reviewed and approved by the design team prior to purchasing.
- All props and decorative items must be easy to re-acquire or produce in the case of loose parts that may be damaged or go astray.
- Fabricator will produce duplicate sets of parts for exhibits that require loose parts.

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MCMATH-PIERCE SOLAR TELESCOPE EXHIBITS

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## **MCMATH-PIERCE SOLAR TELESCOPE EXHIBITS**

## **EXHIBIT AND GRAPHICS LIST**

No	EXHIBIT	MATERIAL & MOUNT
EXTERIO	R	
1.1.1	Entrance Sign Lettering	Exterior grade, 3D Lettering, pin mounted to wall
1.1.2	Orientation Sign - Hours/Functions	Graphics Type A
1.1.3	Entrance Sign - (printed logotypes)	Graphics Type B
1.2.1	Exterior Banner (NSF)	Graphics Type A
1.2.2	Exterior Banner (AURA/NOIRLab)	Graphics Type A
1.2.3	Exterior Banner (KPNO)	Graphics Type A
1.2.4	Exterior Banner (TON)	Graphics Type A
LOBBY		
2.1.1	Intro to KPNO & TON Partnership	Graphics Type C
2.1.2	Intro to KPNO & TON Partnership AV	Video Screen with enclosure, Mounted to Wall
2.1.3	What is NOIRLab?	Graphics Type C
2.1.4	Intro to the McMath-Pierce Solar Telescope	Graphics Type C
2.2.1	Donor Recognition & Exhibition Credits	Graphics Type C
2.3.2 to 5	-	Graphics Type E
2.0.2 10 0	Thoto posters	Oraphics Type L
THEATER		Wall mounted magnetic naneldetachie
3.1.1	Theater schedule	Wall mounted magnetic panel - updateable
3.2.1 to 9	Photo posters	Graphics Type E
	LLERY : INTRO	
4.1.1	Solar Research at the MMP	Graphics Type C
4.1.2	Studying the Moon & More	Graphics Type C
4.1.3	Studying the Moon & More	Graphics Type C
4.2.1	Building the World's Largest Telescope	Graphics Type C
4.2.2	Construction on the Mountain	Graphics Type C
4.2.3	Construction on the Mountain	Graphics Type C
4.3.1	Why Study the Sun	Graphics Type C
4.4.1	Meet the Astronomers of KPNO	Graphics Type C
MAIN GAI	│ LLERY:STARS	
5.1.1	Enter & Exit Sun Portals (2 x doubles sided)	Graphics Type D
5.1.2	Enter & Exit Sun Portals (2 x Edge Graphics)	Graphics Type D
5.2.1	What are stars?	Graphics Type C
5.2.2	What are stars?	Graphics Type C
5.3.1	Types of stars	Graphics Type C + 3D models
5.3.2	Types of stars	Graphics Type C. + 3D models
5.3.2-1	Sticker labels	Numbers printed on translucent vinyl
5.3.3	Types of stars (3D Star Section Graphic)	Graphics Type D
5.4.1	Plasma ball	Re-purpose from VC-Re-house exhibit
5.4.2	Plasma ball - Graphic Panel	Graphics Type E
5.5.1	Stars in 3D	Re-purpose from VC-Re-house exhibit
5.5.2	Stars in 3D - Graphic Panel	Graphics Type C
5.6.1	What does the Sun look like?	Graphics Type C
5.6.2	What does the Sun look like?	Graphics Type C
5.7.1	The many faces of the Sun	Graphics Type C
5.7.2	The many faces of the Sun - Interactive	Video Screen, Built into millwork enclosure
5.8.1	Spectroscopy & Star Composition	Graphics Type C
5.8.2	Spectroscopy & Star Composition	Graphics Type C
5.9.1	Life Cycle of Stars	Graphics Type C
	Life Cycle of Stars	Graphics Type C
5.9.2		Graphics Type C
5.9.2 5.10.1	Our Solar System isn't unique	Graphics Type C
5.9.2 5.10.1 5.10.2 5.11.1		Graphics Type C Graphics Type C Graphics Type C

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No No	EXHIBIT	MATERIAL & MOUNT
5.12.1	The Goldilocks Zone	Graphics Type C + 3D Models
5.12.2	The Goldilocks Zone	Graphics Type C
5.13.1	Exoplanets & search for life	Graphics Type C
5.13.2	Exoplanets & search for life	Graphics Type C
MAIN GALL	EDV · NSE	
6.1.1-1	From the Ground Up: NSF Observatories	Graphics Type C
6.1.1-1 6.1.1-2(3)	flip panels TOP / BOTTOM	Graphics Type C
5.1.1-2(3) 6.1.2-1		<del> </del>
	From the Ground Up: NSF Observatories	Graphics Type C
6.1.2-2(3)	flip panels TOP / BOTTOM	Graphics Type D
6.2.1	From the Ground Up: NSF Observatories	Video Screen, Built into millwork enclosure
6.3.1	The Mirrors Above	Graphics Type C
CONTROL	L ROOM	
7.1.1	Revealing the Heliostats	Graphics Type C
7.1.1 7.2.1	Revealing the Spectrographs	Graphics Type C
7.3.2	Our Sun Close-Up - Label	Graphics Type C
7.4.1	Solar Lab: logo	Graphics Type D
7. <del>4</del> .1 7.5.1	Optics Table	Millwork Table
7.5.1 7.5.2	Optics Table (Graphic Panel)	Graphics Type C
7.5.2 7.5.3	Optics Table Interactive	Off the shelf interactive
7.5.4	Optics Table (Instruction Panel)	Graphics Type C
7.6.1	Spectroscopy	Millwork Table
7.6.2	Spectroscopy (Graphic Panel)	Graphics Type C
7.6.3	Spectroscopy Interactive	Off the shelf interactive
7.6.4	Spectroscopy (Instruction Panel)	Graphics Type C
7.7.1	Infrared Camera	Millwork Exhibit
7.7.2	Infrared Camera (Graphic Panel)	Graphics Type C, IR Camera mounted on Gr. panel
7.7.3	Infrared Camera Interactive, AV	Video Screen, Built into millwork enclosure, IR camera
7.7.4	Infrared Camera (Instruction Panel)	Graphics Type C
7.8.1	You are Here: Tunnel above	Graphics Type C
7.9.1	Heliostats Operations Center	Graphics Type C
7.9.2	Heliostats Operations Center	Graphics Type C
7.9.4	Partition wall	Partition wall with glass panels
7.11.1	Computer Room Interpretation	Graphics Type C
7.11.2	Computer Room Interpretation	Graphics Type C
7.11.2 7.12.1 to 3	Photo Posters	Graphics Type C
7.12.1 10 0	1 Hoto i Osters	Grapines Type L
TON / ASTR	ROLAB	
8.1.1	Kitt Peak as a Sky Island	Graphics Type C
8.2.1	Community Talk-back	Graphics Type D
8.2.2-1 to 4	Community Talk-back (note panels)	Graphics Type D
8.3.1	TON Changing Exhibits (Art)	TBD Curated by TON (TBD)
8.4.1 to 6	Photo Posters	Graphics Type E
OCIENCE C	L A COUEDE	
	Dhata Dastara	Cranbias Type F
9.1.1 to 12	Photo Posters	Graphics Type E
OPTICAL V	IEWING TUNNEL	
10.1.1	Digitally printed graphic	Graphics Type D
10.1.2	Digitally printed graphic	Graphics Type D

<b>GRAPHICS TYPE</b>	MATERIAL
Type A	Exterior grade digitally printed vinyl graphics with satin overlam. Applied on 1/4" aluminum composite panel with wrapped edges.
Type B	Exterior grade digitally printed vinyl graphics with satin overlam. Applied directly to substrate.
Type C	Digitally printed vinyl graphics with satin overlam applied on 1/4" Aluminum Composite Panel with wrapped edges.
Type D	Digitally printed graphics on vinyl with satin overlam, applied directly to Millwork
Type E	Photo quality digitally printed graphics direct on aluminum 1/8" aluminum panel. Include protective overlam.

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MCMATH-PIERCE SOLAR TELESCOPE EXHIBITS

Drawin

EXHIBIT & GRAPHICS LIST

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## **MCMATH-PIERCE SOLAR TELESCOPE EXHIBITS**

### FINISHES SCHEDULE

FINISHES	EN-01	FN-02	FN-03	FN-04	FN-05	FN-06
	Solid surface Corian (or similar) Azure (optional Cobalt)	PAINT Sherwin Williams 179-C4 (6809) (Pantone 7452)	Solid Surface Corian (or similar) Deep Titanium	Solid Surface Corian (or similar) Venaro White	Vinyl cove base molding (Charcoal Slate Grey)	PAINT Sherwin Williams 256-C7 (SW 7618)

## **AV SCHEDULE**

The following schedule outlines the general equipment specifications used during the exhibit design process. The final AV equipment specs will be provided by an the a media development partner, TBC.

These specifications are included for reference only.

No	EXHIBIT	TYPE	MAKE	MODEL
2.1.2	Intro to KPNO & TON Partnership			
		43" Display	Samsung	QM43C
		Mount	premier	P2642F
		Pro SoundBar	JBL	PSB-1
		Computer (PC)	TBD	
		Cables & Connectors	TBD	
3.0.1	Presentation Theater			
		Projector	Panasonic	PT-MZ882
		Short-throw Lens	Panasonic	ET-ELW22
		Projector Mount	TBD	
		200" retractable screen	TBD	
		7.1 Surround Sound audio sy	TBD	
		Computer (PC)	TBD	
		Cables & Connectors	TBD	
5.7.2	The many faces of the Sun			
		32" touchscreen	ELO	3243L
		Mount	TBD	
		Pro SoundBar	JBL	PSB-1
		Computer (PC)	TBD	
		Cables & Connectors	TBD	
6.2.1	NSF Observatories			
		32" touchscreen	ELO	3243L
		Mount	TBD	
		Pro SoundBar	JBL	PSB-1
		Computer (PC)	TBD	
		Cables & Connectors	TBD	
7.7.3	Infrared Camera			
		32" Display	ELO	3243L
		Mount	TBD	
		IR camera	TBD	
		Computer (PC)	TBD	
		Cables & Connectors	TBD	

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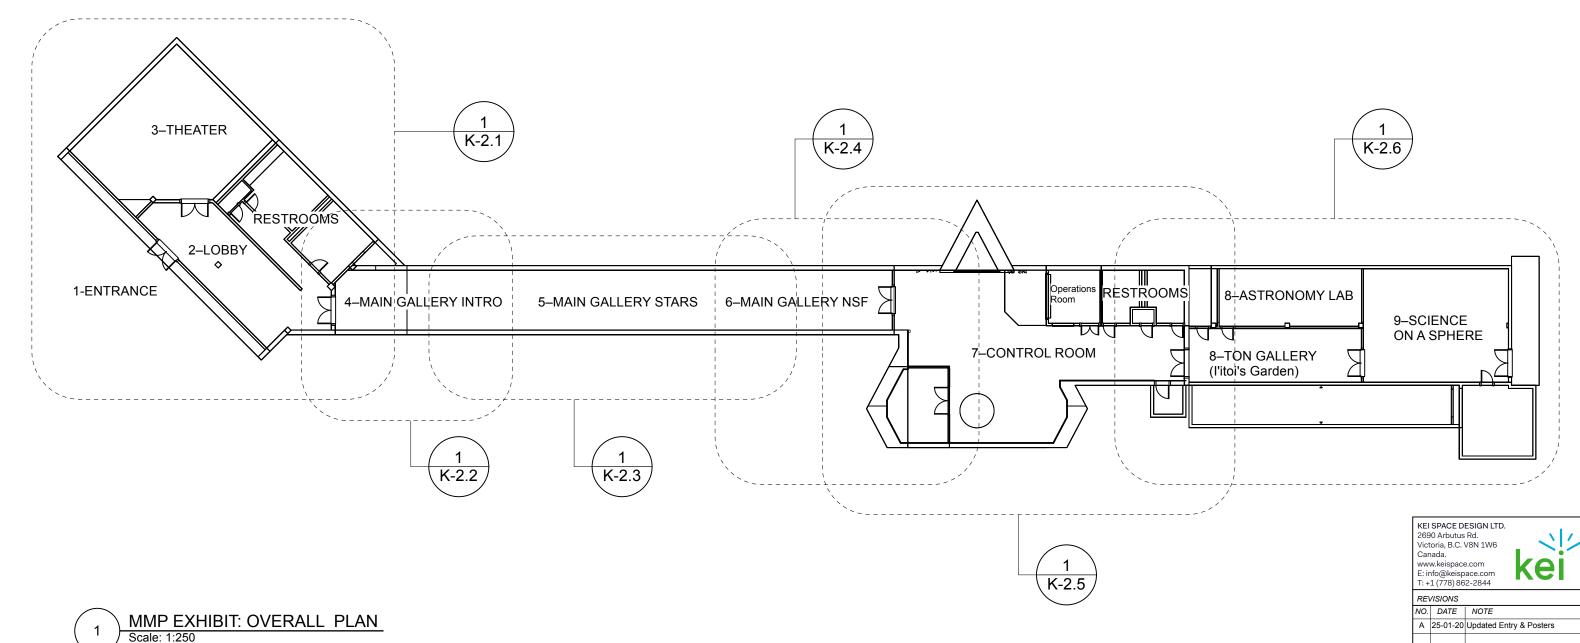
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MMP EXHIBIT: OVERALL PLAN
Scale: 1:250

Project

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Drawing


MMP-OVERALL PLAN


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MAIN GALLERY: INTRO PLAN

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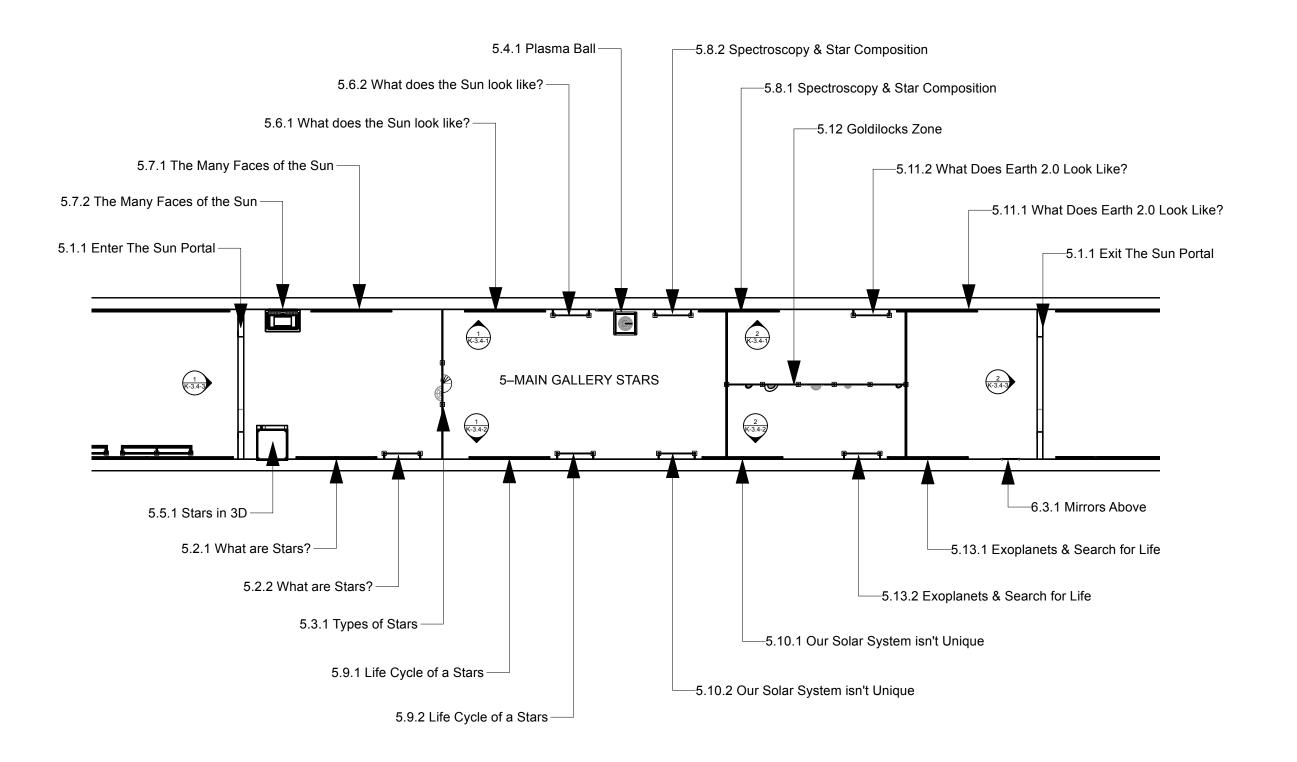
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MAIN GALLERY: EXHIBIT PLAN

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MAIN GALLERY: STARS PLAN


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MAIN GALLERY: EXHIBIT PLAN
Scale: 1:100
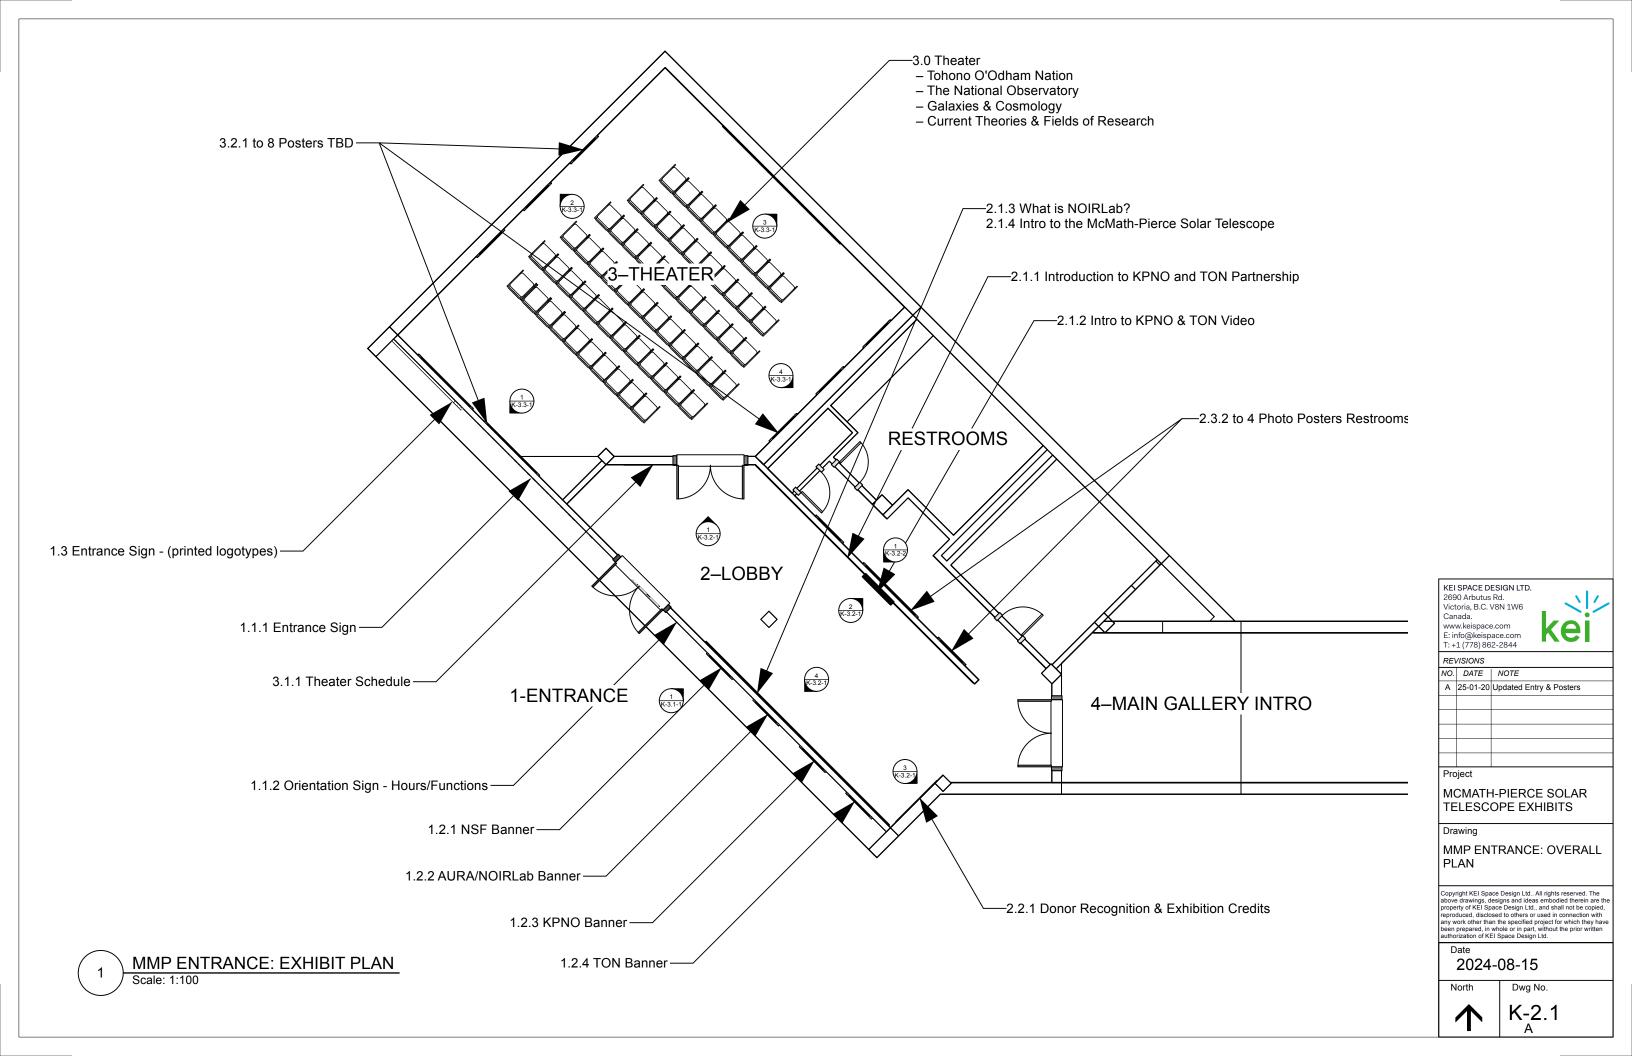
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MCMATH-PIERCE SOLAR TELESCOPE EXHIBITS

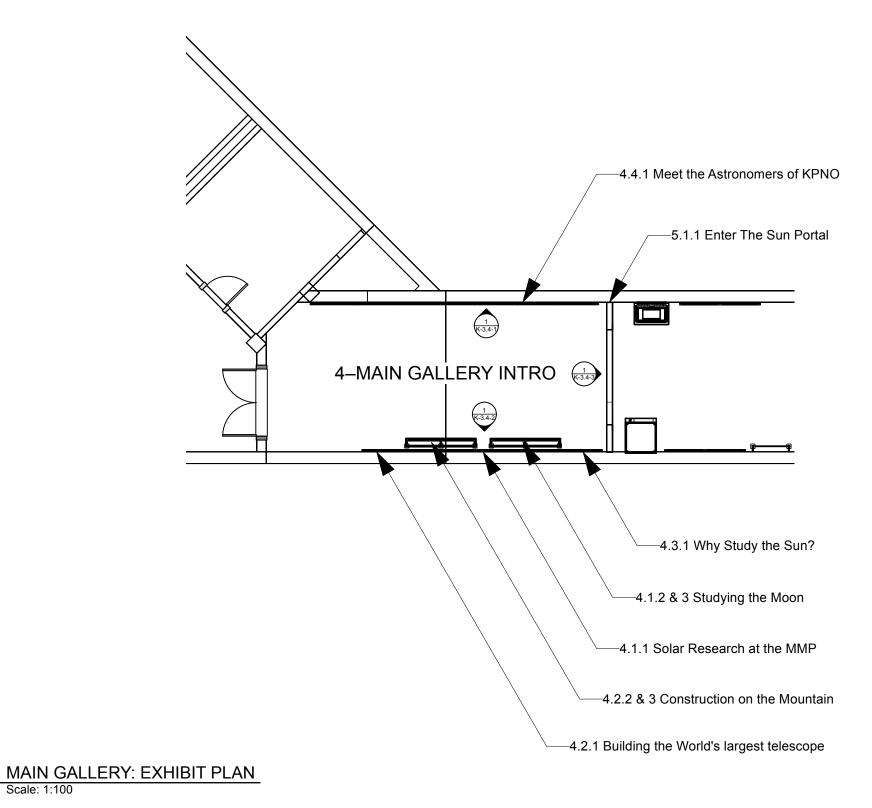Drawing

MAIN GALLERY: EXHIBIT PLAN


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K-2.4

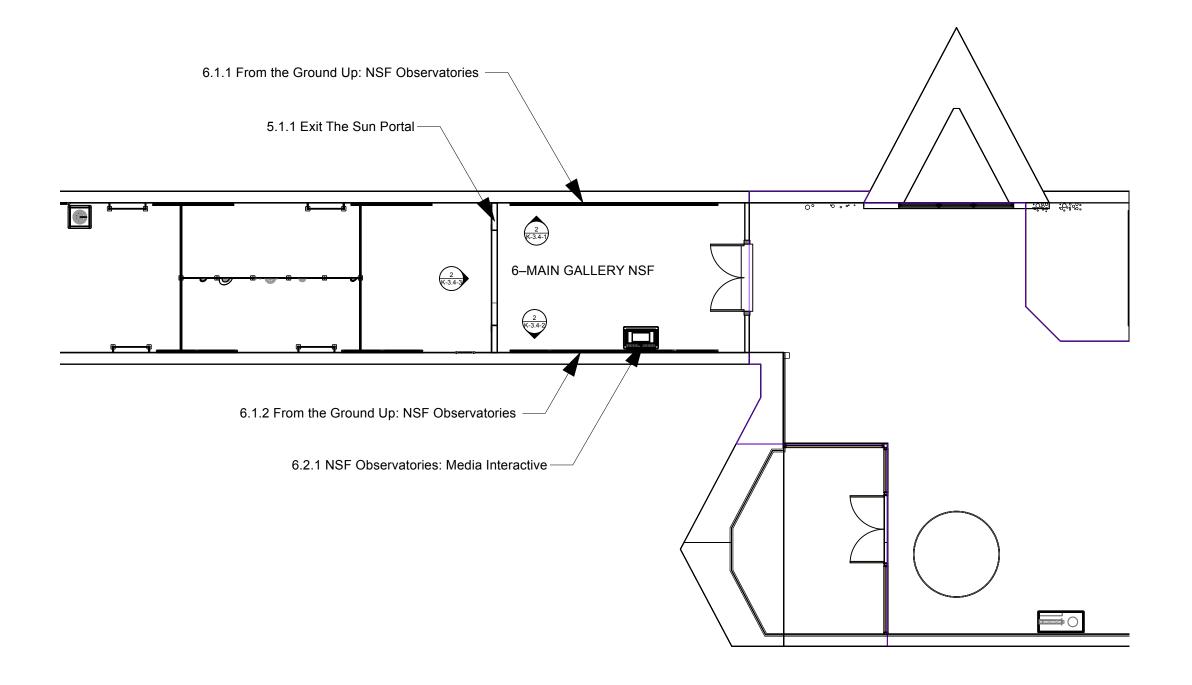

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CONTROL ROOM: EXHIBIT PLAN


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CONTROL ROOM: EXHIBIT PLAN

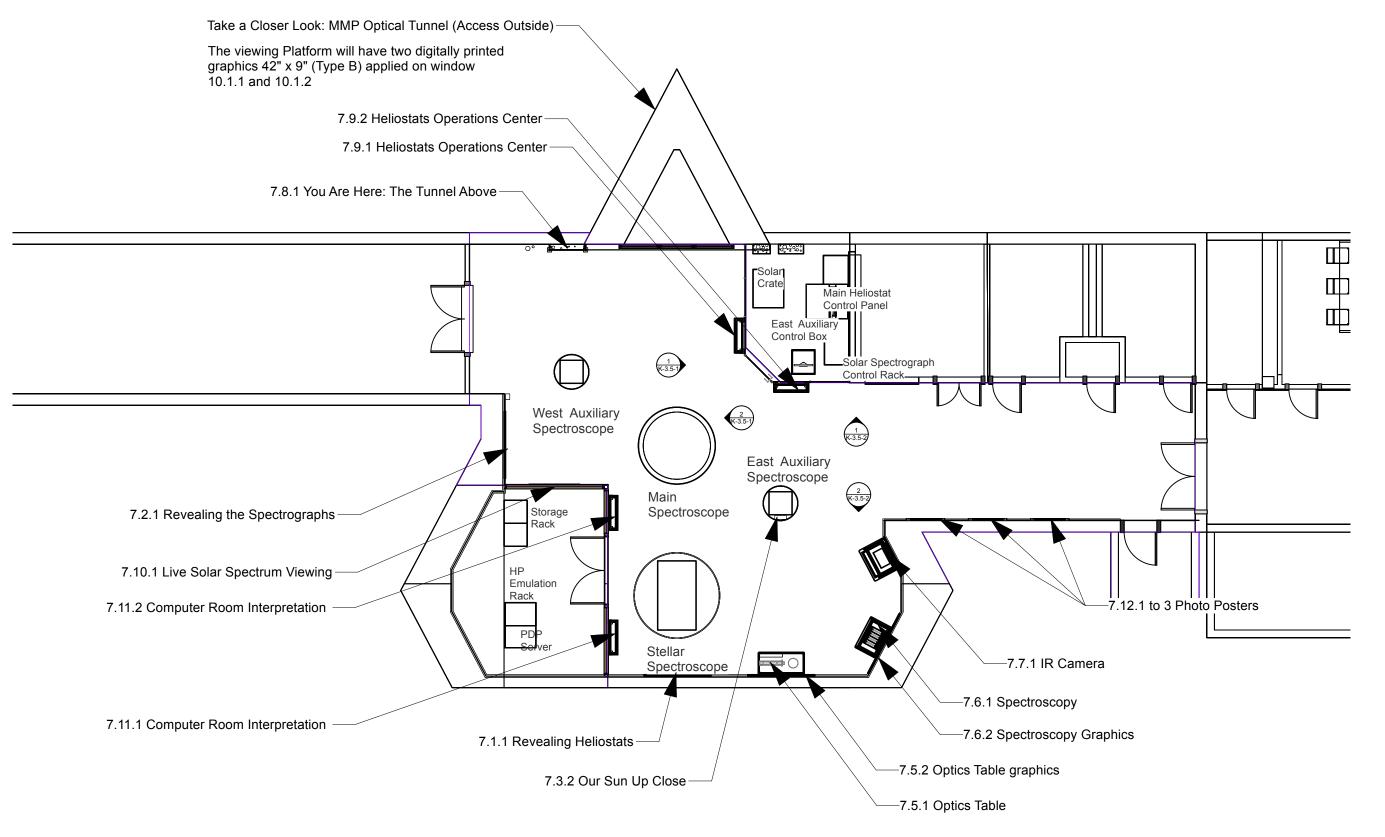

TON-SOS: EXHIBIT PLAN

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TON-SOS: EXHIBIT PLAN


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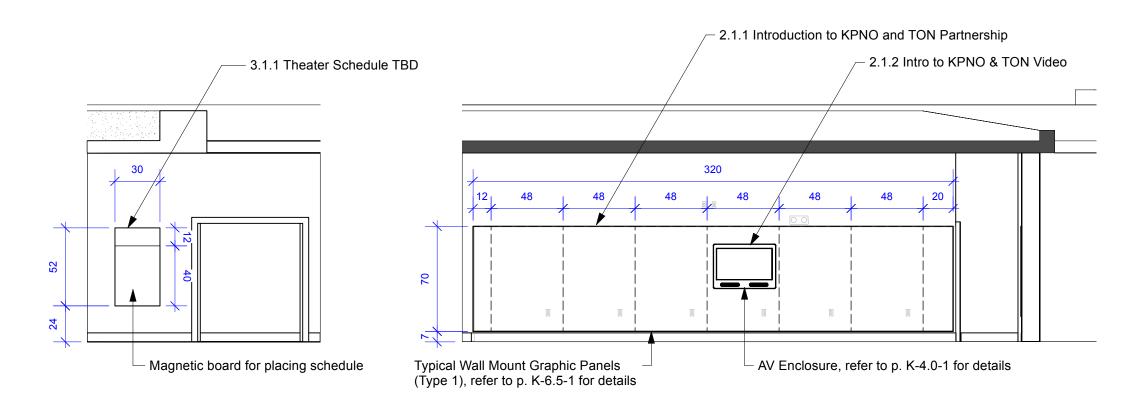
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North

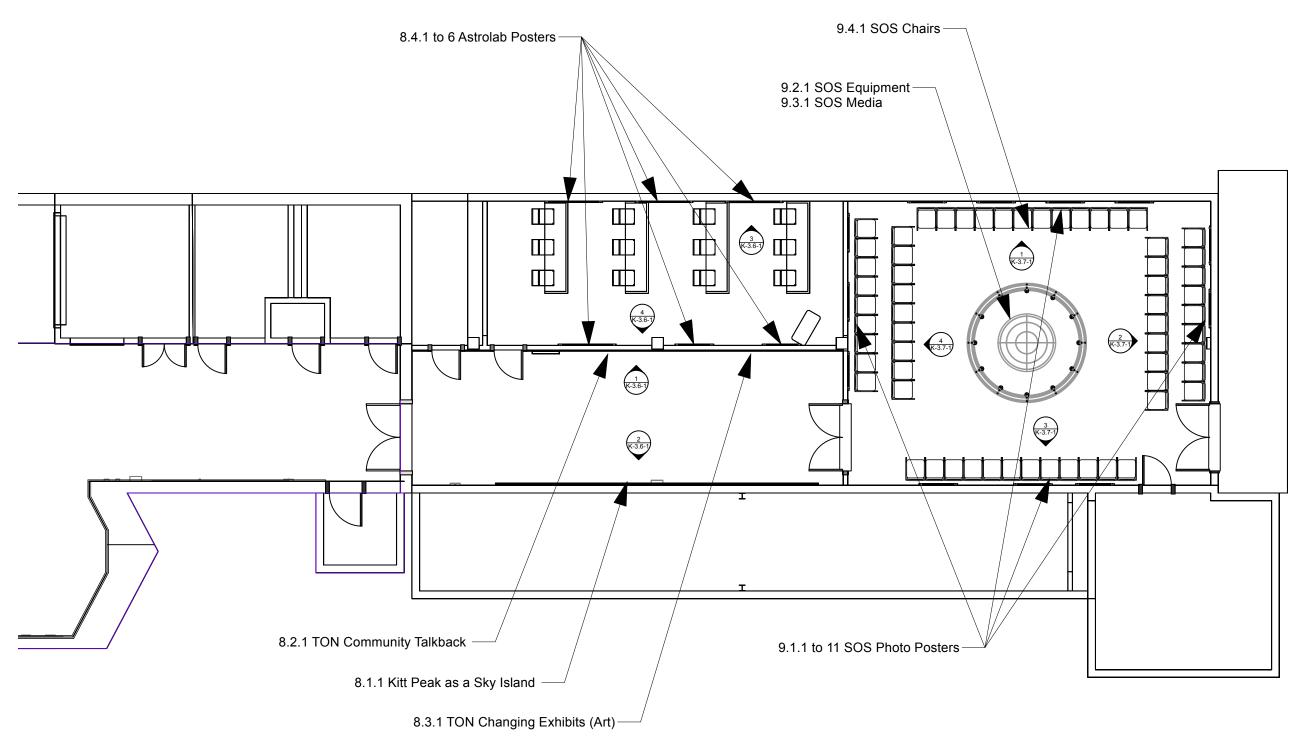K-2.6


Dwg No.



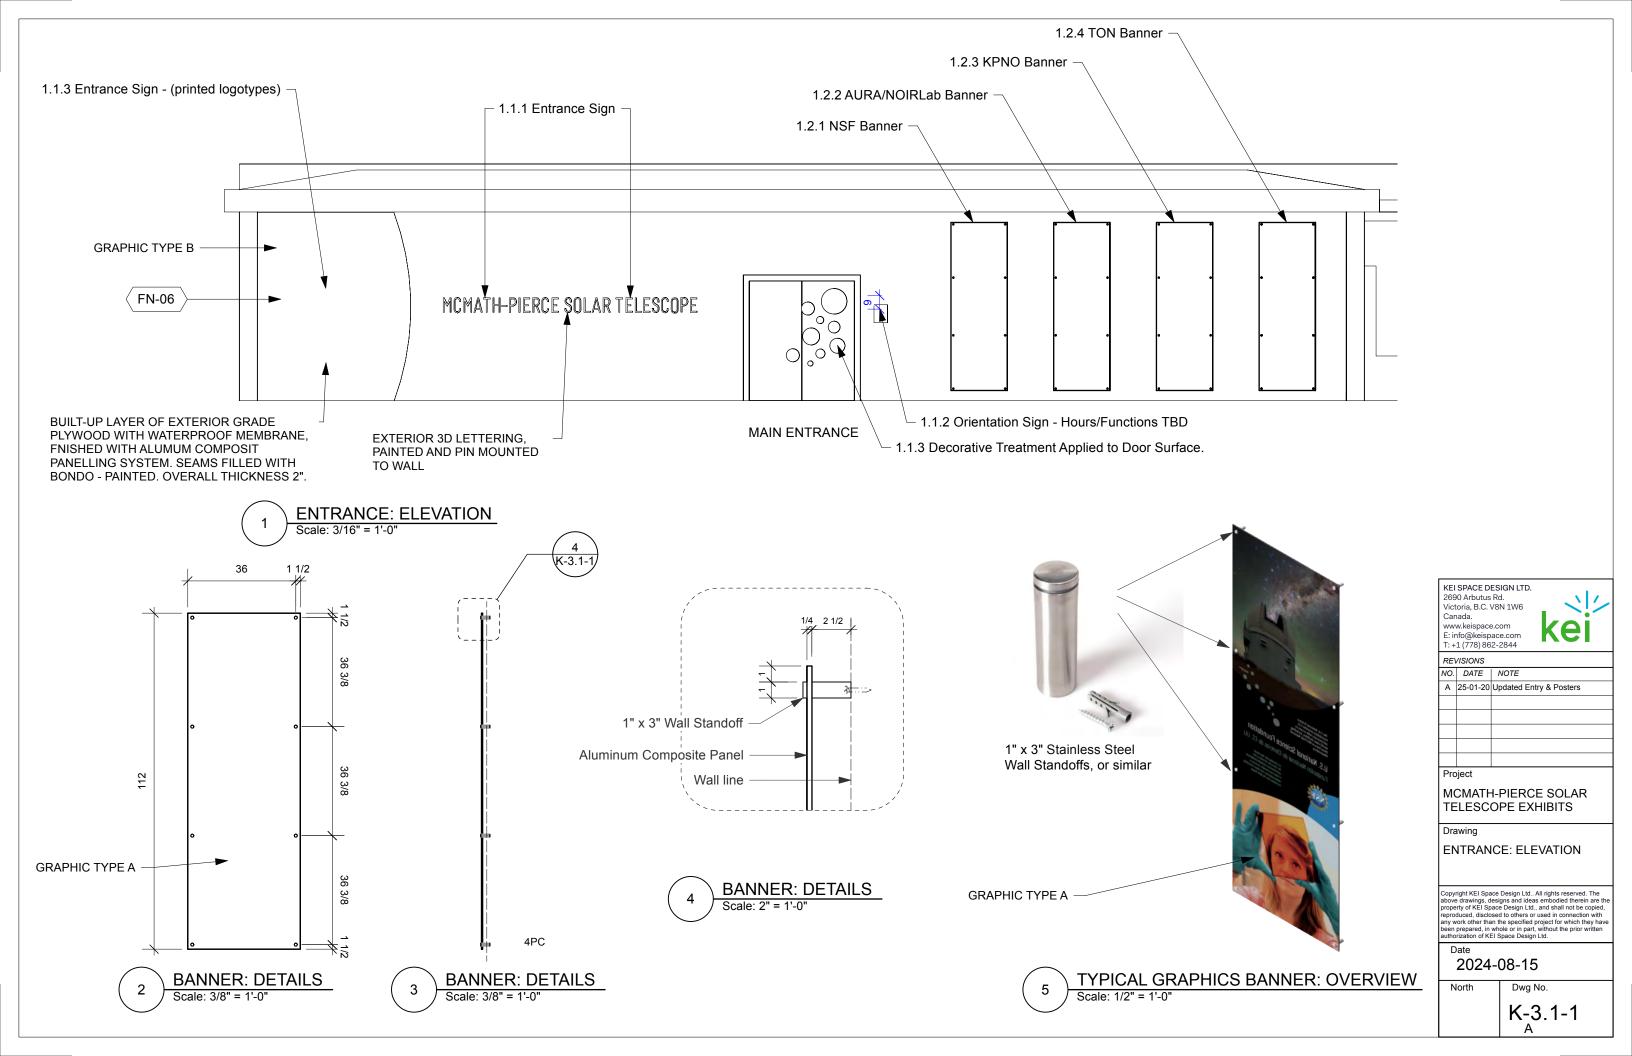

1 LOBBY: North Wall Elevation
Scale: 3/16" = 1'-0"

2 LOBBY: Welcome Mural Elevation
Scale: 3/16" = 1'-0"

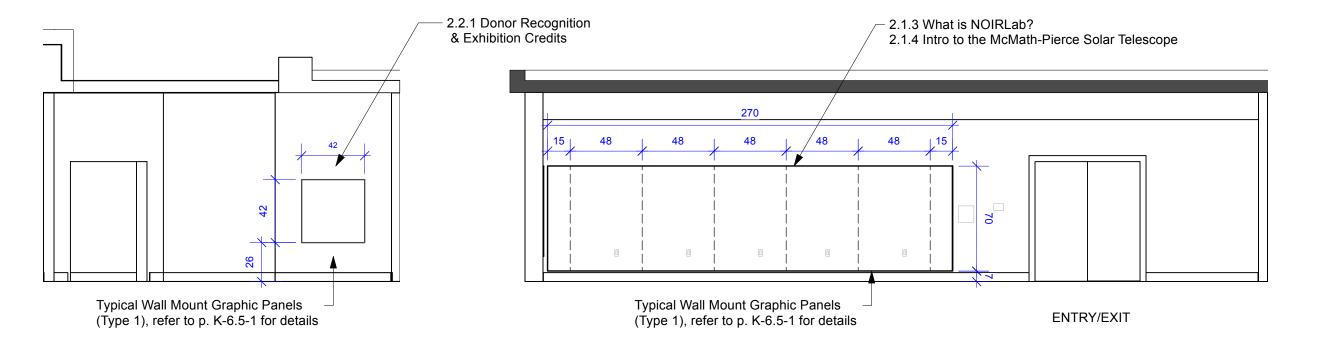

3 LOBBY: South-East Wall Elevation
Scale: 3/16" = 1'-0"

4 LOBBY: Intro Mural
Scale: 3/16" = 1'-0"

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MCMATH-PIERCE SOLAR
TELESCOPE EXHIBITS


Drawing
LOBBY: ELEVITIONS

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K-3.2-1

2024-08-15



1 LOBBY: Restrooms Wall Elevation
Scale: 3/16" = 1'-0"
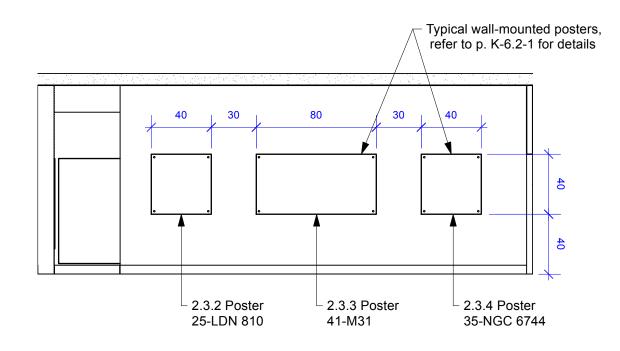
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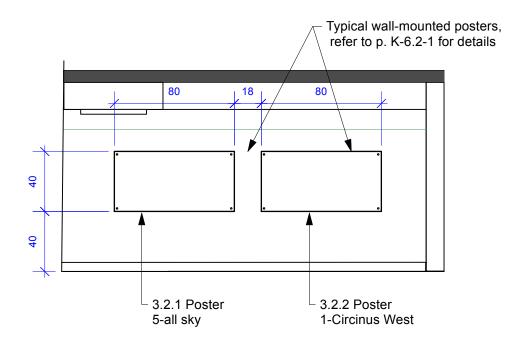
LOBBY: ELEVITIONS

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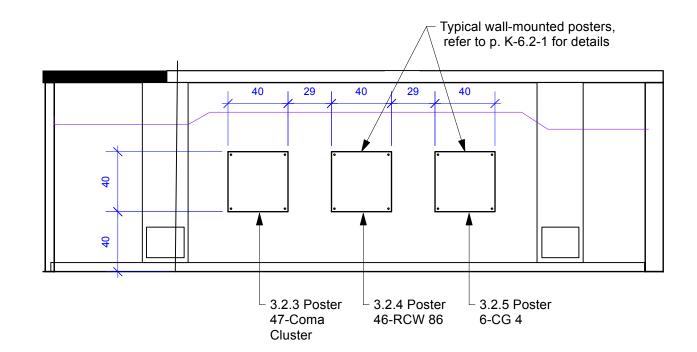
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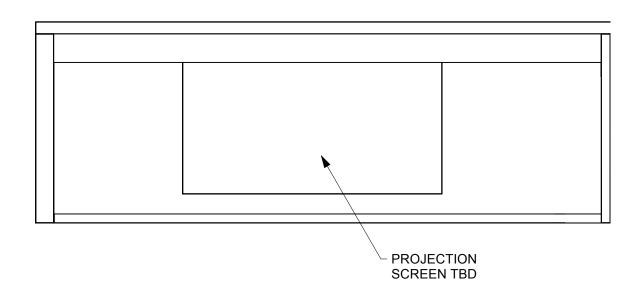
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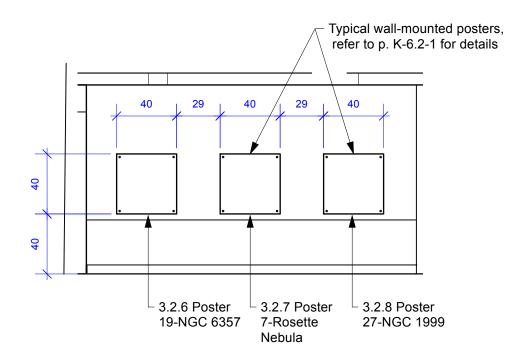
THEATER: Wall Elevation
Scale: 3/16" = 1'-0"



2 THEATER: Wall Elevation
Scale: 3/16" = 1'-0"



3 THEATER: Wall Elevation
Scale: 3/16" = 1'-0"



4 THEATER: Wall Elevation
Scale: 3/16" = 1'-0"

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THEATER: ELEVITIONS


Date 2024-08-15


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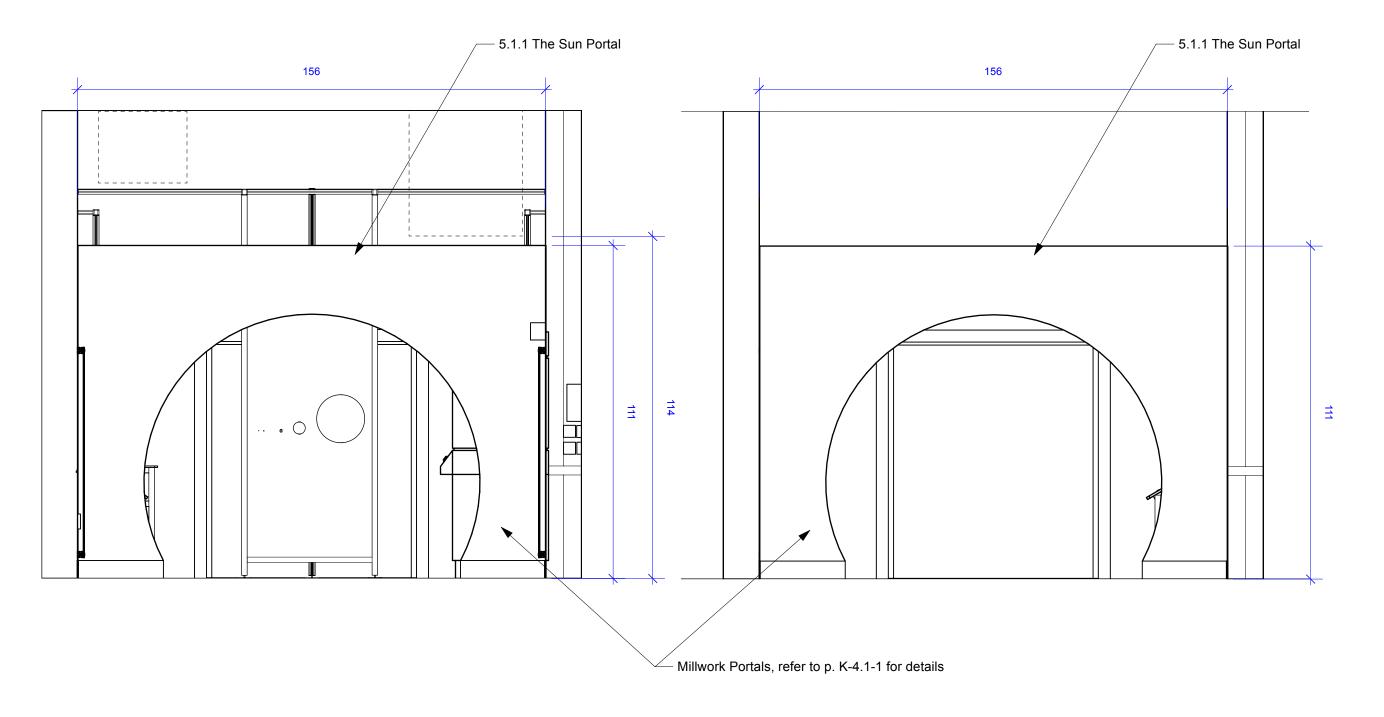
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MAIN GALLERY ENTRANCE: WEST ELEVATION
Scale: 3/8" = 1'-0"

2 MAIN GALLERY EXIT: WEST ELEVATION
Scale: 3/8" = 1'-0"

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MAIN GALLERY: WEST ELEVATION

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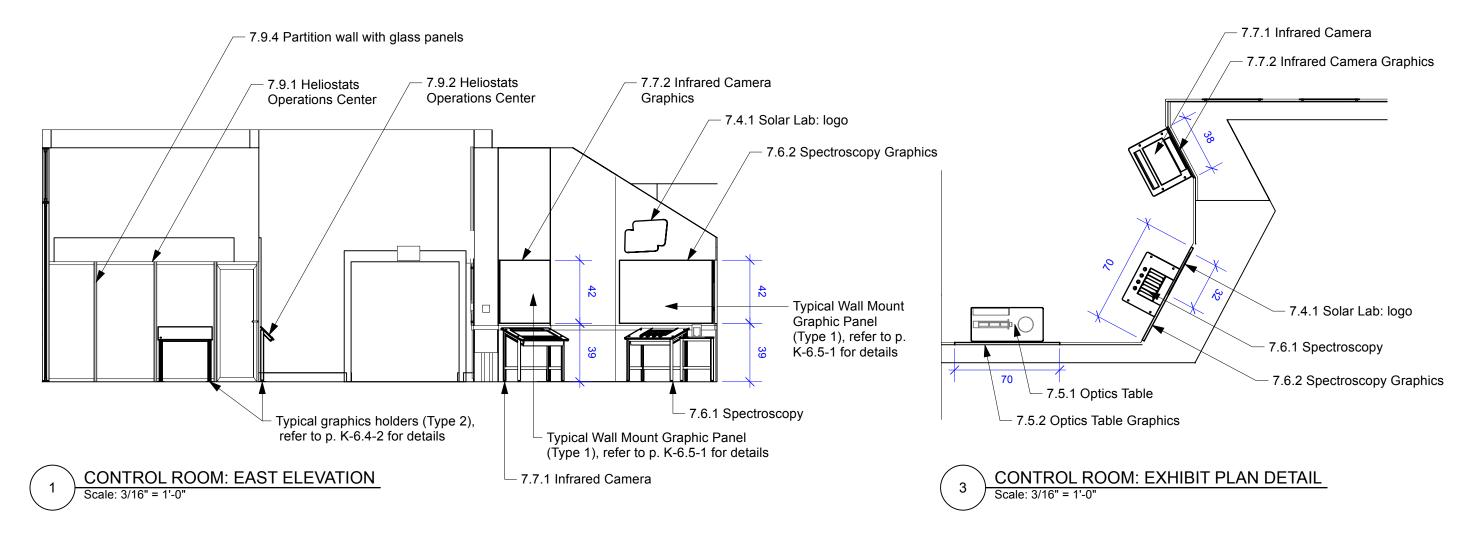
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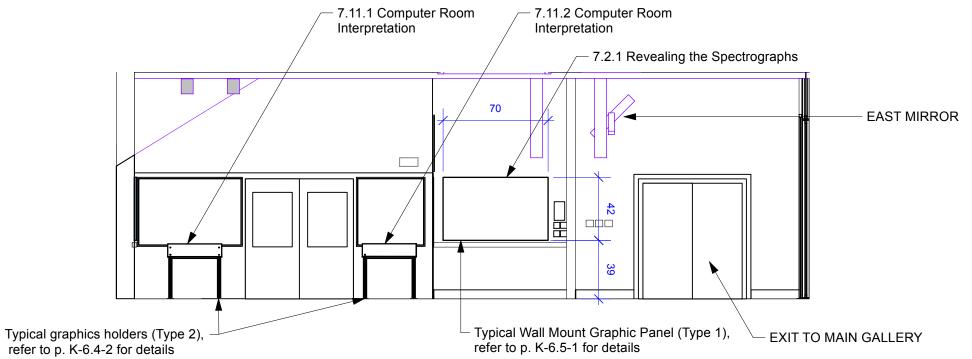
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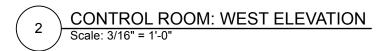
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K-3.4-3

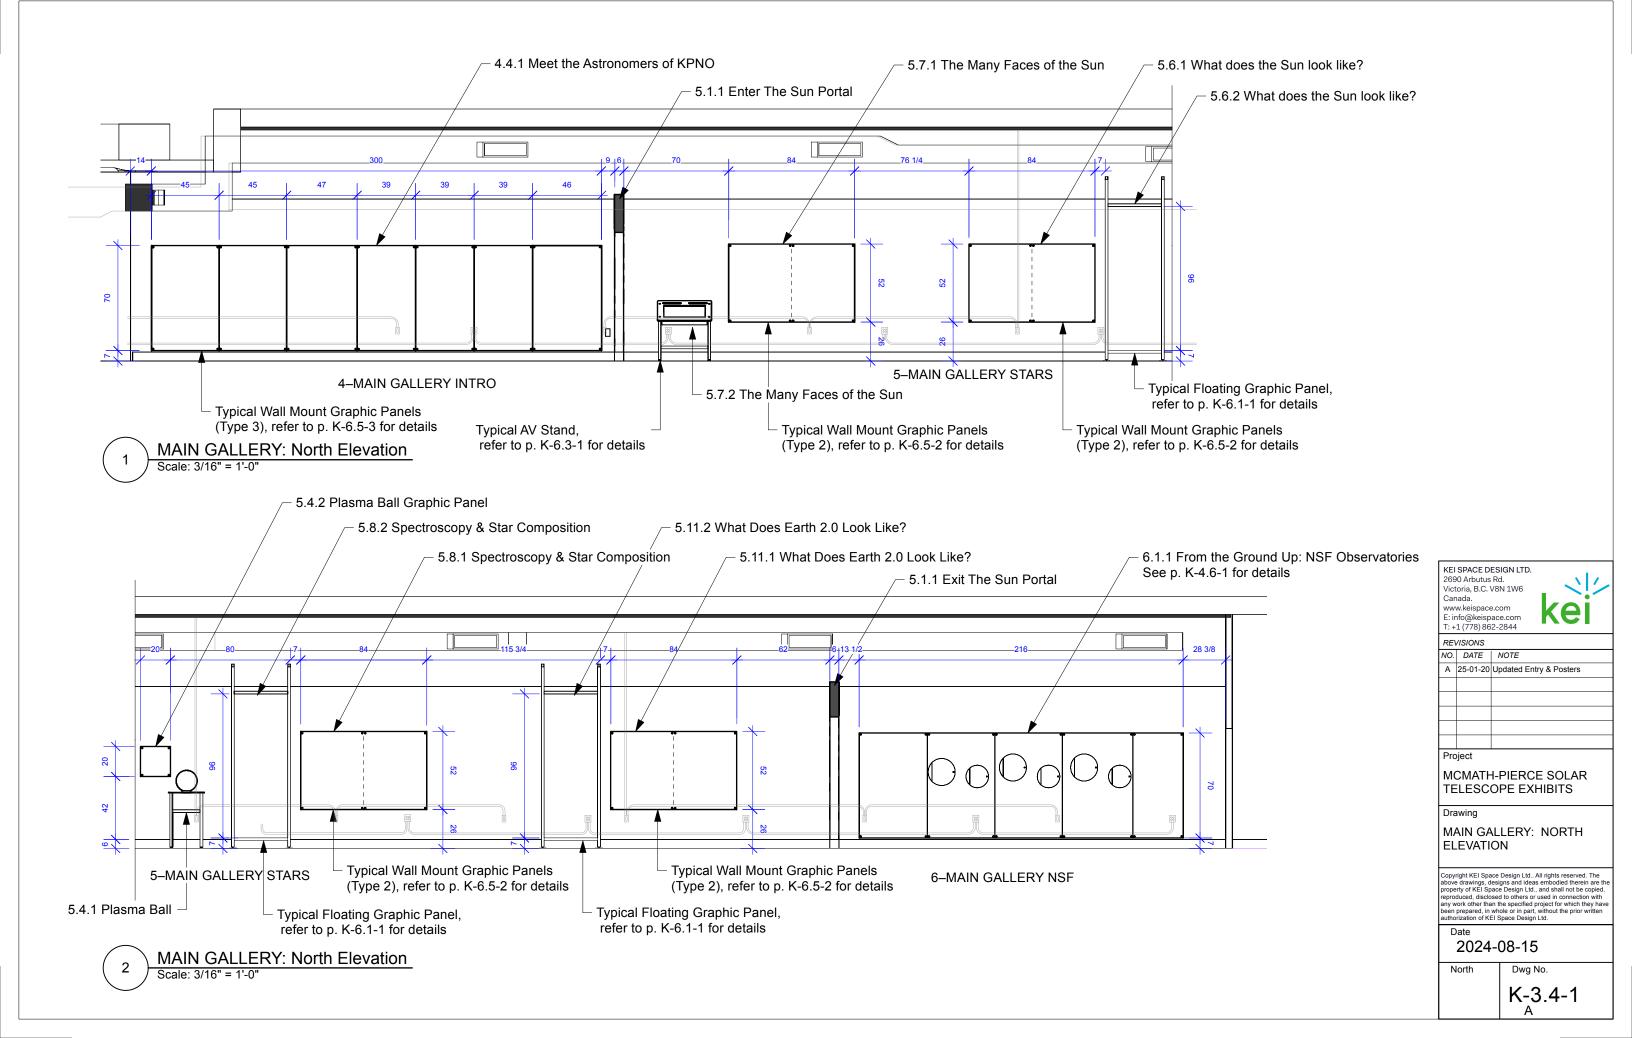

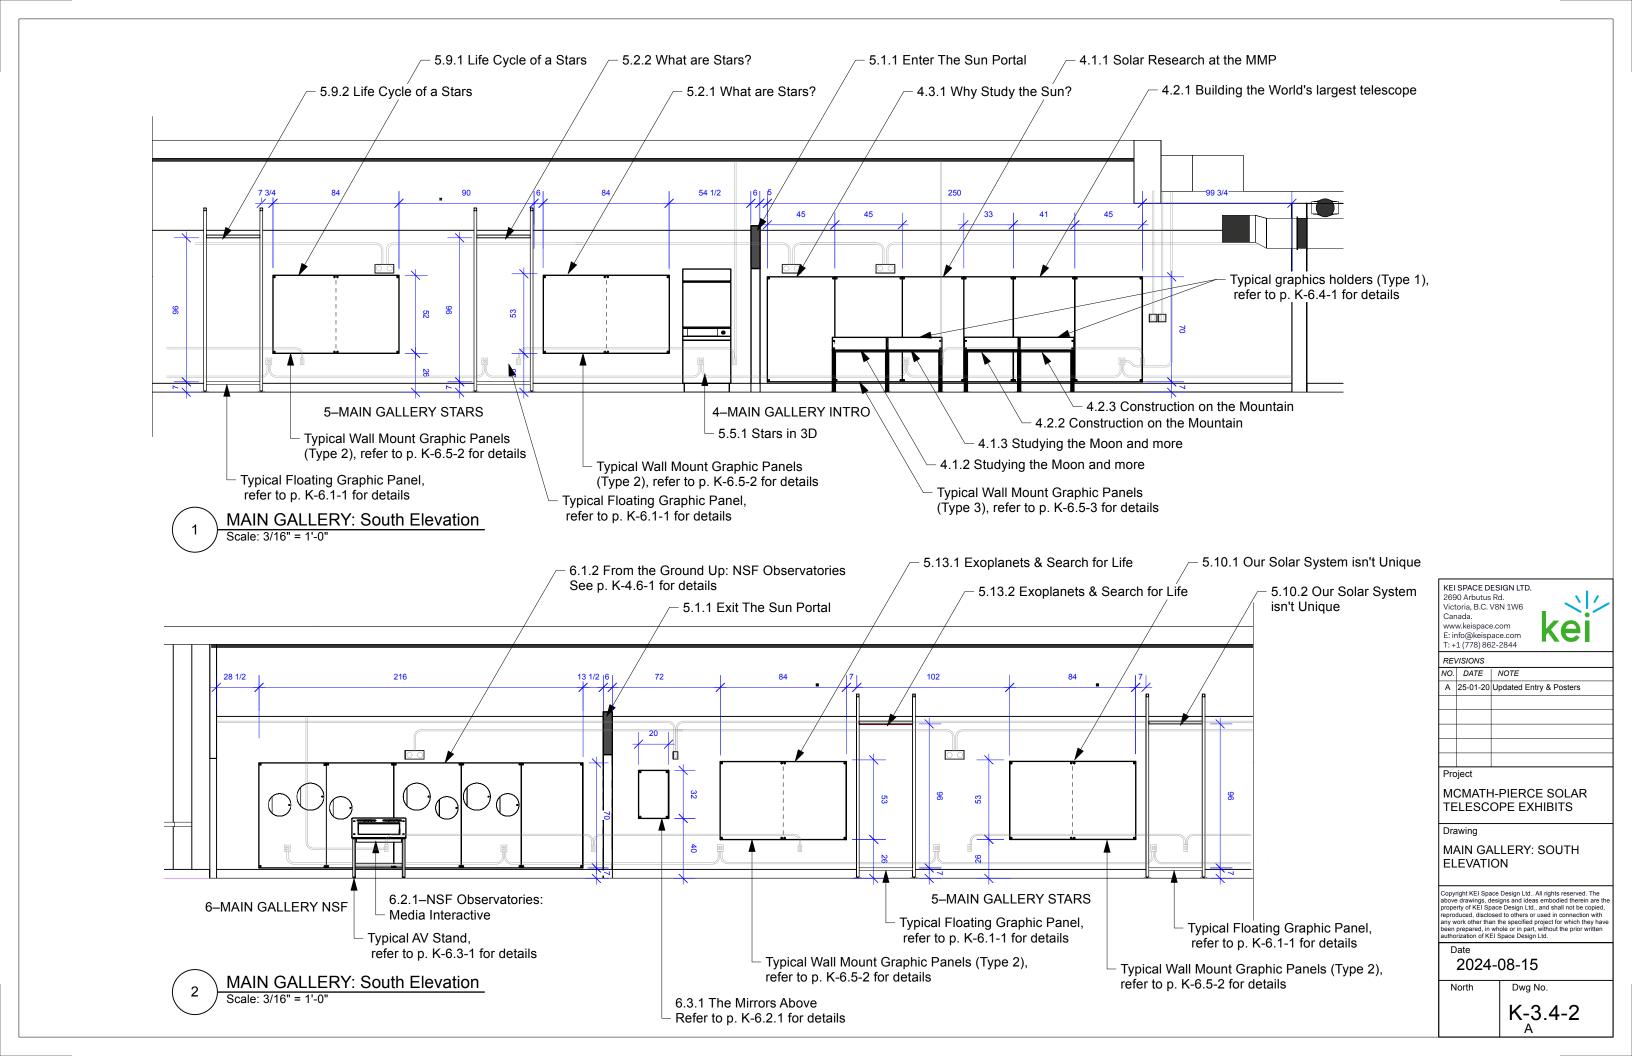



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CONTROL ROOM:
EAST/WEST


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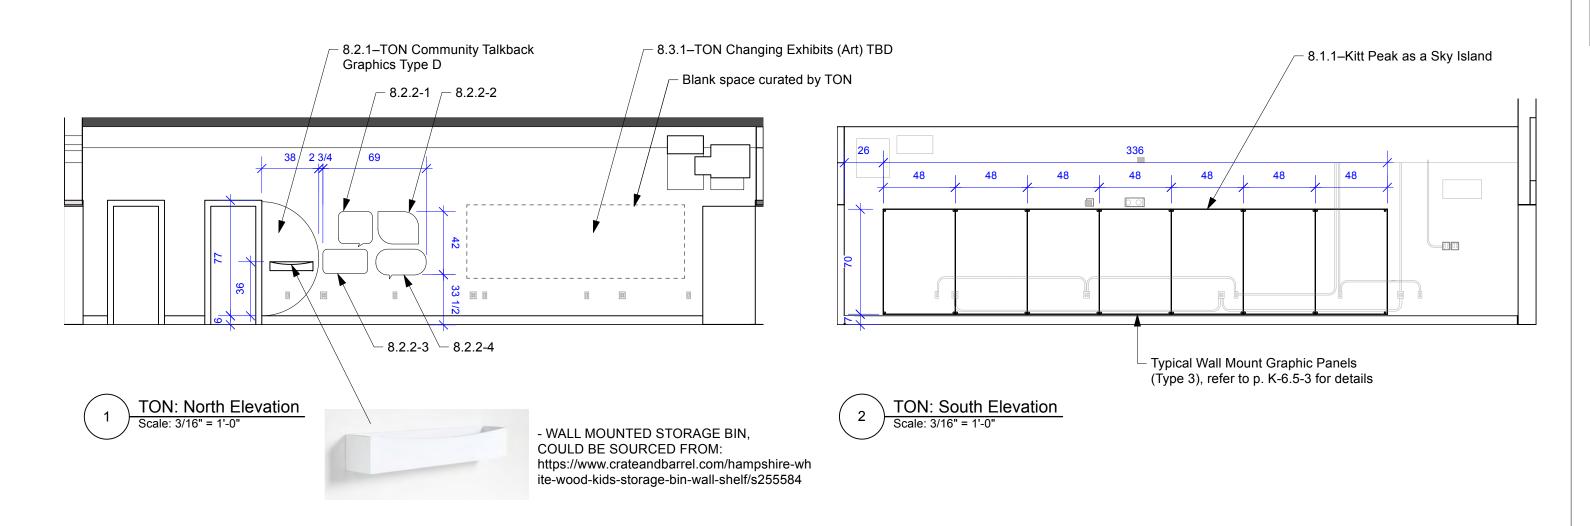
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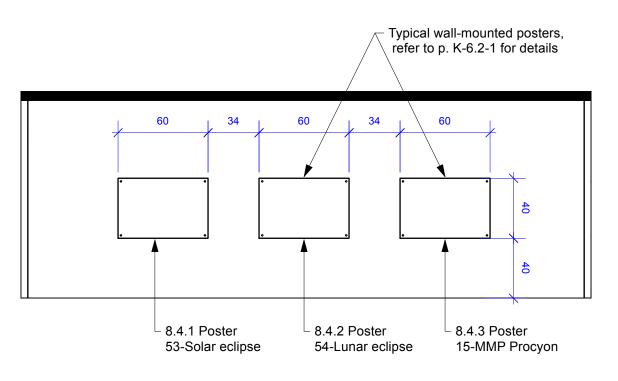
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K-3.5-1

North






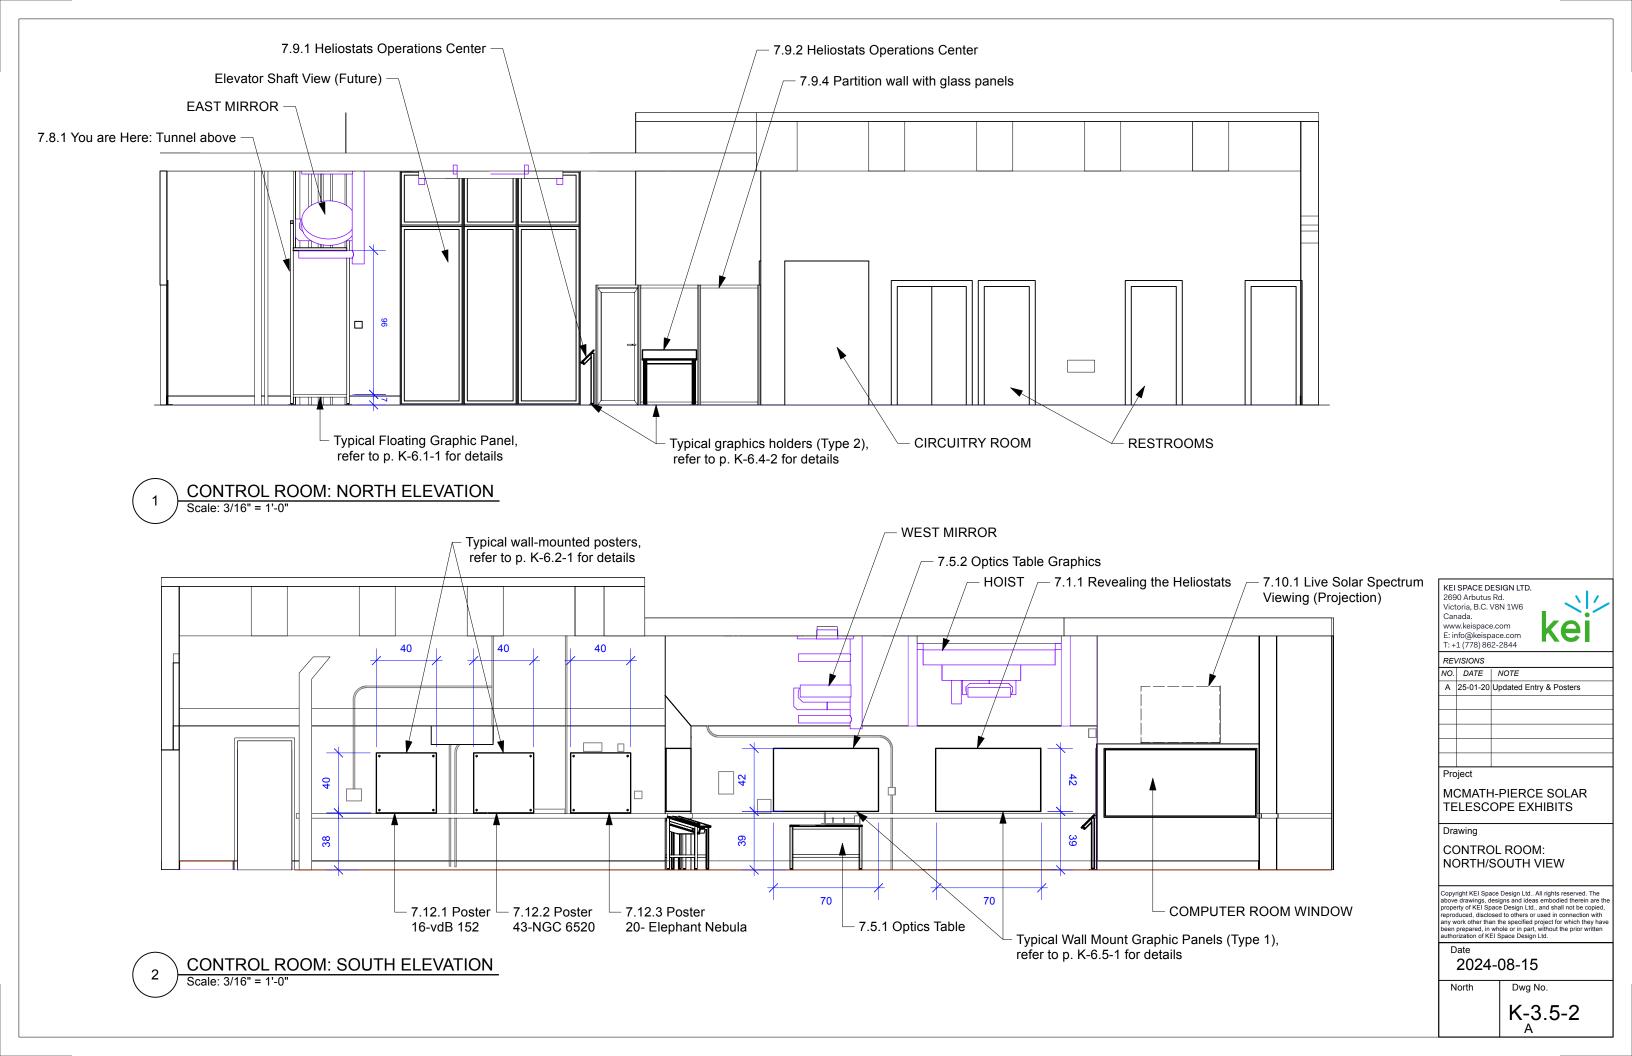

**ASTROLAB: Nort Wall Elevation** 

Scale: 3/16" = 1'-0"

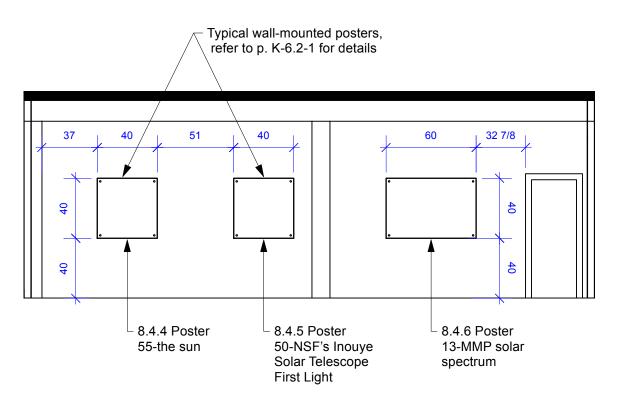

ASTROLAB: South Wall Elevation
Scale: 3/16" = 1'-0"

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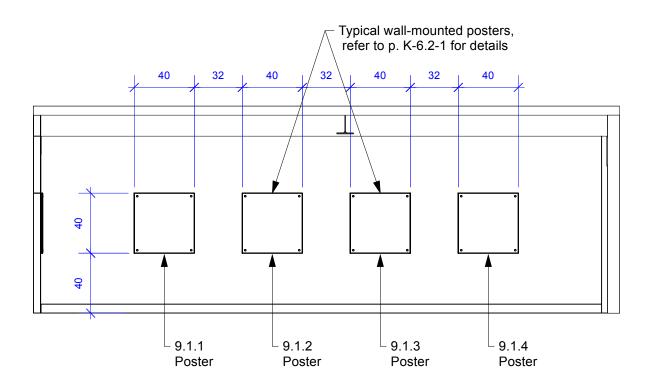
TON: ELEVATIONS


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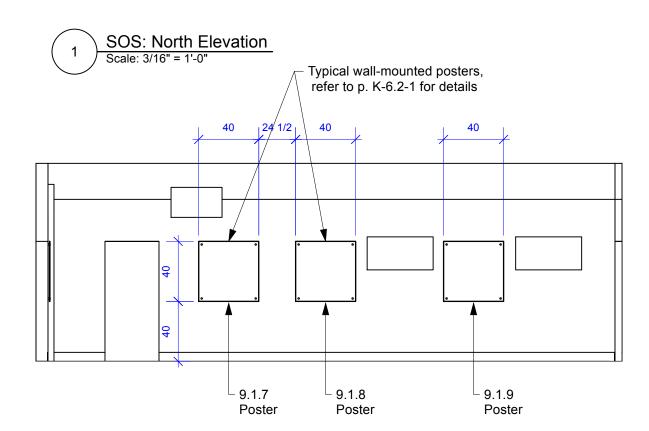
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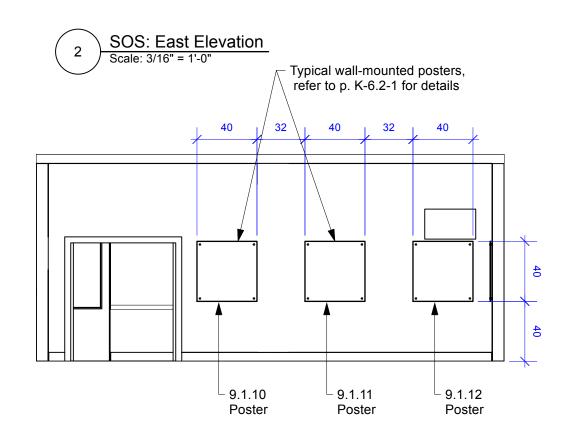
K-3.6-1







SOS: South Elevation
Scale: 3/16" = 1'-0"

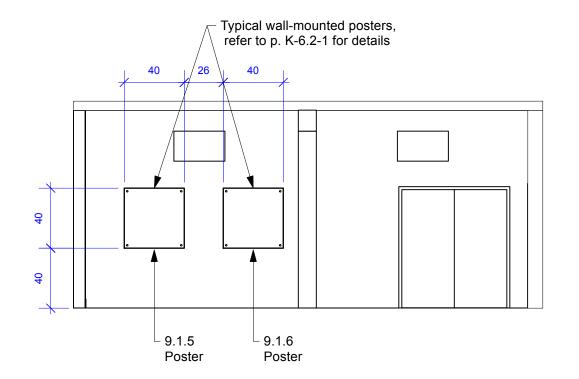

SOS: West Elevation
Scale: 3/16" = 1'-0"

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TELESCOPE EXHIBITS

Drawing
SOS: ELEVATIONS


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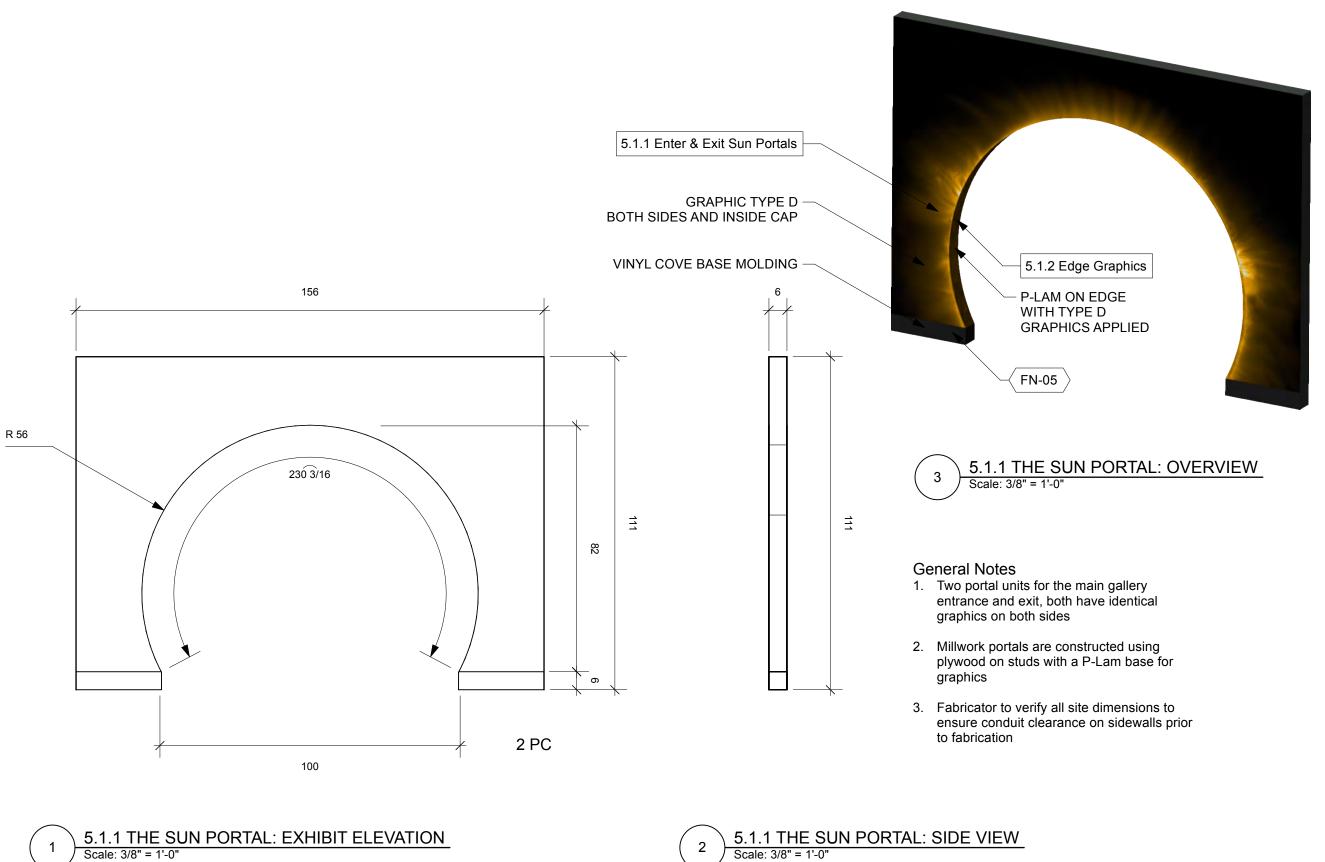
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North

Dwg No.
K-3.7-1





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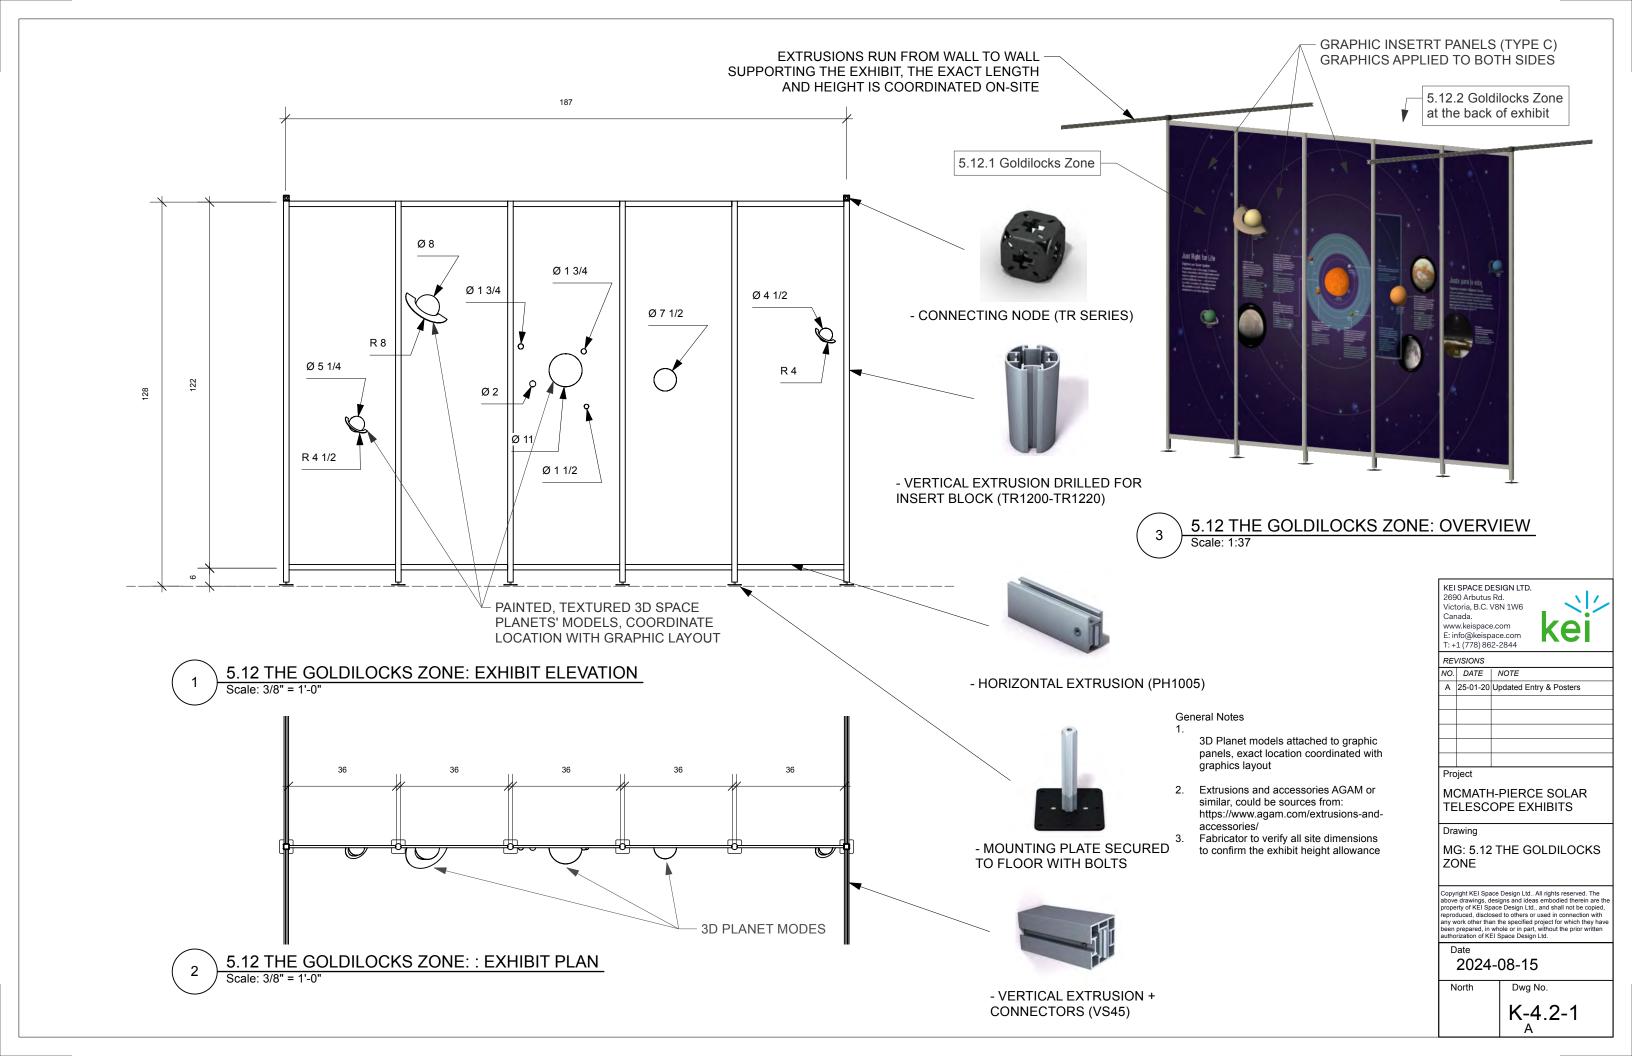
MG: 5.1.1 THE SUN PORTAL

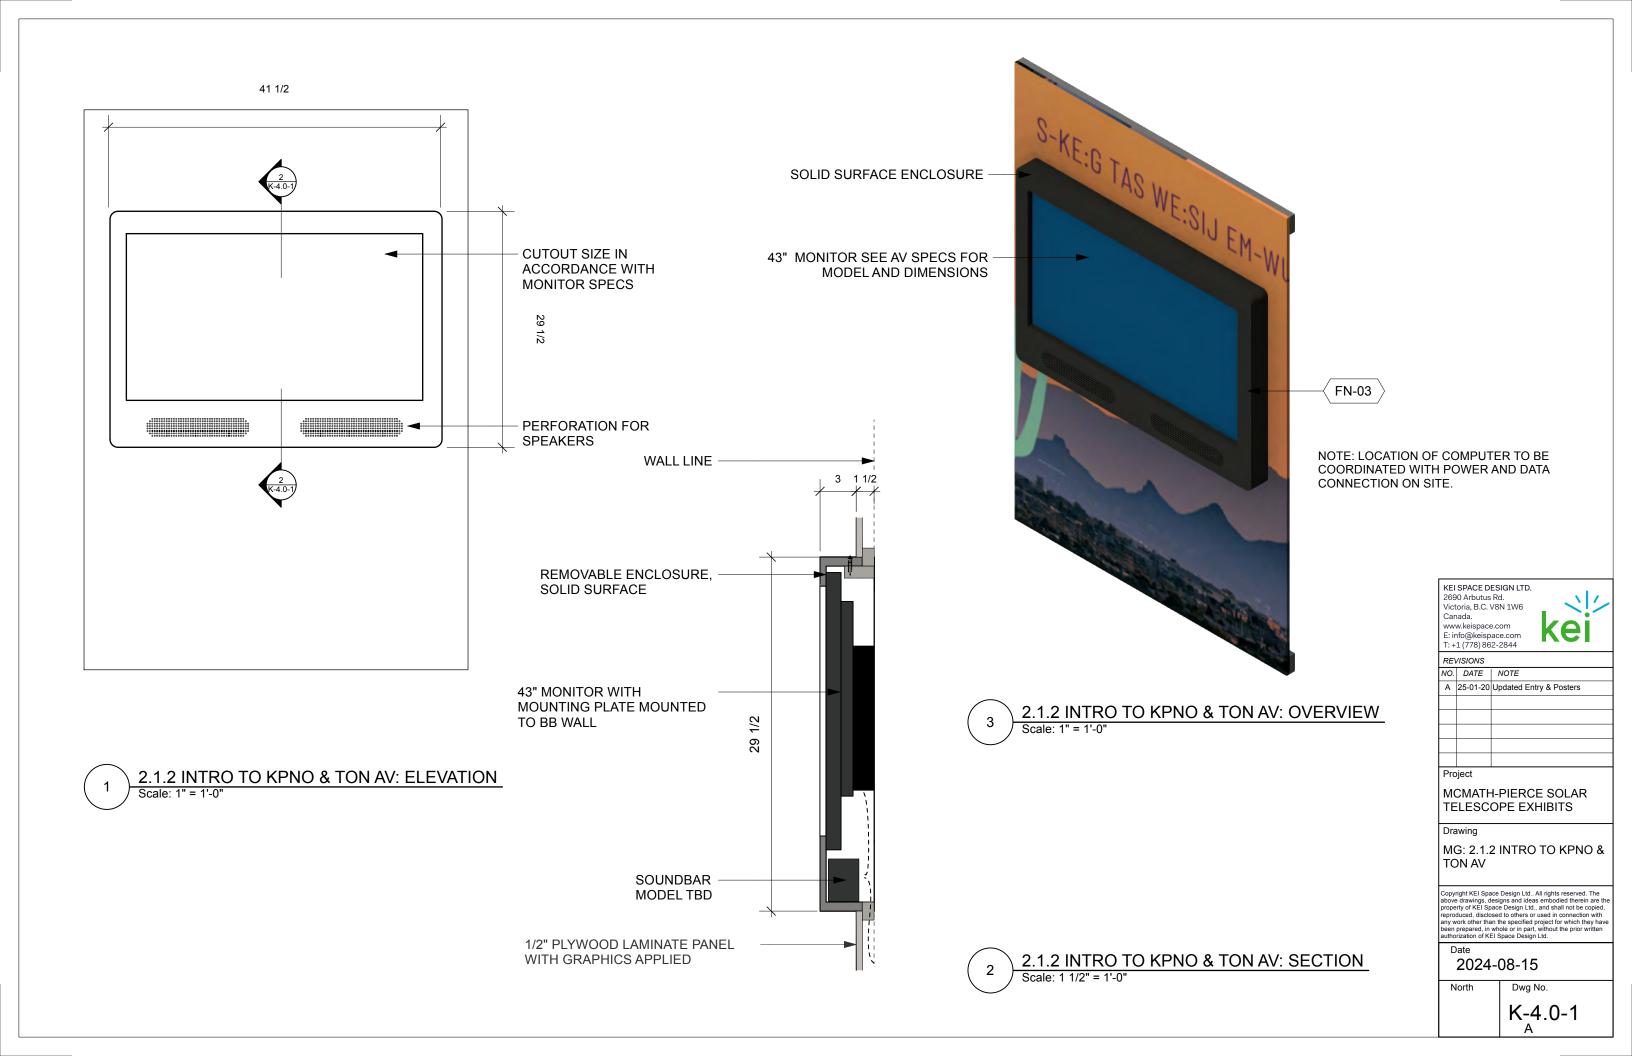
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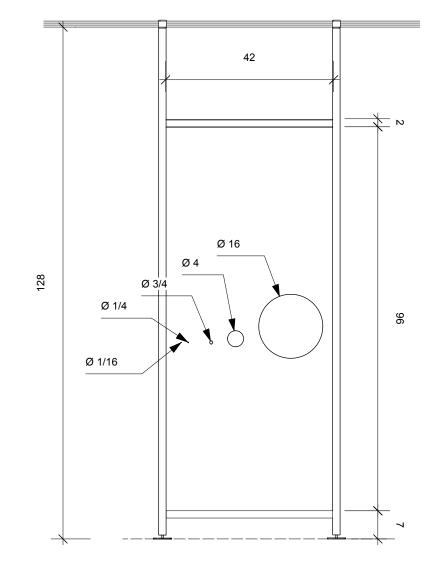
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K-4.1-1








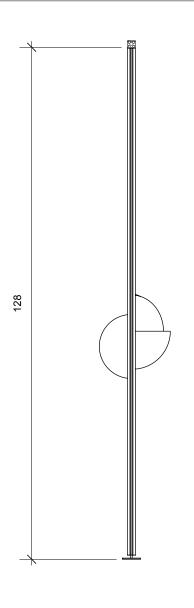

5.3.1 TYPE OF STARS: EXHIBIT PLAN
Scale: 1/2" = 1'-0"

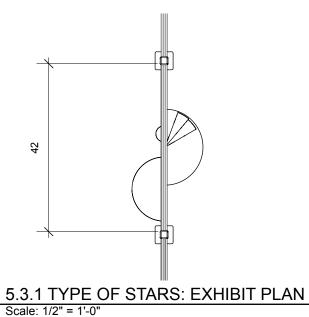

5.3.1 TYPE OF STARS: EXHIBIT ELEVATION

General Notes

- 1. Extrusions and accessories AGAM or similar, could be sources from: https://www.agam.com/extrusions-andaccessories/
- 2. Fabricator to verify all site dimensions to confirm the exhibit height allowance

- VERTICAL EXTRUSION DRILLED FOR INSERT BLOCK (TR1100)

- HORIZONTAL EXTRUSION (PH1005)

- MOUNTING PLATE SECURED TO FLOOR WITH BOLTS

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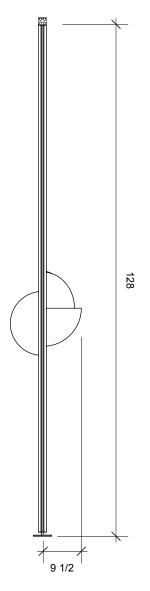
MG: 5.3 TYPE OF STARS

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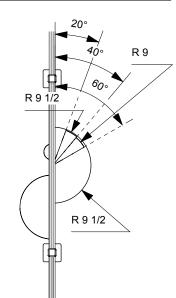
2024-08-15

Dwg No.

K-4.3-1



5.3.1 TYPE OF STARS: SIDE VIEW
Scale: 1/2" = 1'-0"



5.3.1 TYPE OF STARS: EXHIBIT ELEVATION (BACK)
Scale: 1/2" = 1'-0"

See p. K-4.3-1 for structure details **GRAPHIC TYPE C** 5.3.2 Type of stars Painted, textured 3D Star model, coordinate location with graphic layout 5.3.3 Type of stars Graphics applied on 3D model sections

1. Extrusions and accessories AGAM or similar, could be sources from: https://www.agam.com/extrusions-andaccessories/

2. Fabricator to verify all site dimensions to confirm the exhibit height allowance

5.3.1 TYPE OF STARS: REAR OVERVIEW
Scale: 1/2" = 1'-0"

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MG: 5.3 TYPE OF STARS


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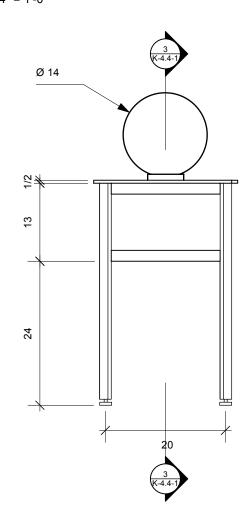
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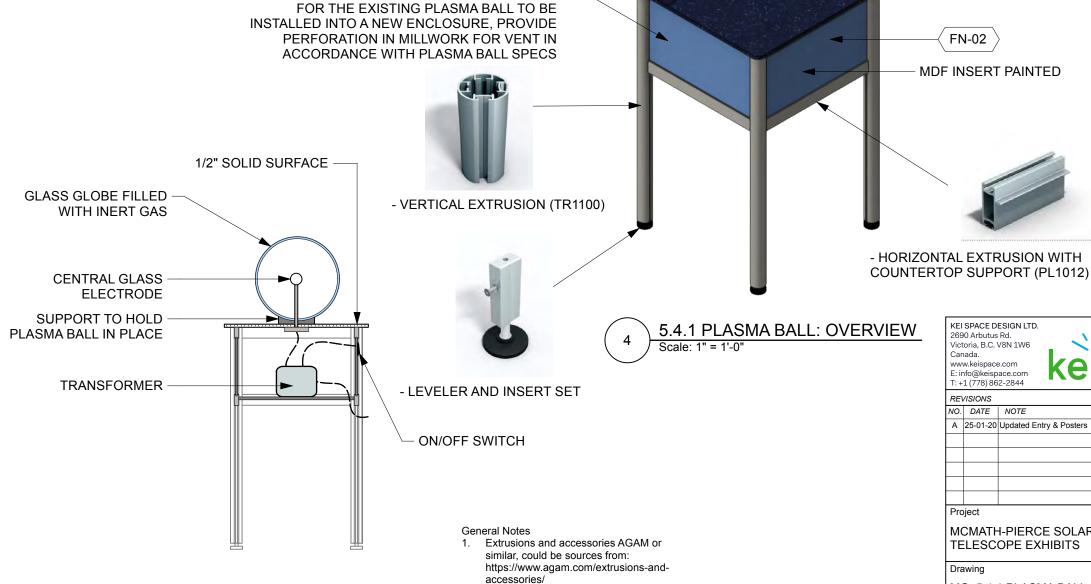
Dwg No. K-4.3-2

5.3.1 TYPE OF STARS: EXHIBIT PLAN Scale: 1/2" = 1'-0"



5.4.1 PLASMA BALL: EXHIBIT PLAN Scale: 3/4" = 1'-0"



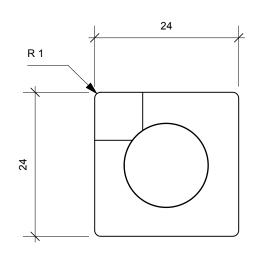

**EXISTING PLASMA BALL EXHIBIT** 

5.4.2 Plasma Ball

REMOVABLE SOLID SURFACE

**EXTRUSION WITH HIDDEN SCREWS** 

**FABRICATOR TO CONFIRM REQUIREMENTS** 

COUNTERTOP, SECURED TO

5.4.1 PLASMA BALL: EXHIBIT ELEVATION Scale: 3/4" = 1'-0"

5.4.1 PLASMA BALL: SECTION Scale: 3/4" = 1'-0"

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- HORIZONTAL EXTRUSION

(PH1005) UNDERNEATH

COUNTERTOP

FN-05

FN-02

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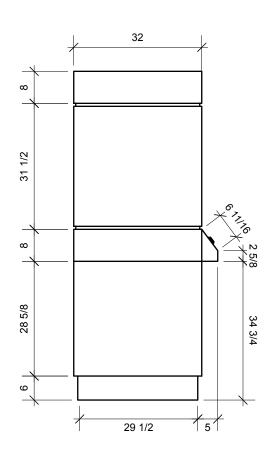
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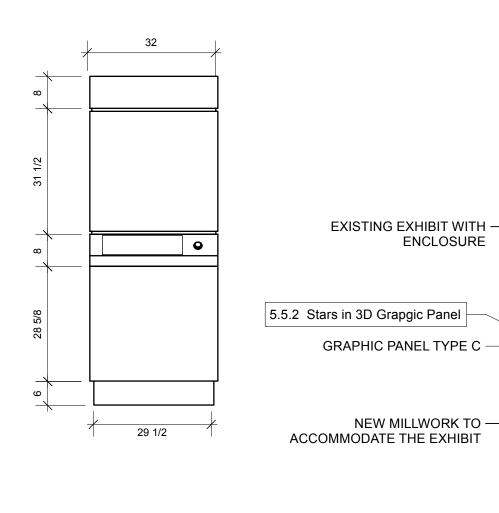
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FN-01

FN-02

FN-05

PROVIDE ACCESS INSIDE MILLWORK TO

SERVICE EQUIPMENT

5.5.1 STARS IN 3D: EXHIBIT ELEVATION Scale: 1/2" = 1'-0"

5.5.1 STARS IN 3D: EXHIBIT ELEVATION Scale: 1/2" = 1'-0"

32 BUTTON TO ROTATE ACTIVATE EXHIBIT 32

5.5.1 STARS IN 3D: OVERVIEW
Scale: 1:15

0

5.5.1 STARS IN 3D: PLAN Scale: 1/2" = 1'-0"

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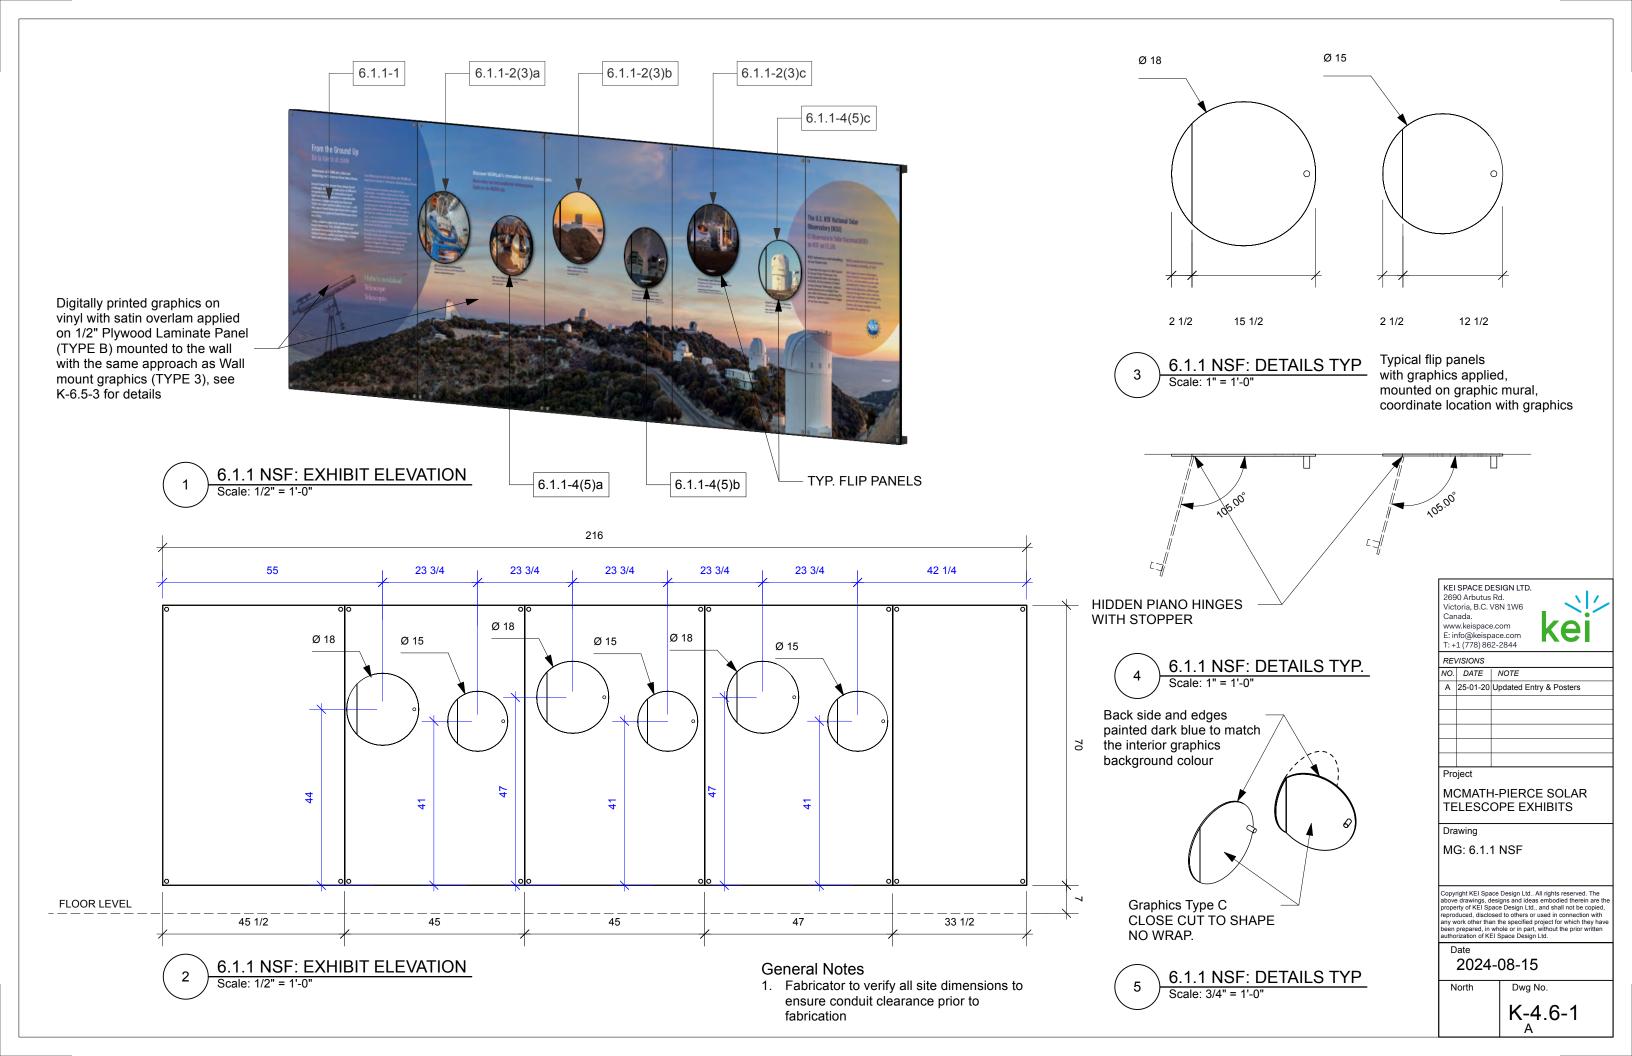
MG: 5.5.1 STARS IN 3D


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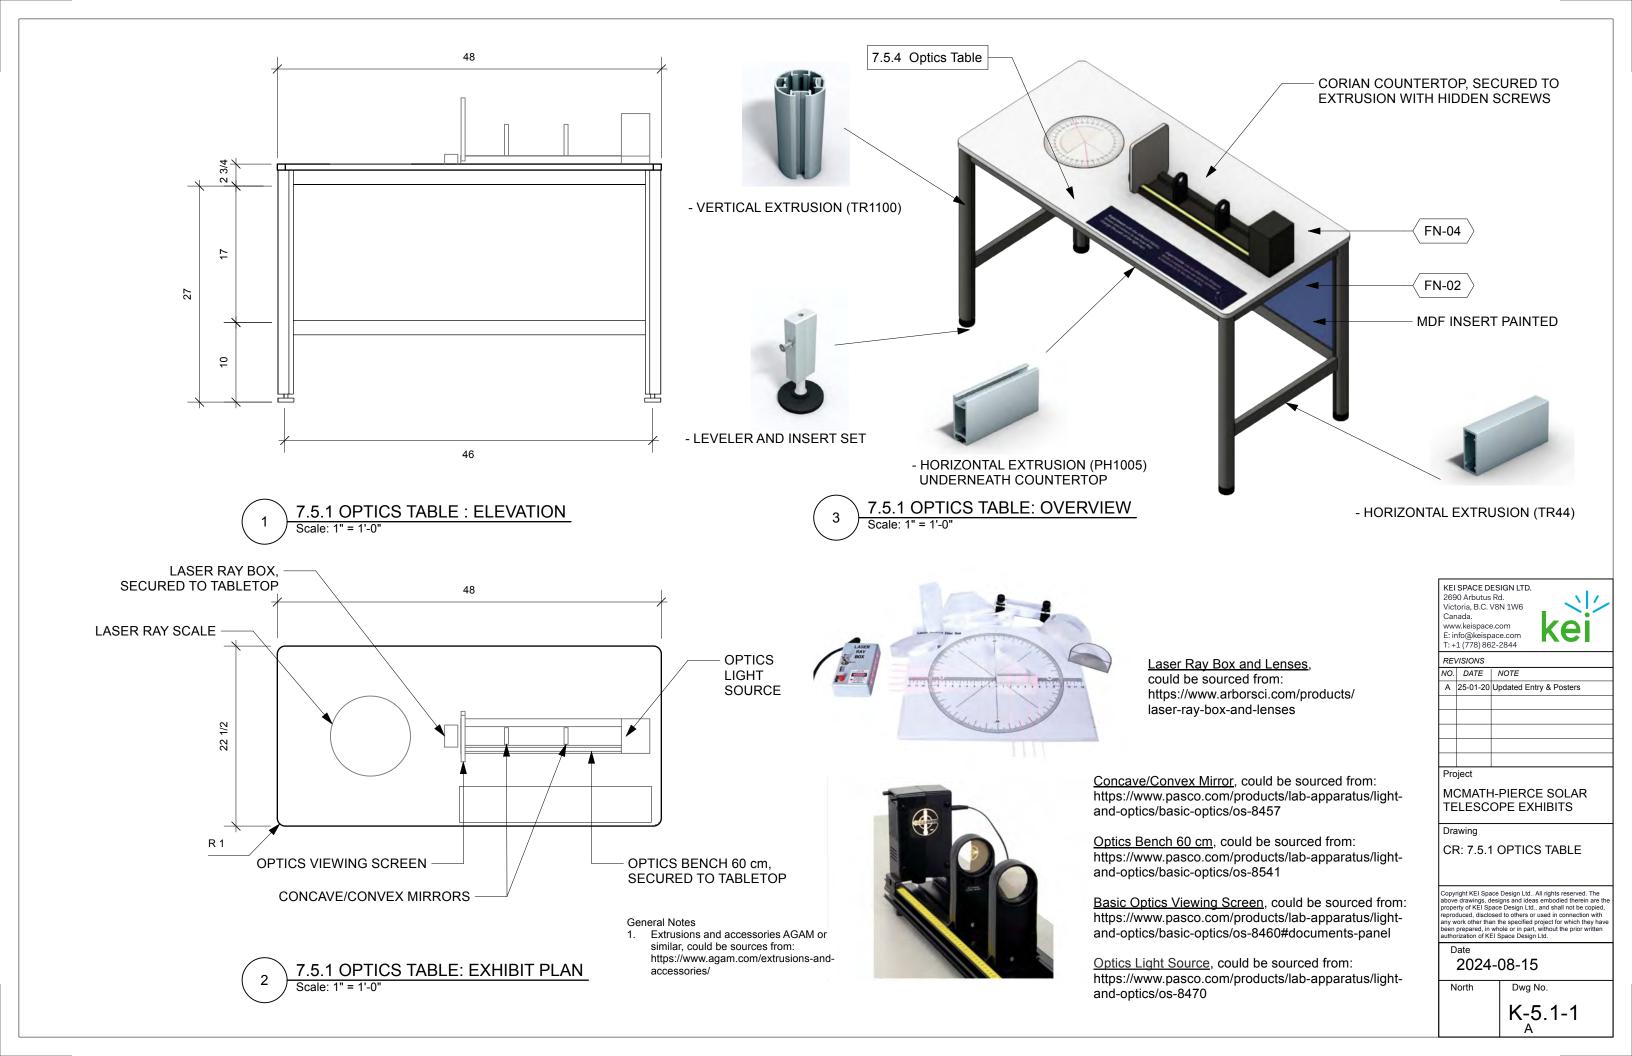
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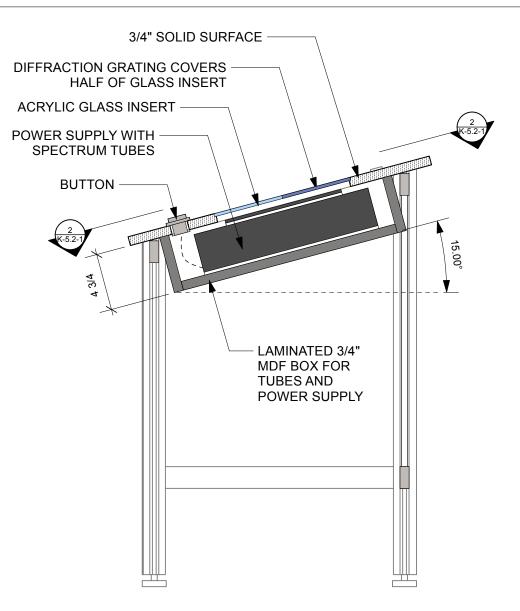
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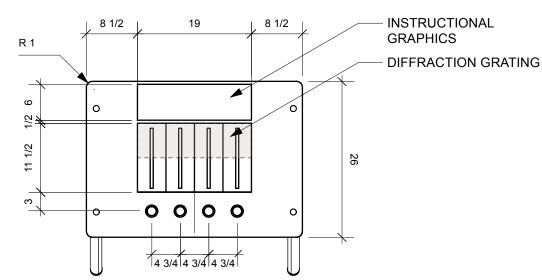









7.6.1 SPECTROSCOPY : SECTION
Scale: 1 1/2" = 1'-0"

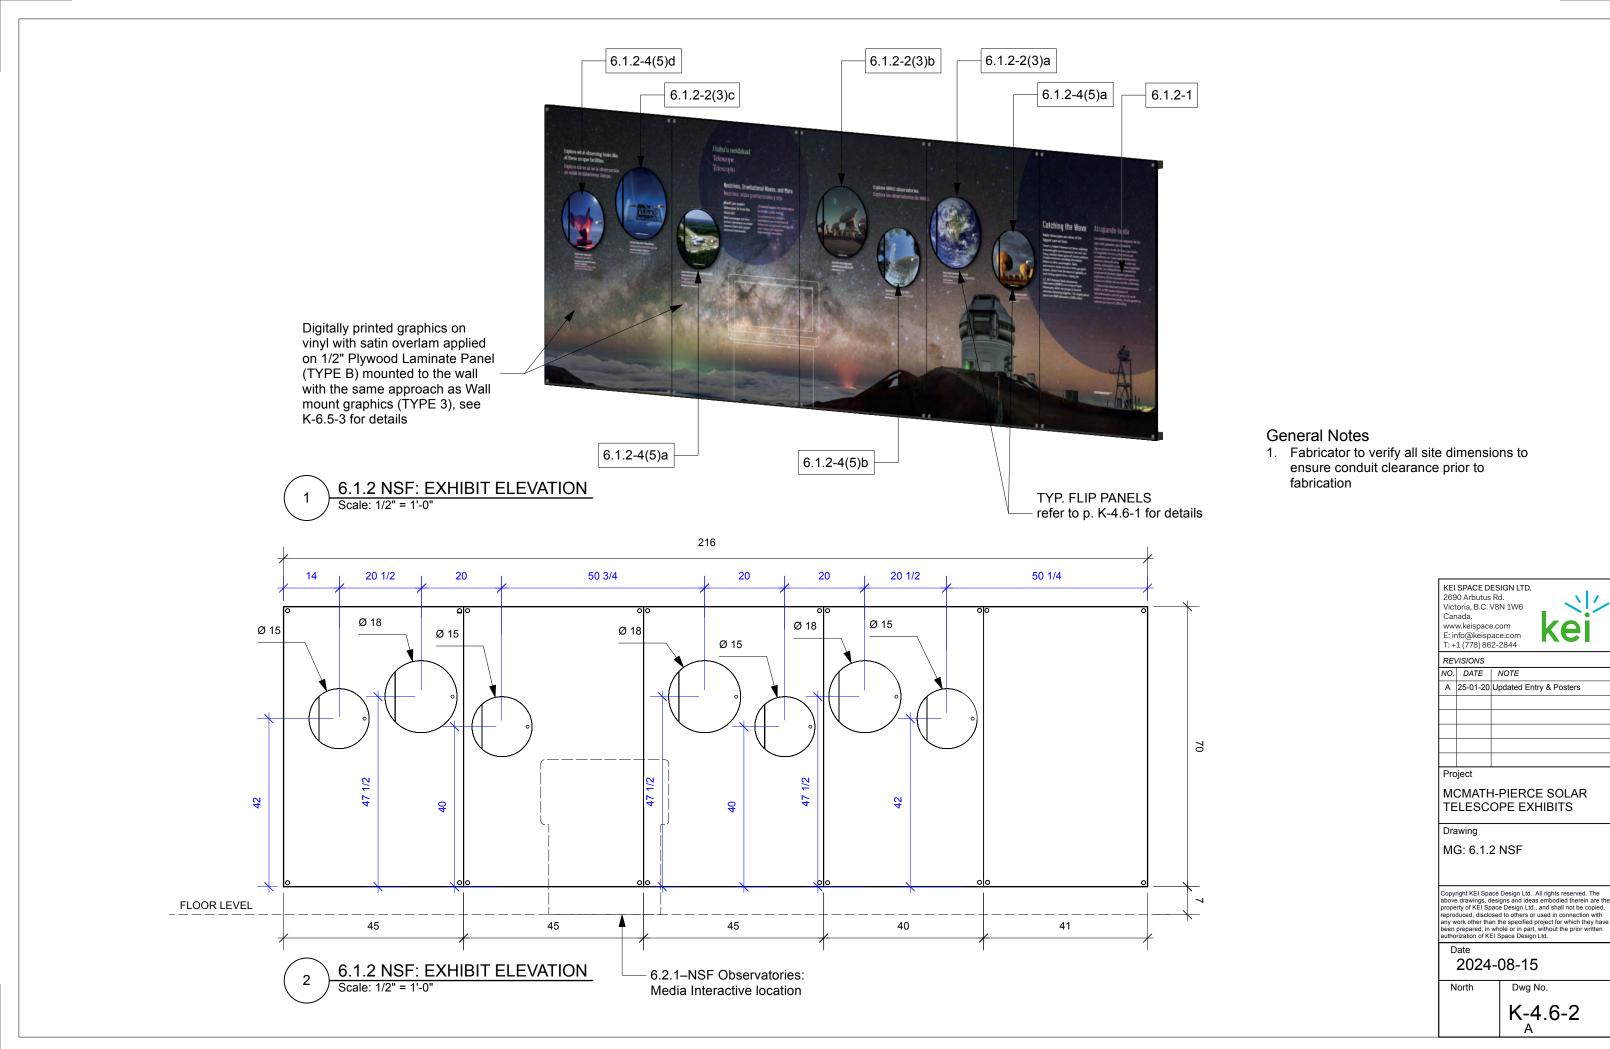


7.6.1 SPECTROSCOPY : EXTENED PLAN
Scale: 3/4" = 1'-0"

7.6.1 SPECTROSCOPY : ELEVATION
Scale: 3/4" = 1'-0"

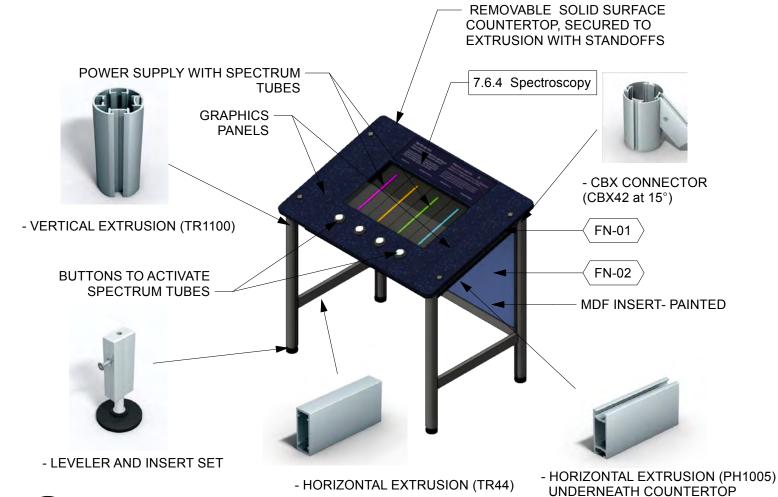

4 7.6.1 SPECTROSCOPY : OVERVIEW
Scale: 3/4" = 1'-0"

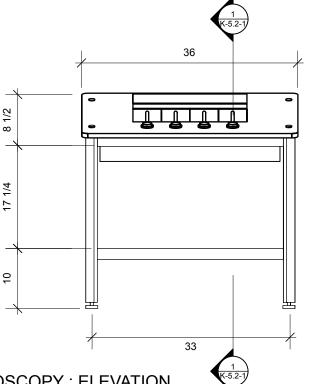



Tube Power Supply and Gas Spectrum analysis tubes could be sourced from: https://www.arborsci.com/products/spect rum-analysis

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CR: 7.6.1 SPECTROSCOPY

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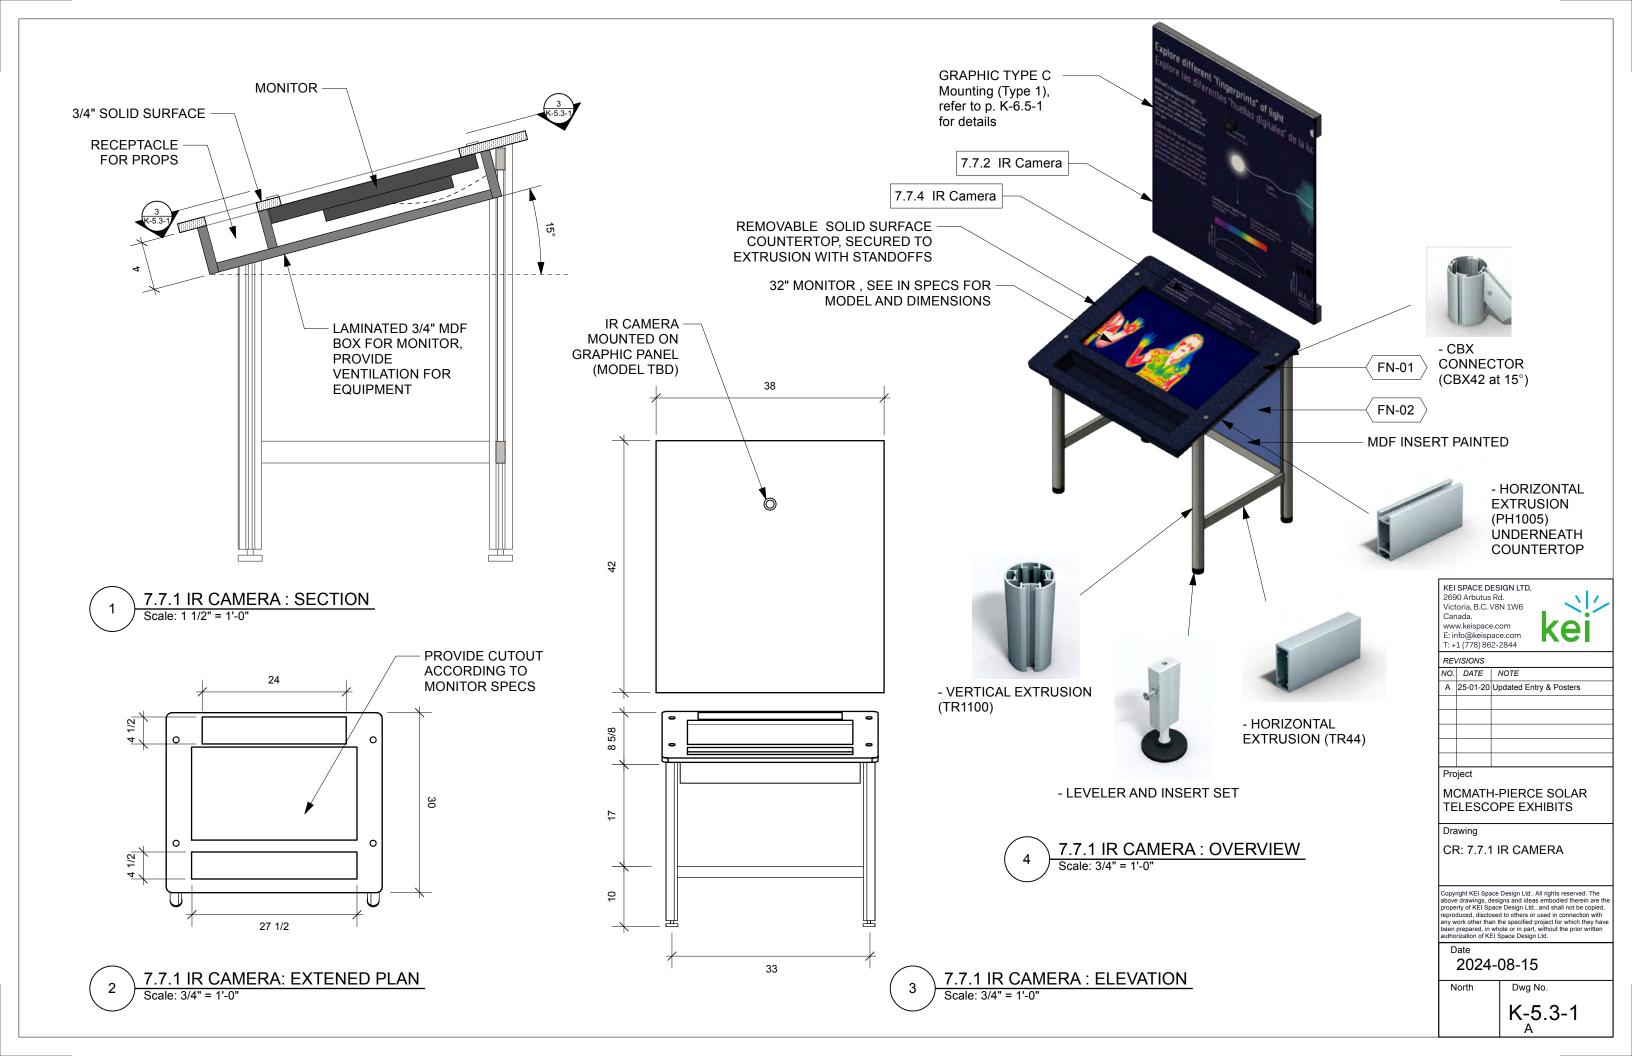
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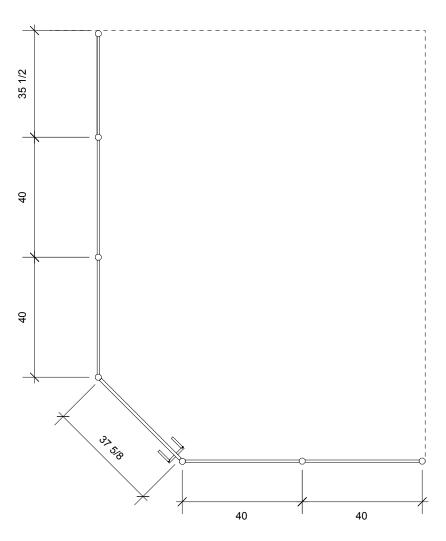
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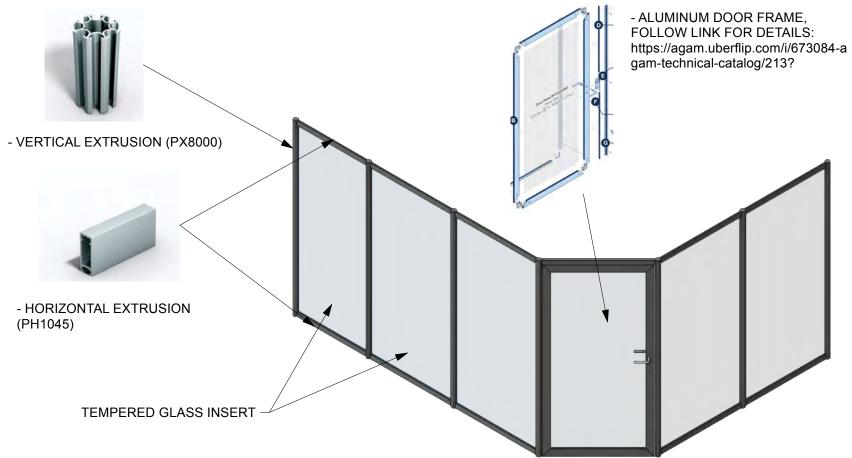
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Dwg No.


K-5.2-1







7.9.4 PARTITION WALL: EXHIBIT PLAN
Scale: 3/8" = 1'-0"

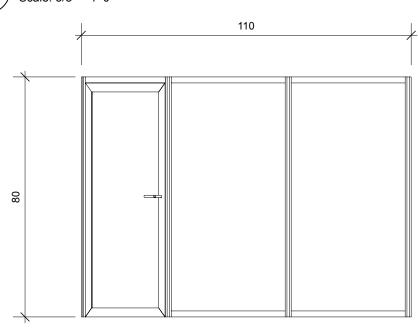

4 Scale: 3/8" = 1'-0"

144 1/2

7.9.4 PARTITION WALL: OVERVIEW

3 7.9.4 PARTITION WALL: SIDE VIEW
Scale: 3/8" = 1'-0"

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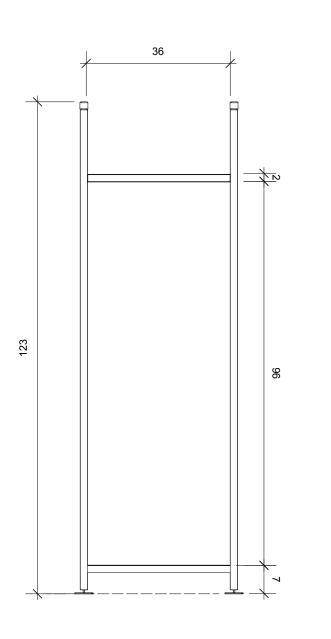
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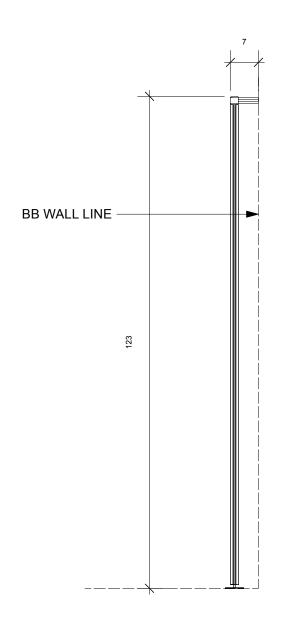
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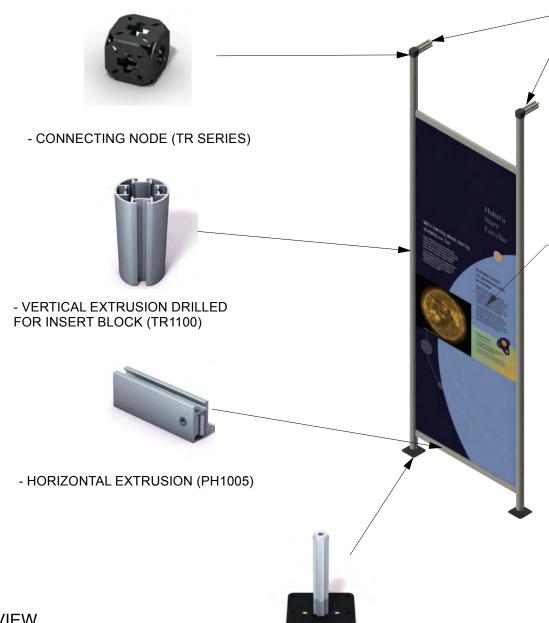
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7.9.4 PARTITION WALL: ELEVATION








1 TYPICAL FLOATING GRAPHIC: ELEVATION
Scale: 1/2" = 1'-0"

2 TYPICAL FLOATING GRAPHIC: SIDE VIEW
Scale: 1/2" = 1'-0"

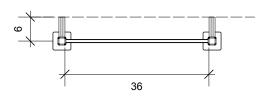

3 TYPICAL FLOATING GRAPHIC: PLAN
Scale: 1/2" = 1'-0"

	EXHIBIT			
1	5.2.2 What are Stars?			
2	5.6.2 What does the Sun look like?			
3	5.8.2 Spectroscopy & Star Composition			
4	5.9.2 Life Cycle of a Stars			
5	5.10.2 Our Solar System isn't Unique			
6	5.11.2 What Does Earth 2.0 Look Like?			
7	5.13.2 Exoplanets & Search for Life			
8	7.8.1 You are Here: Tunnel above			

4

TYPICAL FLOATING GRAPHIC: OVERVIEW

Scale: 1/2" = 1'-0"

- MOUNTING PLATE SECURED TO FLOOR

WITH BOLTS

## **General Notes**

 Extrusions and accessories AGAM or similar, could be sources from: https://www.agam.com/extrusio ns-and-accessories/ KEI SPACE DESIGN LTD. 2690 Arbutus Rd. Victoria, B.C. V8N 1W6 Canada.

- HORIZONTAL EXTRUSION + CONNECTORS

GRAPHIC TYPE C

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KLVISIONS				
NO.	DATE	NOTE		
Α	25-01-20	Updated Entry & Posters		

### Project

MCMATH-PIERCE SOLAR TELESCOPE EXHIBITS

#### Drawin

TYPICALS: FLOATING GRAPHIC PANEL

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Date


2024-08-15


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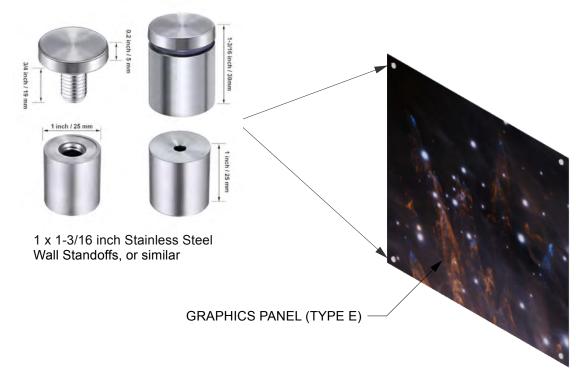
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K-6.1-1


EXHIBIT	LOCATION	QUANTITY
2.3 Photo posters	LOBBY	4
3.2 Photo posters	THEATER	9
6.3.1 The Mirrors Above	MAIN GALLERY	1
7.12 Photo posters	CONTROL ROOM	3
8.4 Photo posters	ASTROLAB	6
9.1 Photo posters	sos	12





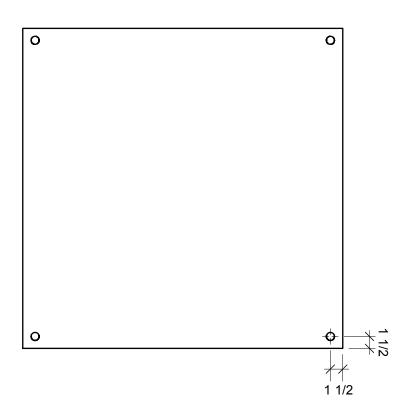

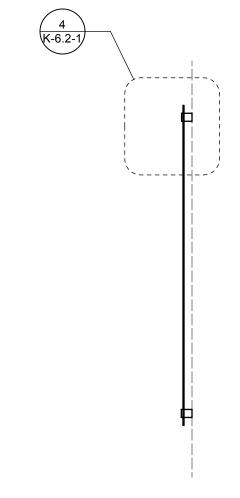TYPICAL GRAPHICS POSTER: OVERVIEW

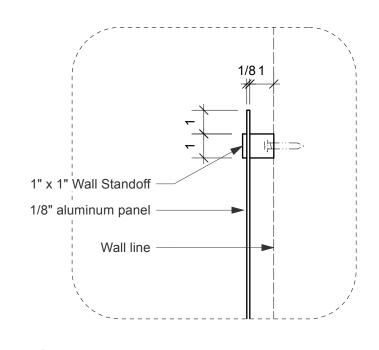

TYPICAL GRAPHICS POSTER: ELEVATION
Scale: 1" = 1'-0" TYPICAL GRAPHICS POSTER: SIDE VIEW Scale: 1" = 1'-0"

## **General Notes**

1. Fabricator to verify all site dimensions to confirm location and ensure conduit clearance where applicable prior to fabrication

TYPICAL GRAPHICS POSTER: DETAIL Scale: 3" = 1'-0"

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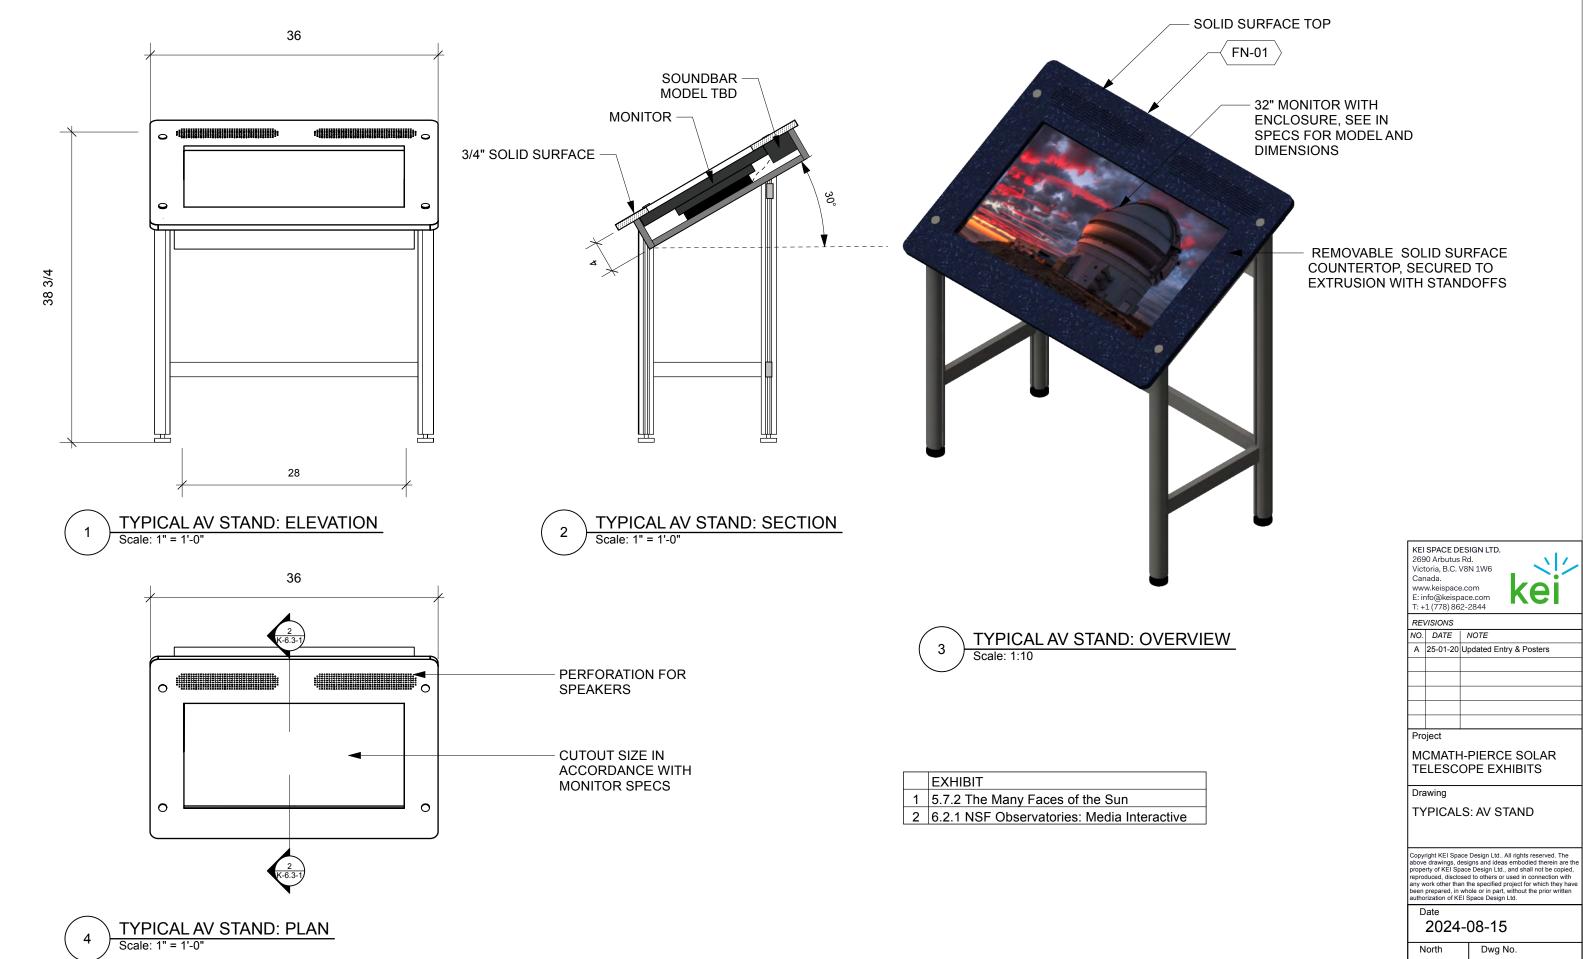
TYPICALS: POSTER

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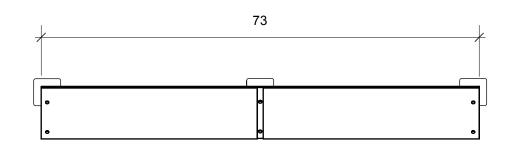
2024-08-15

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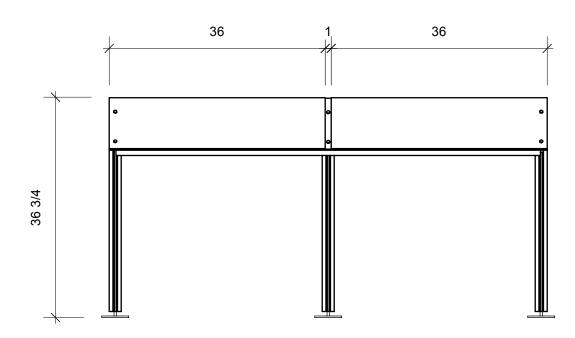
K-6.2-1




K-6.3-1



TYPICAL GRAPHICS HOLDER (TYPE 1): PLAN



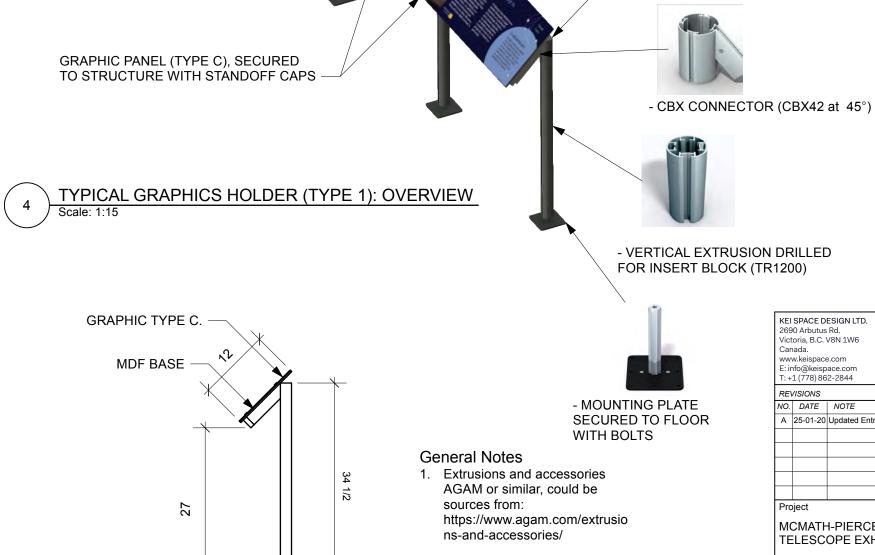

EXHIBIT

1 4.1.2 Studying the Moon 1 4.1.3 Studying the Moon

2 4.2.2 Construction on the Mountain 2 4.2.3 Construction on the Mountain

- HORIZONTAL EXTRUSION +

**CONNECTORS** 

TYPICAL GRAPHICS HOLDER (TYPE 1): ELEVATION
Scale: 3/4" = 1'-0"

TYPICAL GRAPHICS HOLDER (TYPE 1): SIDE VIEW Scale: 3/4" = 1'-0"

- STANDOFF CAP 20

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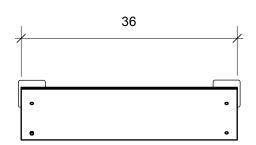
- ALUMINUM END CUP (370 190)

TYPICALS: GRAPHICS HOLDER (TYPE 1)


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TYPICAL GRAPHICS HOLDER (TYPE 2): PLAN Scale: 3/4" = 1'-0"



TYPICAL GRAPHICS HOLDER (TYPE 2): OVERVIEW Scale: 1:15

- STANDOFF CAP 20

GRAPHIC PANEL (TYPE C), SECURED TO STRUCTURE WITH STANDOFF CAPS -

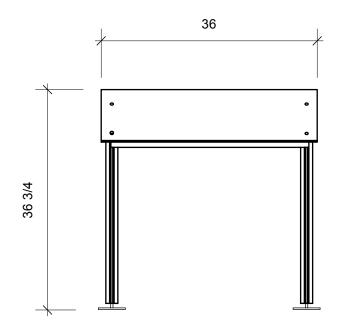VINYL GRAPHIC ON ACRYLIC PANEL MDF BASE 27

FOR INSERT BLOCK (TR1200)

- MOUNTING PLATE

WITH BOLTS

SECURED TO FLOOR

- HORIZONTAL EXTRUSION +

CONNECTORS

**General Notes** 

1. Extrusions and accessories AGAM or similar, could be sources from: https://www.agam.com/extrusio ns-and-accessories/

	EXHIBIT
1	7.9.1 Heliostats Operations Center
2	7.9.2 Heliostats Operations Center
3	7.11.1 Computer Room Interpretation
4	7.11.2 Computer Room Interpretation

TYPICAL GRAPHICS HOLDER (TYPE 2): ELEVATION

TYPICAL GRAPHICS HOLDER (TYPE 2): SIDE VIEW Scale: 3/4" = 1'-0"

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- CBX CONNECTOR (CBX42 at 45°)

- ALUMINUM END CUP (370 190)

- VERTICAL EXTRUSION DRILLED

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MCMATH-PIERCE SOLAR TELESCOPE EXHIBITS

TYPICALS: GRAPHICS HOLDER (TYPE 2)

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